

STREET DIRECTORY (www.street-directory.com.au)

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Artist Impression

AERIAL PHOTOGRAPH (maps.six.nsw.gov.au)

	BED 1	BED 2	BED 3	TOTAL
GROUND FLOOR	3	3	2	
GROUND FLOOR	37.5%	37.5%	25%	8
FIRST FLOOR	4	5	2	
FIRST FLOOR	36.3%	45.5%	18.2%	11
	3	6	2	11
SECOND FLOOR	27.3%	54.5%	18.2%	
	2	4	1	7
THIRD FLOOR	28.6%	57.1%	14.3%	
FOURTH FLOOR	0	4	1	5
	-	80%	10%	

TOTAL NUMBER OF UNITS (INCLUDING 1 BED, 2 BED & 3 BED)= 42 =100%


TOTAL NUMBER OF 1 BED UNITS= 12 = 28.6% OF TOTAL UNITS TOTAL NUMBER OF 2 BED UNITS= 22 = 52.4% OF TOTAL UNITS TOTAL NUMBER OF 3 BED UNITS= 8 = 19.0% OF TOTAL UNITS

AERIAL PHOTOGRAPH - 1943(maps.six.nsw.gov.au)

## ARCHITECTURAL DRAWINGS


Project#	DWG#	TITLE	SCALE	ISSUE	DATE
1919	00	COVER PAGE		4	03/20
	01	ADG COMPLIANCE SUMMARY		2	03/20
	02	SITE ANALYSIS PLAN		4	03/20
	03	BASEMENT TWO PLAN			
	04	BASEMENT ONE PLAN		2	03/20
	05	GROUND FLOOR PLAN		4	03/20
	06	FIRST FLOOR PLAN		4	03/20
	07	SECOND FLOOR PLAN		4	03/20
	08	THIRD FLOOR PLAN		4	03/20
	09	FOURTH FLOOR PLAN		4	03/20
	10	ROOF PLAN		4	03/20
	11	ELEVATIONS		4	03/20
	12	SECTIONS		3	03/20
	13	DIAGRAM - GFA		2	03/20
	14	DIAGRAM - SOLAR ACCESS			
	15	DIAGRAM- LANDSCAPE & COVERAGE		2	01/20
	16	DIAGRAM- SHADOW ANALYSIS 1 OF 4		2	03/20
	17	DIAGRAM- SHADOW ANALYSIS 2 OF 4		2	03/20
	18	DIAGRAM- SHADOW ANALYSIS 3 OF 4		2	03/20
	19	DIAGRAM- SHADOW ANALYSIS 4 OF 4		2	03/20
	20	DIAGRAM- COMMUNAL OPEN SPACE		3	03/20
	21	DIAGRAM- CROSS VENTILATION		2	01/20
	22	FINISHES SCHEDULE			
	23	WINDOW AND DOOR SCHEDULE			
	24	ADAPTABLE HOUSING			
	25	PERSPECTIVES		3	03/20
	26	EXISTING HOUSE SHADOW DIAGRAM		1	01/20
	27	DIAGRAM- PRIVATE OPEN SPACE		1	03/20

03 SITTING	OBJECTIVES	DESIGN CRITERIA	PROPOSED	COMPLIANCE		OBJECTIVES	DESIGN CRITERIA	PROPOSED (	COMPLIANCE	
3D Communal and public open space	3D-1 An adequate area of communal open space is provided to enhance residential amenity and to	Communal open space has a minimum area equal to 25% of the site	36.4%			Every habitable room must have total minimum glass area of not of the room. Daylight and air ma rooms	less than 10% of the floor area	COMPLIES		DEREK RAITHBY ARCHITECTU LEVEL 2, 57 RENWICK STREI LEICHHARDT NSW 20 T: (02) 9518 3563 ABN:616131740 - info@derekraithby.com.au Architect #2
3E Deep soil	provide opportunities for landscaping 3E-1 Deep soil zones provide	7% of the site area			-	4D-2 Environmental performance of the apartment is maximised	Habitable room depths are limited to a maximum of 2.5 x the ceiling height	CAN COMPLY		DO NOT SCALE OFF DRAWINGS. WORK TO FIGURED DIMENSIONS ALL DIMENSIONS ARE TO BE CONFIRMED ON SITE PRIOR TO COMMENCEM WORK. REPORT ANY DISCREPANCIES TO THE ARCHITECT. NOMINATED ARD DEREK RAITHBY REG: 7469 COPYRIGHT DRA (AUS) PTY LTD
zones	areas on the site that allow for and support healthy plant and tree growth. They improve residential amenity		27%			In open plan layouts (where the combined) the maximum habita window		CAN COMPLY		
	and promote management of water and air quality				-	4D-3 Apartment layouts are designed to accommodate a variety	Bedrooms have minimum areaBedroom typeMin. areaMasterAn. area	of		
3F Visual privacy	3F-1 Adequate building separation distances are shared equitably between	Building heighthabitable rooms & balconiesNon -habitable roomsUp to 12m6m3m				of household activities and needs	Master bedroom10m²3mother bedroom9m²3m(both measurement excluding wardrobe space)	COMPLIES		
	neighbouring sites, to achieve reasonable levels of external and internal visual privacy	Op to 1211 (4 storeys)6m3mUp to 25m (5-8 storeys)9m4.5mOver 25m (9+ storeys)12m6m	COMPLIES				Living rooms or combined living/dining rooms have a minimum width of:			
3J Bicycle and car parking	3J-1 Car parking is provided based on proximity to public	Within 800m to rail station or light rail stop, car parking needs			-		Studio & 1 br3.6m2br & 3 br4m	COMPLIES		
	transport in metropolitan Sydney and centres in regional areas	in Guide to Traffic Generating Developments apply	60m		4E Private open space and	private open space and	Dwelling typeMin. POS areaMin. POS areaStudio4m²-1br8m²2m	COMPLIES		
04 DESIGNING					balconies	balconies to enhance residential amenity	2br 10m <sup>2</sup> 2m			
daylight access	4A-1 To optimise the number of apartments receiving sunlight to habitable rooms, primary windows and private	Living rooms and private open spaces of at least 70% of apartments in a building receive minimum of 2 hours direct	ea 88%				3br12m²2.4mThe min balcony depth to be counted as contributing to balcony is 1m			2 03/20 RFI SUBMISSION #   1 11/19 FOR DISCUSSION #   Rev. Date Description #   Client: JRNN PTY LTD C/O DEREK RAITHBY ARCHITECTURE
	open space	sunlight between 9 am and 3 pr at mid-winter	n		-		or on a podium or similar is provided instead of a balcony. It 5m2 and a minimum depth of 3m	COMPLIES		STRUCTURAL ENGINEER Consultant RAFELETOS ZANUTTINI ENGINEER Address LVL 2, 103 VANESSA STREET, SYDI Phone (02) 9554 9311
	A maximum of 15% of apartme sunlight between 9 am and 3 p	nts in a building receive no direct m at mid-winter	12%		4F Commor circulation	• 4F-1 Common circulation	The maximum number of apartments off a circulation	2 CORES		e-mail admin@rafzan.com.au HYDRAULIC ENGINEER Consultant ACOR CONSULTANTS (CC) Address 58 HILLS STREET, GOSFORD 2250
4B Natural ventilation	4B-1 All habitable rooms are naturally ventilated 4B-2 The layout and design	At least 60% of apartments are naturally cross ventilated in the first nine storeys of the building.			and spaces		core on a single level is 8			Phone (02) 4323 3499 e-mail RHamilton@acor.com.au MECHANICAL ENGINEER
	of single aspect apartments maximises natural ventilation 4B-3 The number of	Overall depth of a cross-over or cross-through apartment does not exceed 18m, measured			4G Storage	4G-1 Adequate, well designed storage is provided in each apartment	Minimum volume requirement for storage			Address STREET, BELMORE NSW 2192 Phone (02) 8540 3461 e-mail jsabbouh@rmjengineer.com.au LANDSCAPE DESIGN
	apartments with natural cross ventilation is maximised to create a comfortable indoor environment for residents	glass line to glass line					Dwelling typeStorage size volumeStudio4m³1br6m³2br8m³3br10m³	CAN COMPLY		Consultant CONZEPT LANDSCAPE ARCHITECT Address 101/506 MILLERS STREET,CAMMER 2062 Phone (02) 9922 5312 e-mail rob@conzept.net.au BASIX/ SECTION J
4C Ceiling heights	4C-1 Ceiling height achieves sufficient natural ventilation and daylight access	Habitable rooms 2.7m Non-habitable rooms 2.4m	2.7m 2.4m				At least 50% of storage within the apartment			Consultant Address PARTNERS ENERGY P.O. BOX 185 ALSTONEVILLE 2477 Phone 0421 381 005 e-mail david@partnersenergy.com.au Project: RESIDENTIAL DEVELOPMENT
size and layout	4D-1 The layout of rooms within an apartment is functional, well organised and	Dwelling typeMin. sizeStudio35m²1br50m²	CAN COMPLY		-					36 LONSDALE STREET & 64 - 70 BRENAN STREET, LILYFIELD DRAWING TITLE ADG COMPLIANCE SUMMARY
	provides a high standard of amenity	2br   70m²     3br   90m²								Date:   Drawing No.     Scale:   1 : 1@A1   1:0@A3
		additional bathroom 5m <sup>2</sup> 4 <sup>th</sup> bec	Iroom		-					Scale:   1:10@A3   01     Project No.   1919   01     Drawn/Checked   1919   1000000000000000000000000000000000000

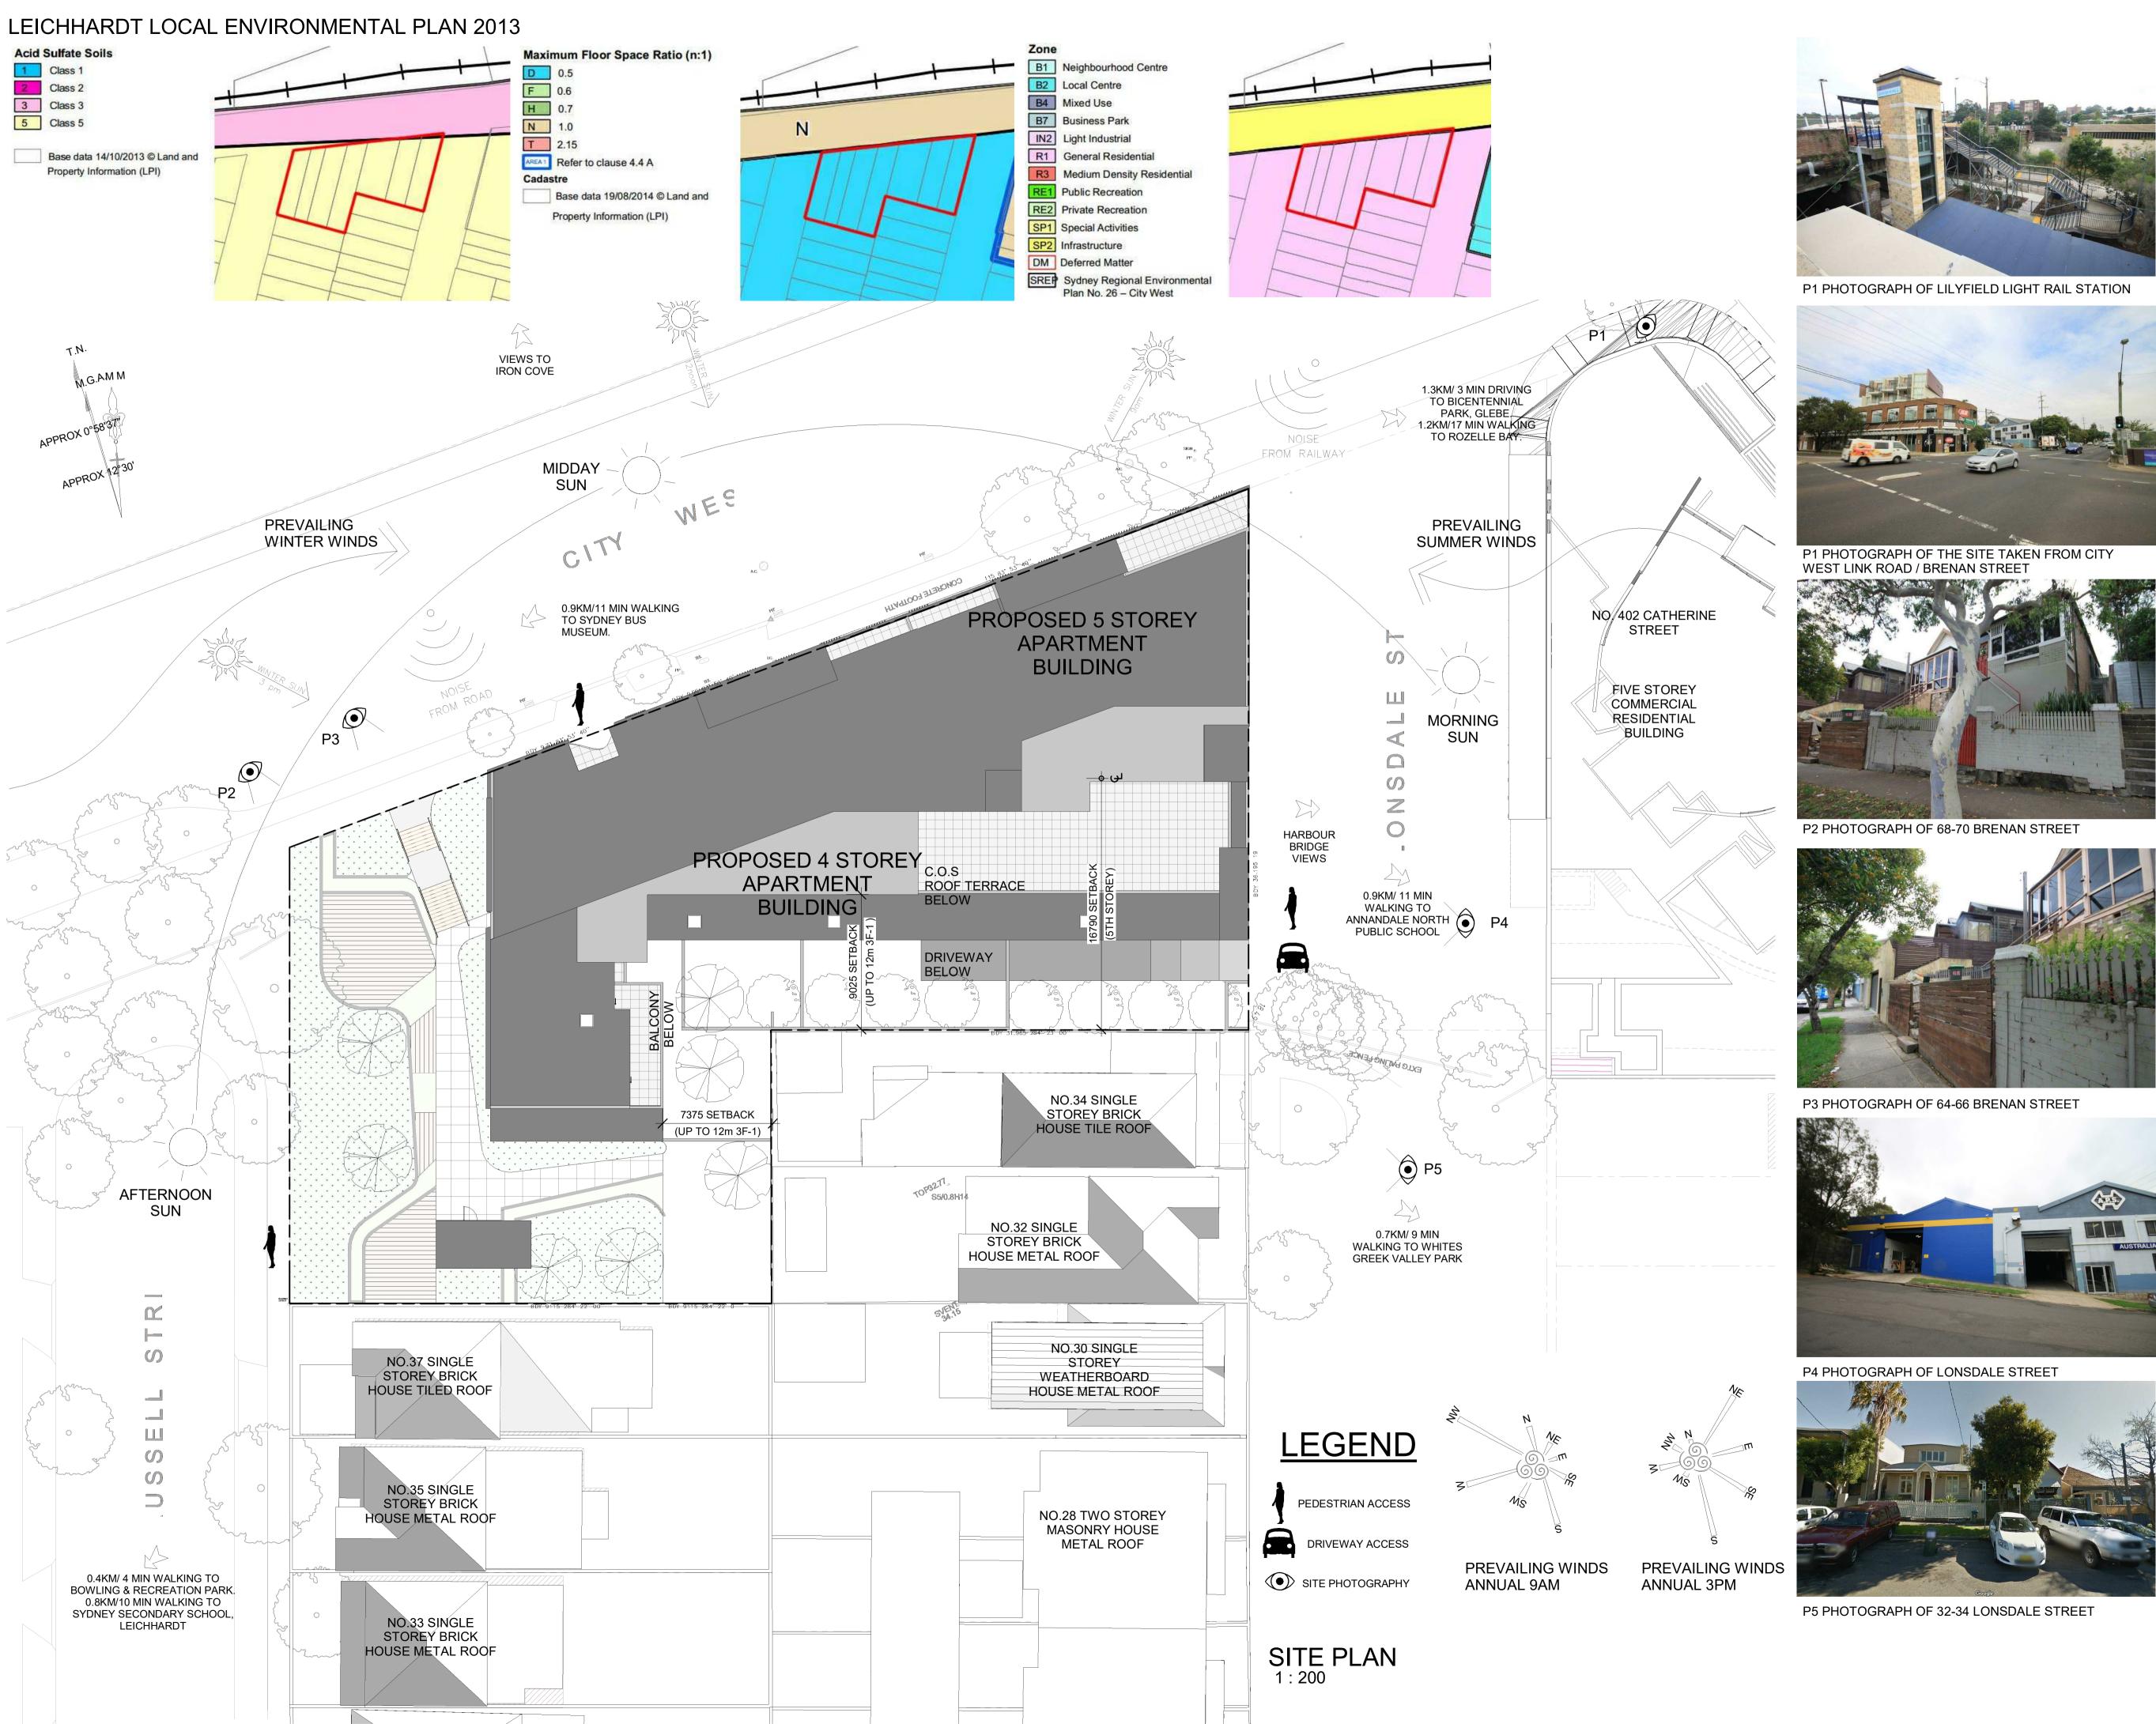



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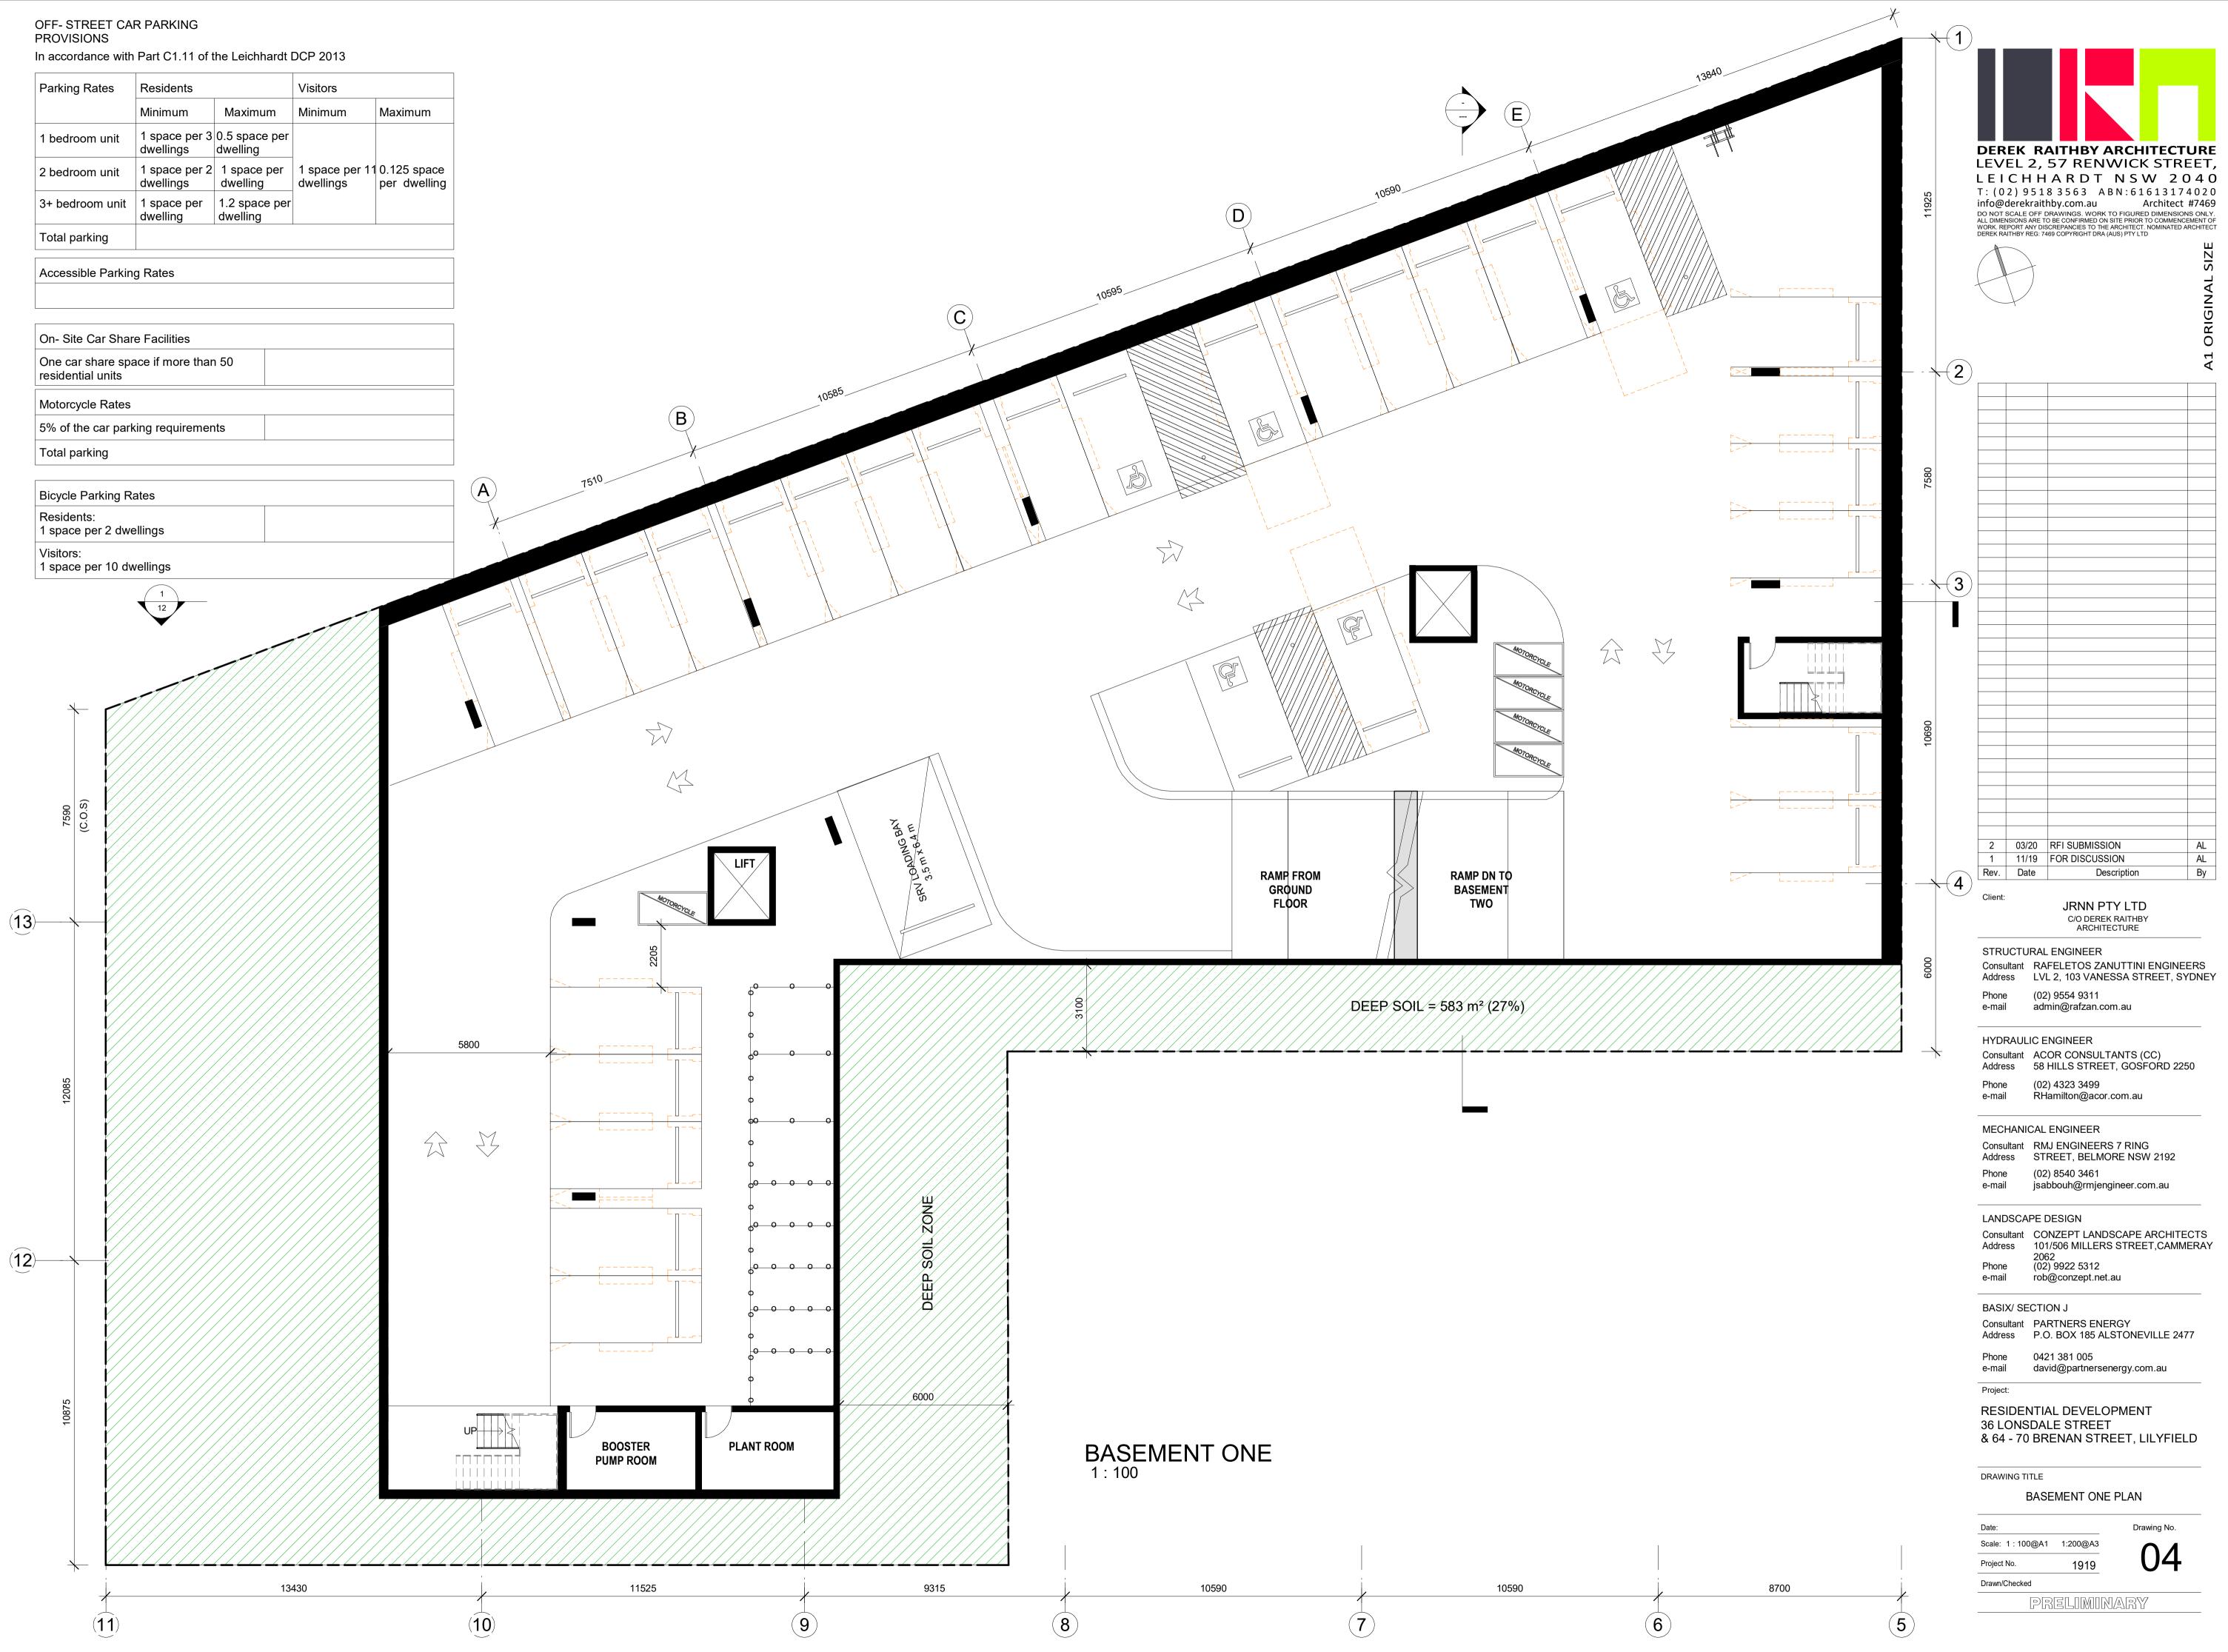
Client:
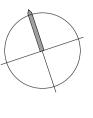
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STRUCTURAL ENGINEER Consultant RAFELETOS ZANUTTINI ENGINEERS Address LVL 2, 103 VANESSA STREET, SYDNEY (02) 9554 9311 Phone admin@rafzan.com.au e-mail HYDRAULIC ENGINEER ConsultantACOR CONSULTANTS (CC)Address58 HILLS STREET, GOSFORD 2250 Phone (02) 4323 3499 RHamilton@acor.com.au e-mail MECHANICAL ENGINEER Consultant RMJ ENGINEERS 7 RING Address STREET, BELMORE NSW 2192 Phone (02) 8540 3461 e-mail jsabbouh@rmjengineer.com.au LANDSCAPE DESIGN Consultant CONZEPT LANDSCAPE ARCHITECTS Address 101/506 MILLERS STREET,CAMMERAY 2062 (02) 9922 5312 Phone e-mail rob@conzept.net.au BASIX/ SECTION J Consultant PARTNERS ENERGY Address P.O. BOX 185 ALSTONEVILLE 2477 0421 381 005 Phone david@partnersenergy.com.au e-mail Project: RESIDENTIAL DEVELOPMENT 36 LONSDALE STREET & 64 - 70 BRENAN STREET, LILYFIELD DRAWING TITLE SITE ANALYSIS PLAN Date: Drawing No. Scale: As indicated@A1 1:0@A3 02 Project No. 1919

PRELIMINARY

Drawn/Checked



# UNIT MIX (GF)

1	20%
2	40%
3	40%
GROUND FLC	DOR
0	

	<b>COMPLIANCE TABLE - GROUND FLOOR</b>					
Name	PROPOSED AREA	SEPP65_Solar Access	SEP65_Cross Ventilation			
U1	99 m²	Yes	Yes			
U2	66 m²	Yes	No			
U3	95 m²	No	No			
U4	50 m²	No	Yes			
U5	50 m²	Yes	Yes			
U6	75 m²	Yes	Yes			
U7	75 m²	Yes	No			
U8	75 m²	Yes	No			



UNIT MIX (FF)				
BEDROOMS	Unit Mix			

1	20%
2	50%
3	30%
LEVEL ONE	I
11	

	COMPLIAN	CE TABLE - FIRS	ST FLOOR
Name	PROPOSED AREA	SEPP65_Solar Access	SEP65_Cross Ventilation
U9	100 m <sup>2</sup>	Yes	Yes
U10	66 m²	Yes	No
U11	58 m²	Yes	Yes
U12	75 m²	No	No
U13	75 m²	No	No
U14	50 m²	No	Yes
U15	110 m <sup>2</sup>	Yes	Yes
U16	50 m²	Yes	Yes
U17	75 m²	Yes	Yes
U18	75 m²	Yes	No
U19	75 m²	Yes	No



UNIT MIX (SF)				
BEDROOMS	Unit Mix			
1	15%			
2	70%			
3	15%			
LEVEL TWO				
11				

<b>COMPLIANCE TABLE - SECOND FLOOR</b>					
Name	PROPOSED AREA	SEPP65_Solar Access	SEP65_Cross Ventilation		
U20	100 m²	Yes	Yes		
U21	66 m²	Yes	No		
U22	81 m²	Yes	Yes		
U23	75 m²	No	No		
U24	75 m²	No	No		
U25	50 m²	No	Yes		
U26	97 m²	Yes	Yes		
U27	50 m²	Yes	Yes		
U28	75 m²	Yes	Yes		
U29	75 m²	Yes	No		
U30	75 m²	Yes	No		



UNIT MIX (3F)				
BEDROOMS	Unit Mix			
1	15%			
2	62%			
3	23%			
LEVEL THREE				
7				


<b>COMPLIANCE TABLE - THIRD FLOOR</b>					
NamePROPOSED AREASEPP65_Solar AccessSEP65_Cross Ventilation					
U31	100 m²	Yes	Yes		
U32	66 m²	Yes	Yes		
U33	54 m²	No	Yes		
U34	70 m²	Yes	Yes		
U35	75 m²	Yes	Yes		
U36	75 m²	Yes	Yes		
U37	75 m²	Yes	Yes		



UNIT MIX (4F)			
BEDROOMS Unit Mix			
73%			
27%			


<b>COMPLIANCE TABLE - FOURTH FLOOR</b>					
PROPOSEDSEPP65_SolarSEP65_CrossNameAREAAccessVentilation					
U38	89 m²	Yes	Yes		
U39	75 m²	Yes	Yes		
U40	75 m²	Yes	Yes		
U41	75 m²	Yes	Yes		
U42	114 m²	Yes	Yes		



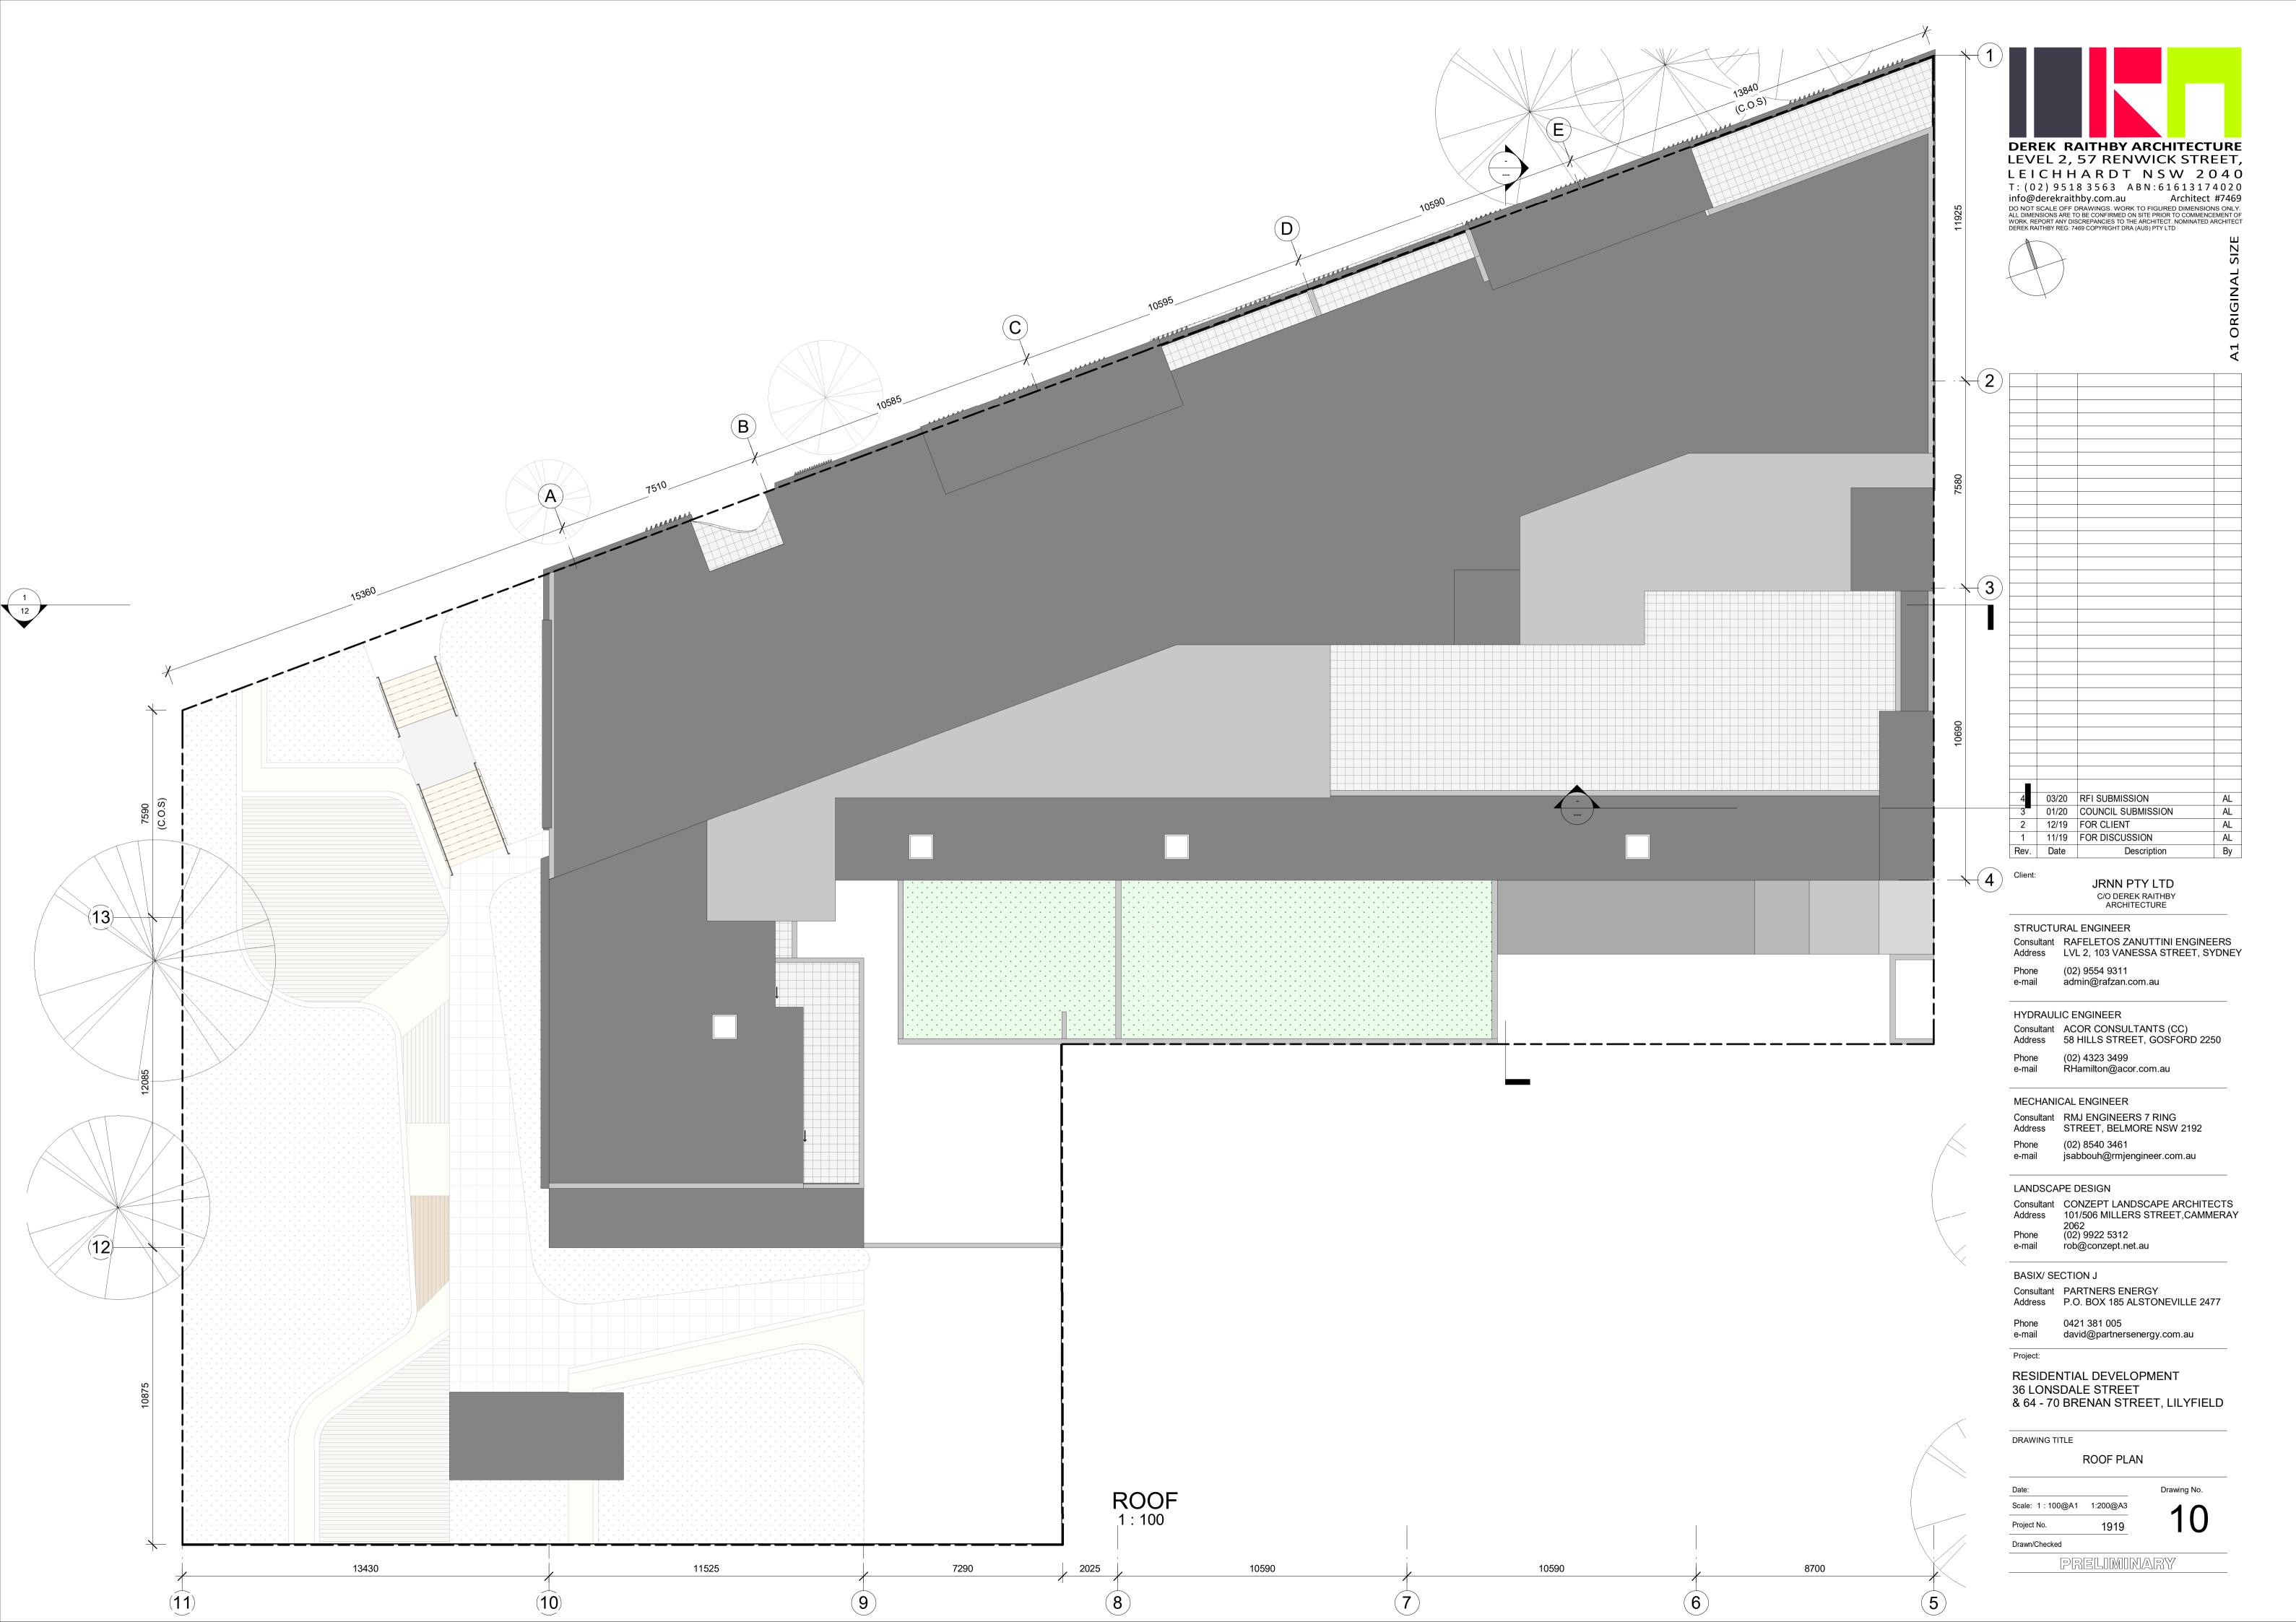




# North Elevation

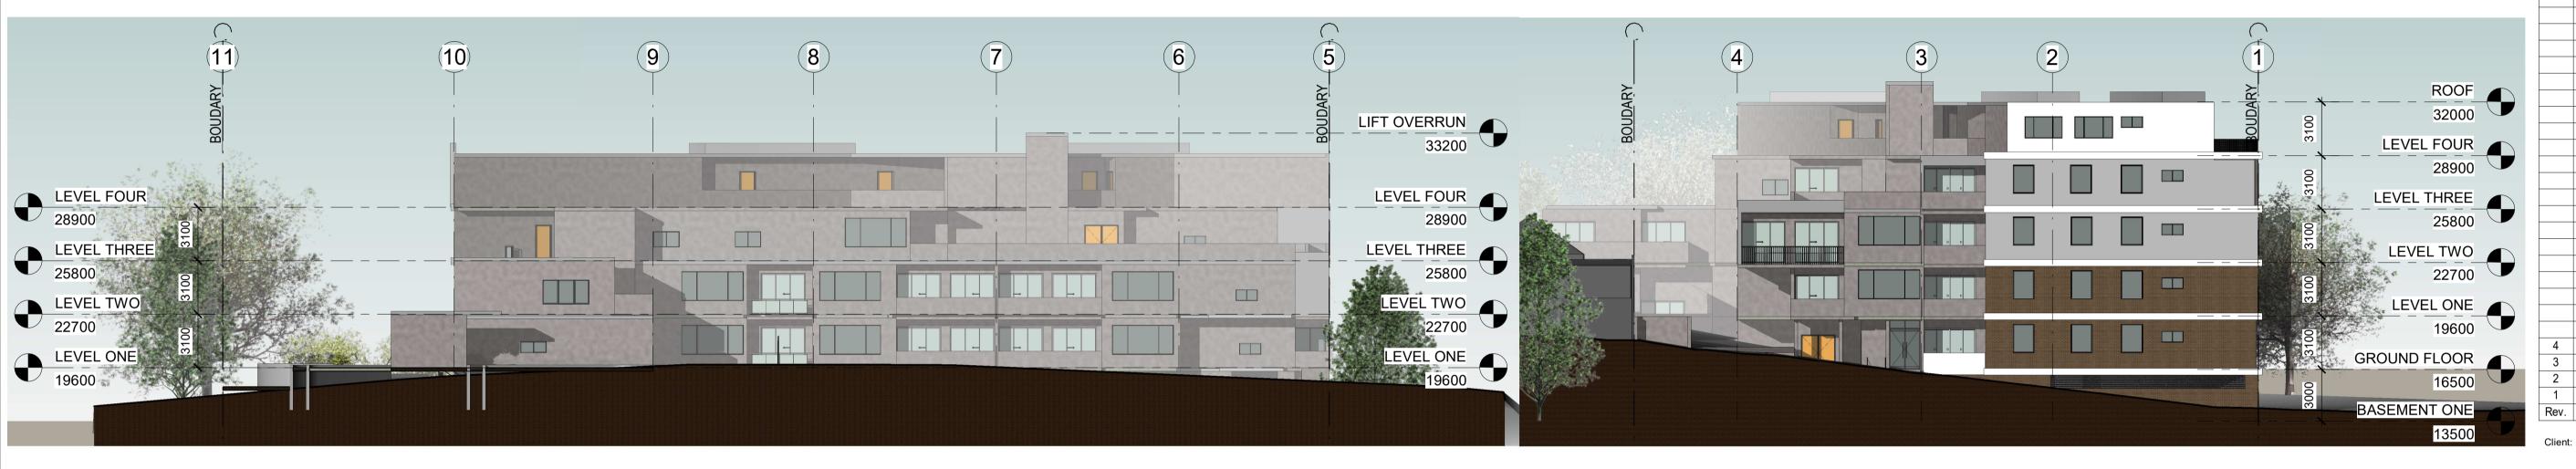

# South Elevation

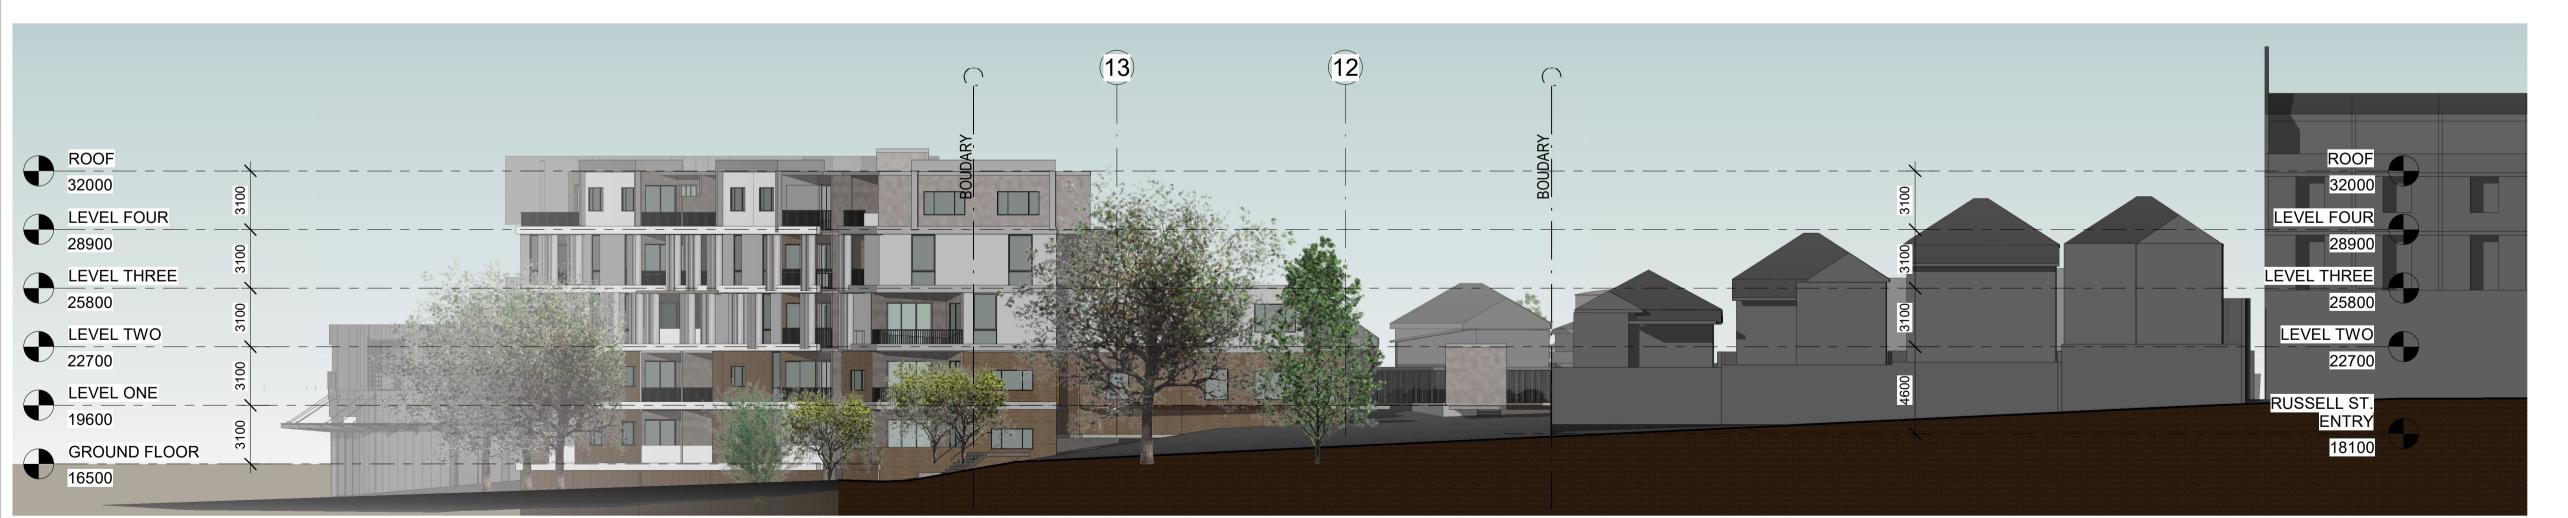

West Elevation

East Elevation




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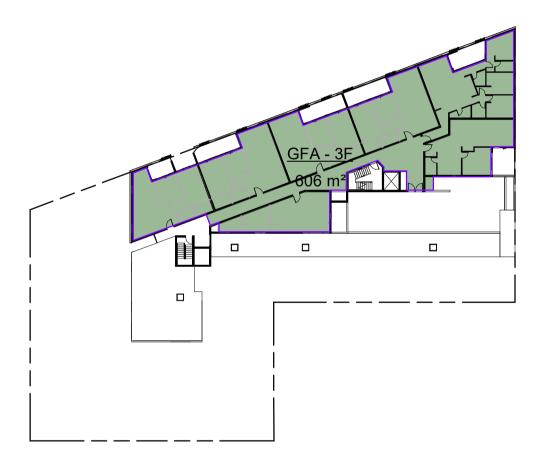
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Phone e-mail	(02) 4323 3499 RHamilton@acor.com.au
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Phone e-mail	(02) 8540 3461 jsabbouh@rmjengineer.com.au
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BASIX/ SE	ECTION J
• • • • • • • • • • • • • • • • • • • •	PARTNERS ENERGY P.O. BOX 185 ALSTONEVILLE 2477
Phone e-mail	0421 381 005 david@partnersenergy.com.au
Project:	
36 LONS	NTIAL DEVELOPMENT DALE STREET BRENAN STREET, LILYFIELD
DRAWING T	ITLE
	SECTIONS
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Project No.	1919
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GFA Diagram - Ground Floor Plan





GFA Diagram - Third Floor Plan

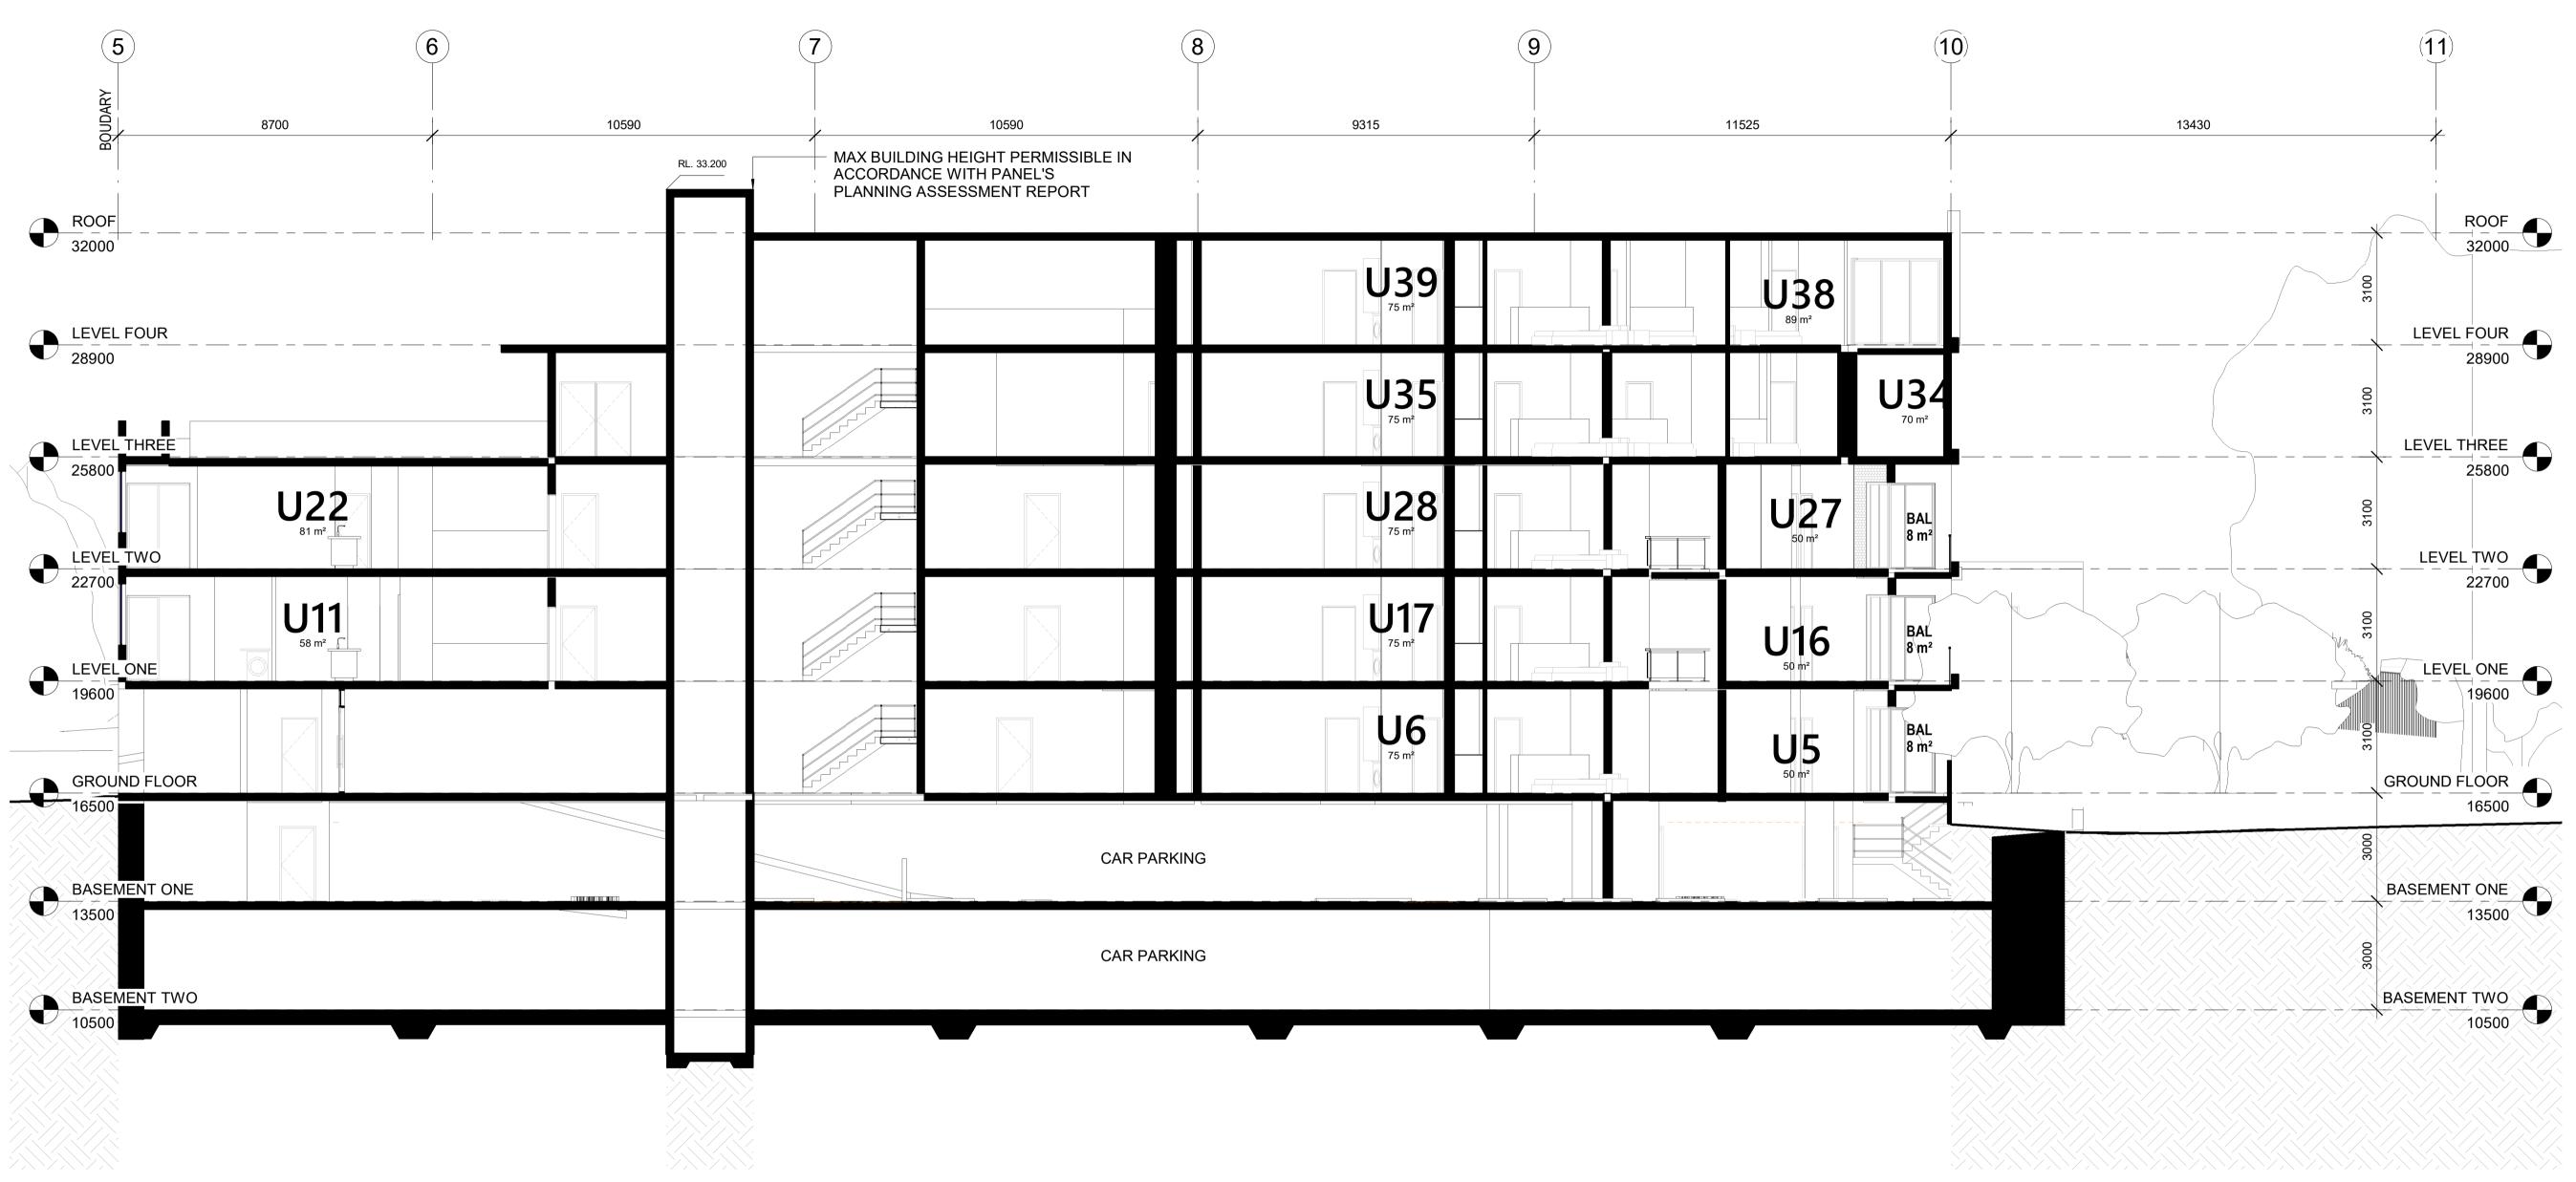

GFA Diagram - First Floor Plan



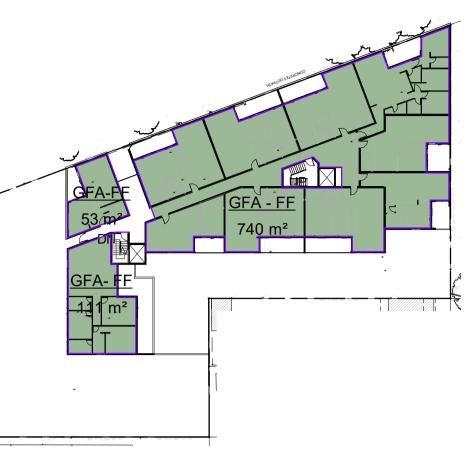

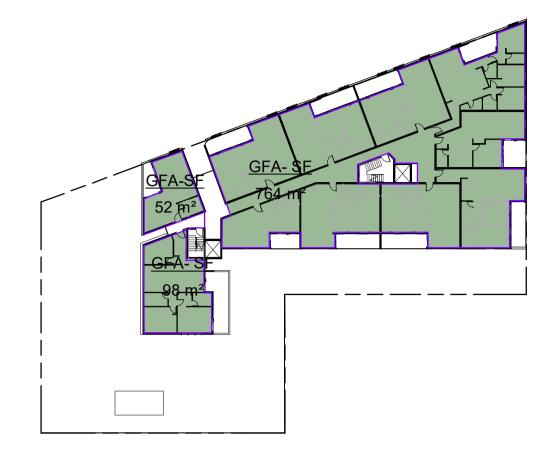

# GFA Diagram - Second Floor Plan

AREA CALCULATION - GROSS FLOOR AREA						
SITE AREA	SITE AREA TOTAL AREA FSR FSR					
2145 m <sup>2</sup>	3568 m²	1.66	2.0			

# \_ \_ \_ \_ \_ \_ \_ \_ \_ \_ \_ \_ \_ \_ \_

GFA Diagram - Fourth Floor Plan

### GROSS FLOOR AREA

means the sum of the floor area of each floor of a building measured from the internal face of external walls, or from the internal face of walls separating the building from any other building, measured at a height of 1.4 metres above the floor, and includes—

(a) the area of a mezzanine, and

(b) habitable rooms in a basement or an attic, and

(c) any shop, auditorium, cinema, and the like, in a basement or attic,

but excludes— (d) any area for common vertical circulation, such as lifts and stairs, and

(e) any basement—

(i) storage, and

(ii) vehicular access, loading areas, garbage and services, and (f) plant rooms, lift towers and other areas used exclusively for mechanical services or ducting, and

(g) car parking to meet any requirements of the consent authority (including access to that car parking),

and


(h) any space used for the loading or unloading of goods (including access to it), and

(i) terraces and balconies with outer walls less than 1.4 metres high, and

(j) voids above a floor at the level of a storey or storey above.



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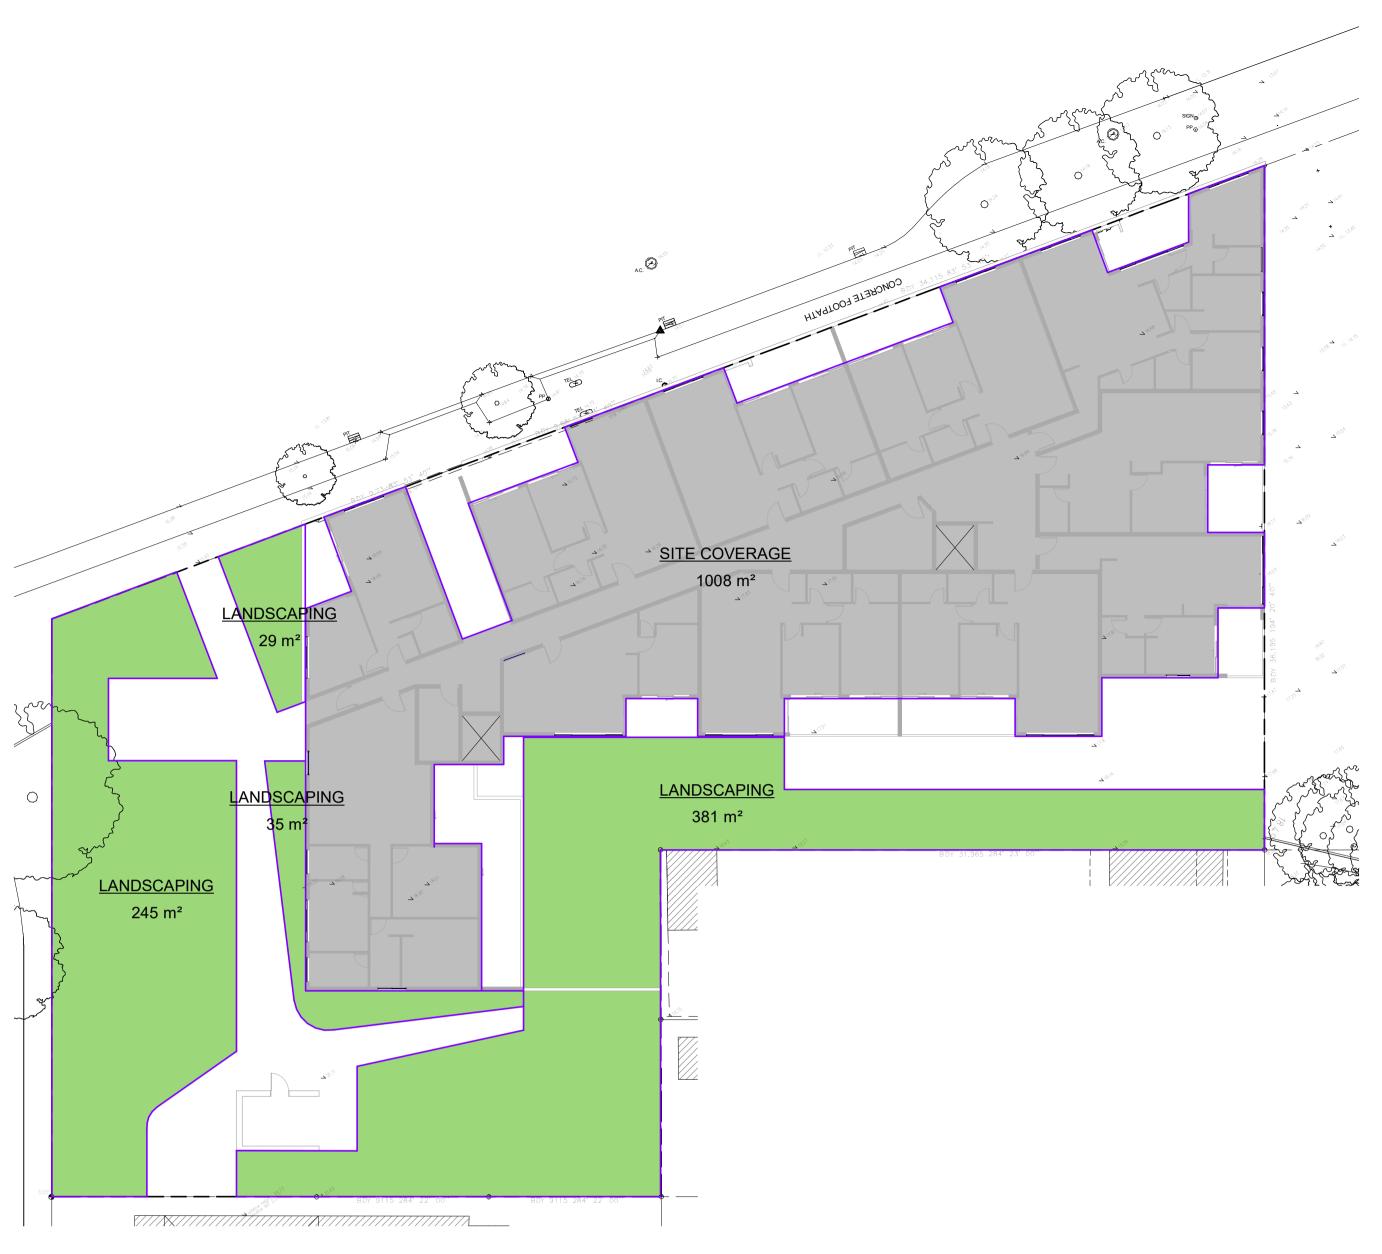

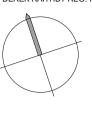
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LANDSCA	PE DESIGN	
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Consultant Address		RGY STONEVILLE 2477
Phone e-mail	0421 381 005 david@partnerse	nergy.com.au
Project:		
36 LONS	NTIAL DEVELC DALE STREET BRENAN STR	
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# Landscaping & Site Coverage Calculation - Level 1

### LEICHHARDT DEVELOPMENT CONTROL PLAN 2013

4.3A LANDSCAPED AREAS FOR RESIDENTIAL ACCOMMODATION IN ZONE R1

(1) The objectives of this clause are as follows— (a) to provide landscaped areas that are suitable for substantial tree planting and for the use and enjoyment of residents,

(b) to maintain and encourage a landscaped corridor between adjoining properties,

(c) to ensure that development promotes the desired future character of the

neighbourhood, (d) to encourage ecologically sustainable development by maximising the retention and absorption of surface drainage water on site and by minimising obstruction to the underground flow of water,

(e) to control site density,

(f) to limit building footprints to ensure that adequate provision is made for landscaped areas and private open space.

(2) This clause applies to development for the purpose of residential accommodation on land in Zone R1 General Residential.

(3) Development consent must not be granted to development to which this clause applies unless—

- (a) the development includes landscaped area that comprises at least—
- (i) where the lot size is equal to or less than 235 square metres—15% of the site area, or

(ii) where the lot size is greater than 235 square metres—20% of the site area, and  $(\dot{b})$  the site coverage does not exceed 60% of the site area.

(4) For the purposes of subclause (3)—

(a) the site area is to be calculated under clause 4.5 (3), and

(b) any area that—

(i) has a length or a width of less than 1 metre, or

(ii) is greater than 500mm above ground level (existing),

is not to be included in calculating the proportion of landscaped area, and

(c) any deck or balcony or the like (whether enclosed or unenclosed) is not to be included in calculating the site coverage if—

(i) it is 2.4 metres or more above ground level (existing), as measured from the underside of the structure and the area below the structure is able to be landscaped or used for recreational purposes, or

(ii) the finished floor level is 500mm or less above ground level (existing).

(a) any basement, (c) any eaves,

Name SITE AF LANDSCA 2145 PING

	SIT
SITE AREA	
2145 m <sup>2</sup>	

Site coverage means the proportion of a site area covered by buildings. However, the following are not included for the purpose of calculating site coverage—

(b) any part of an awning that is outside the outer walls of a building and that adjoins the street frontage or other site boundary,

(d) unenclosed balconies, decks, pergolas and the like.

Landscaped area means a part of a site used for growing plants, grasses and trees, but does not include any building, structure or hard paved area.


**AREA CALCULATION - LANDSCAPE** 

AREA	LANDSCAPE AREA	Total %	DCP REQ.	
5 m²	690 m²	32%	20%	PASS

AREA CALCULATION - SITE COVERAGE				
TE COVERAGE AREA	%	DCP REQ.		
1008 m²	47%	60%	PASS	



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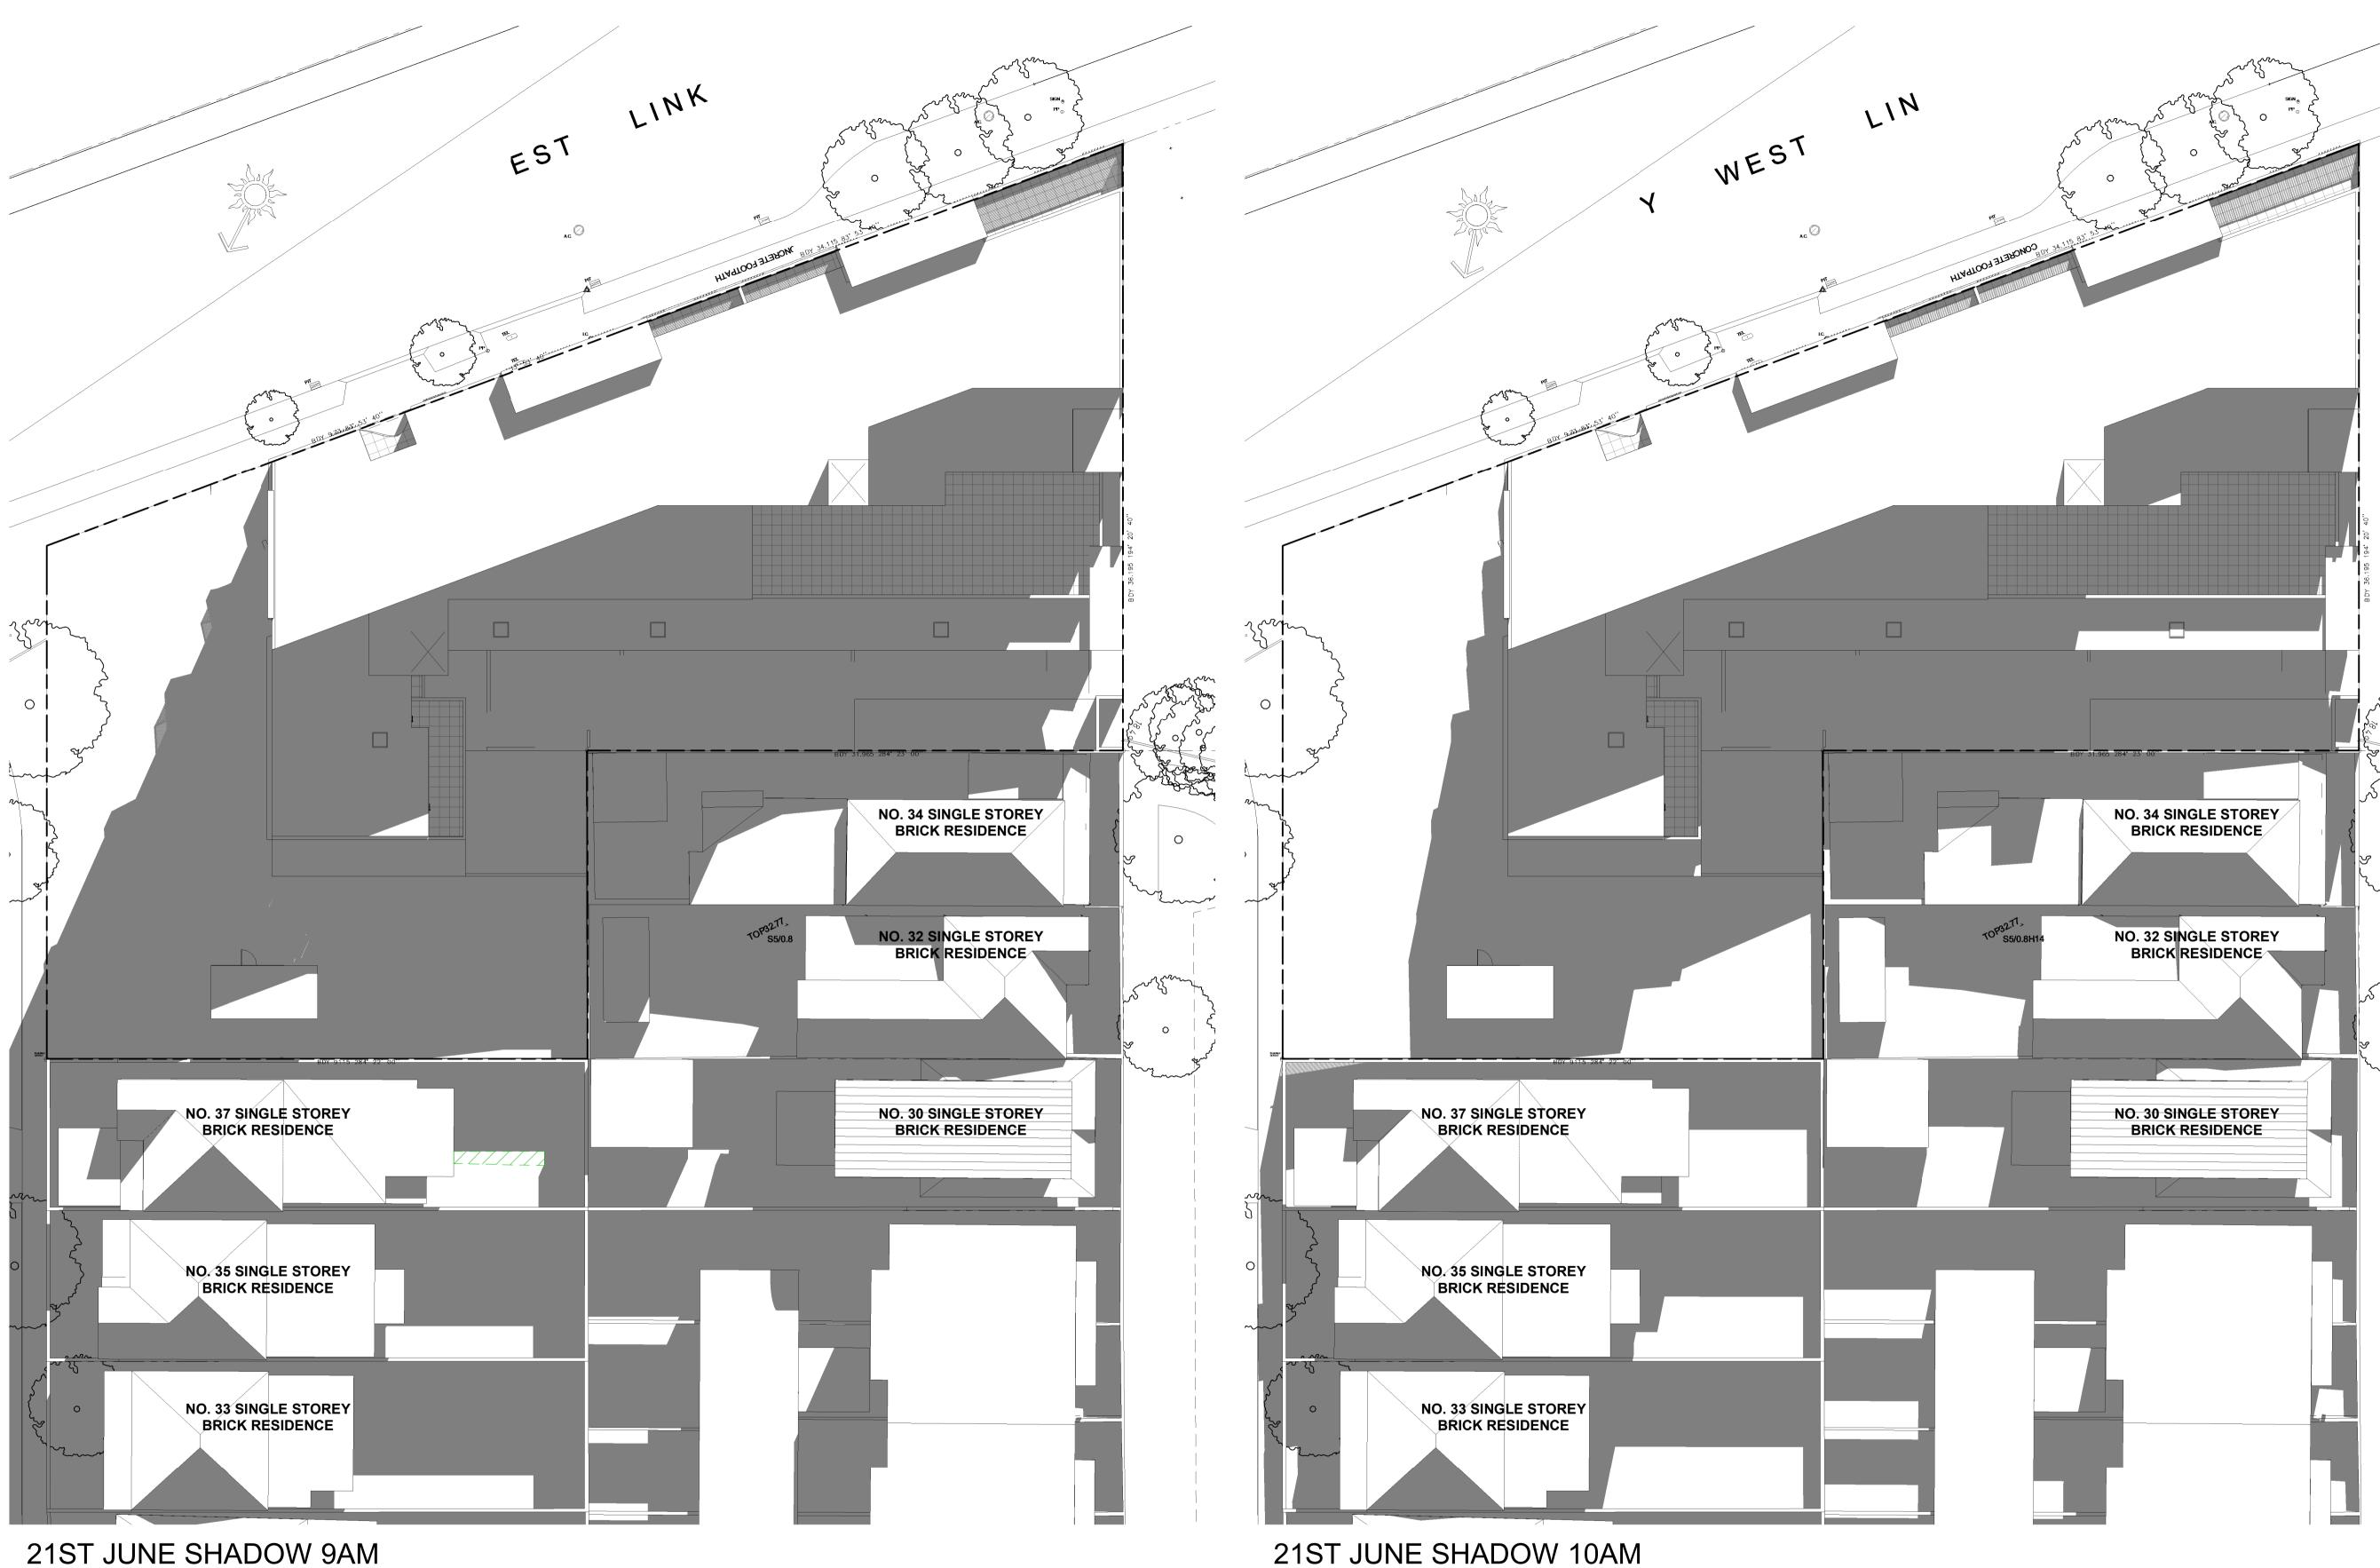
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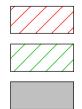
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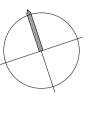
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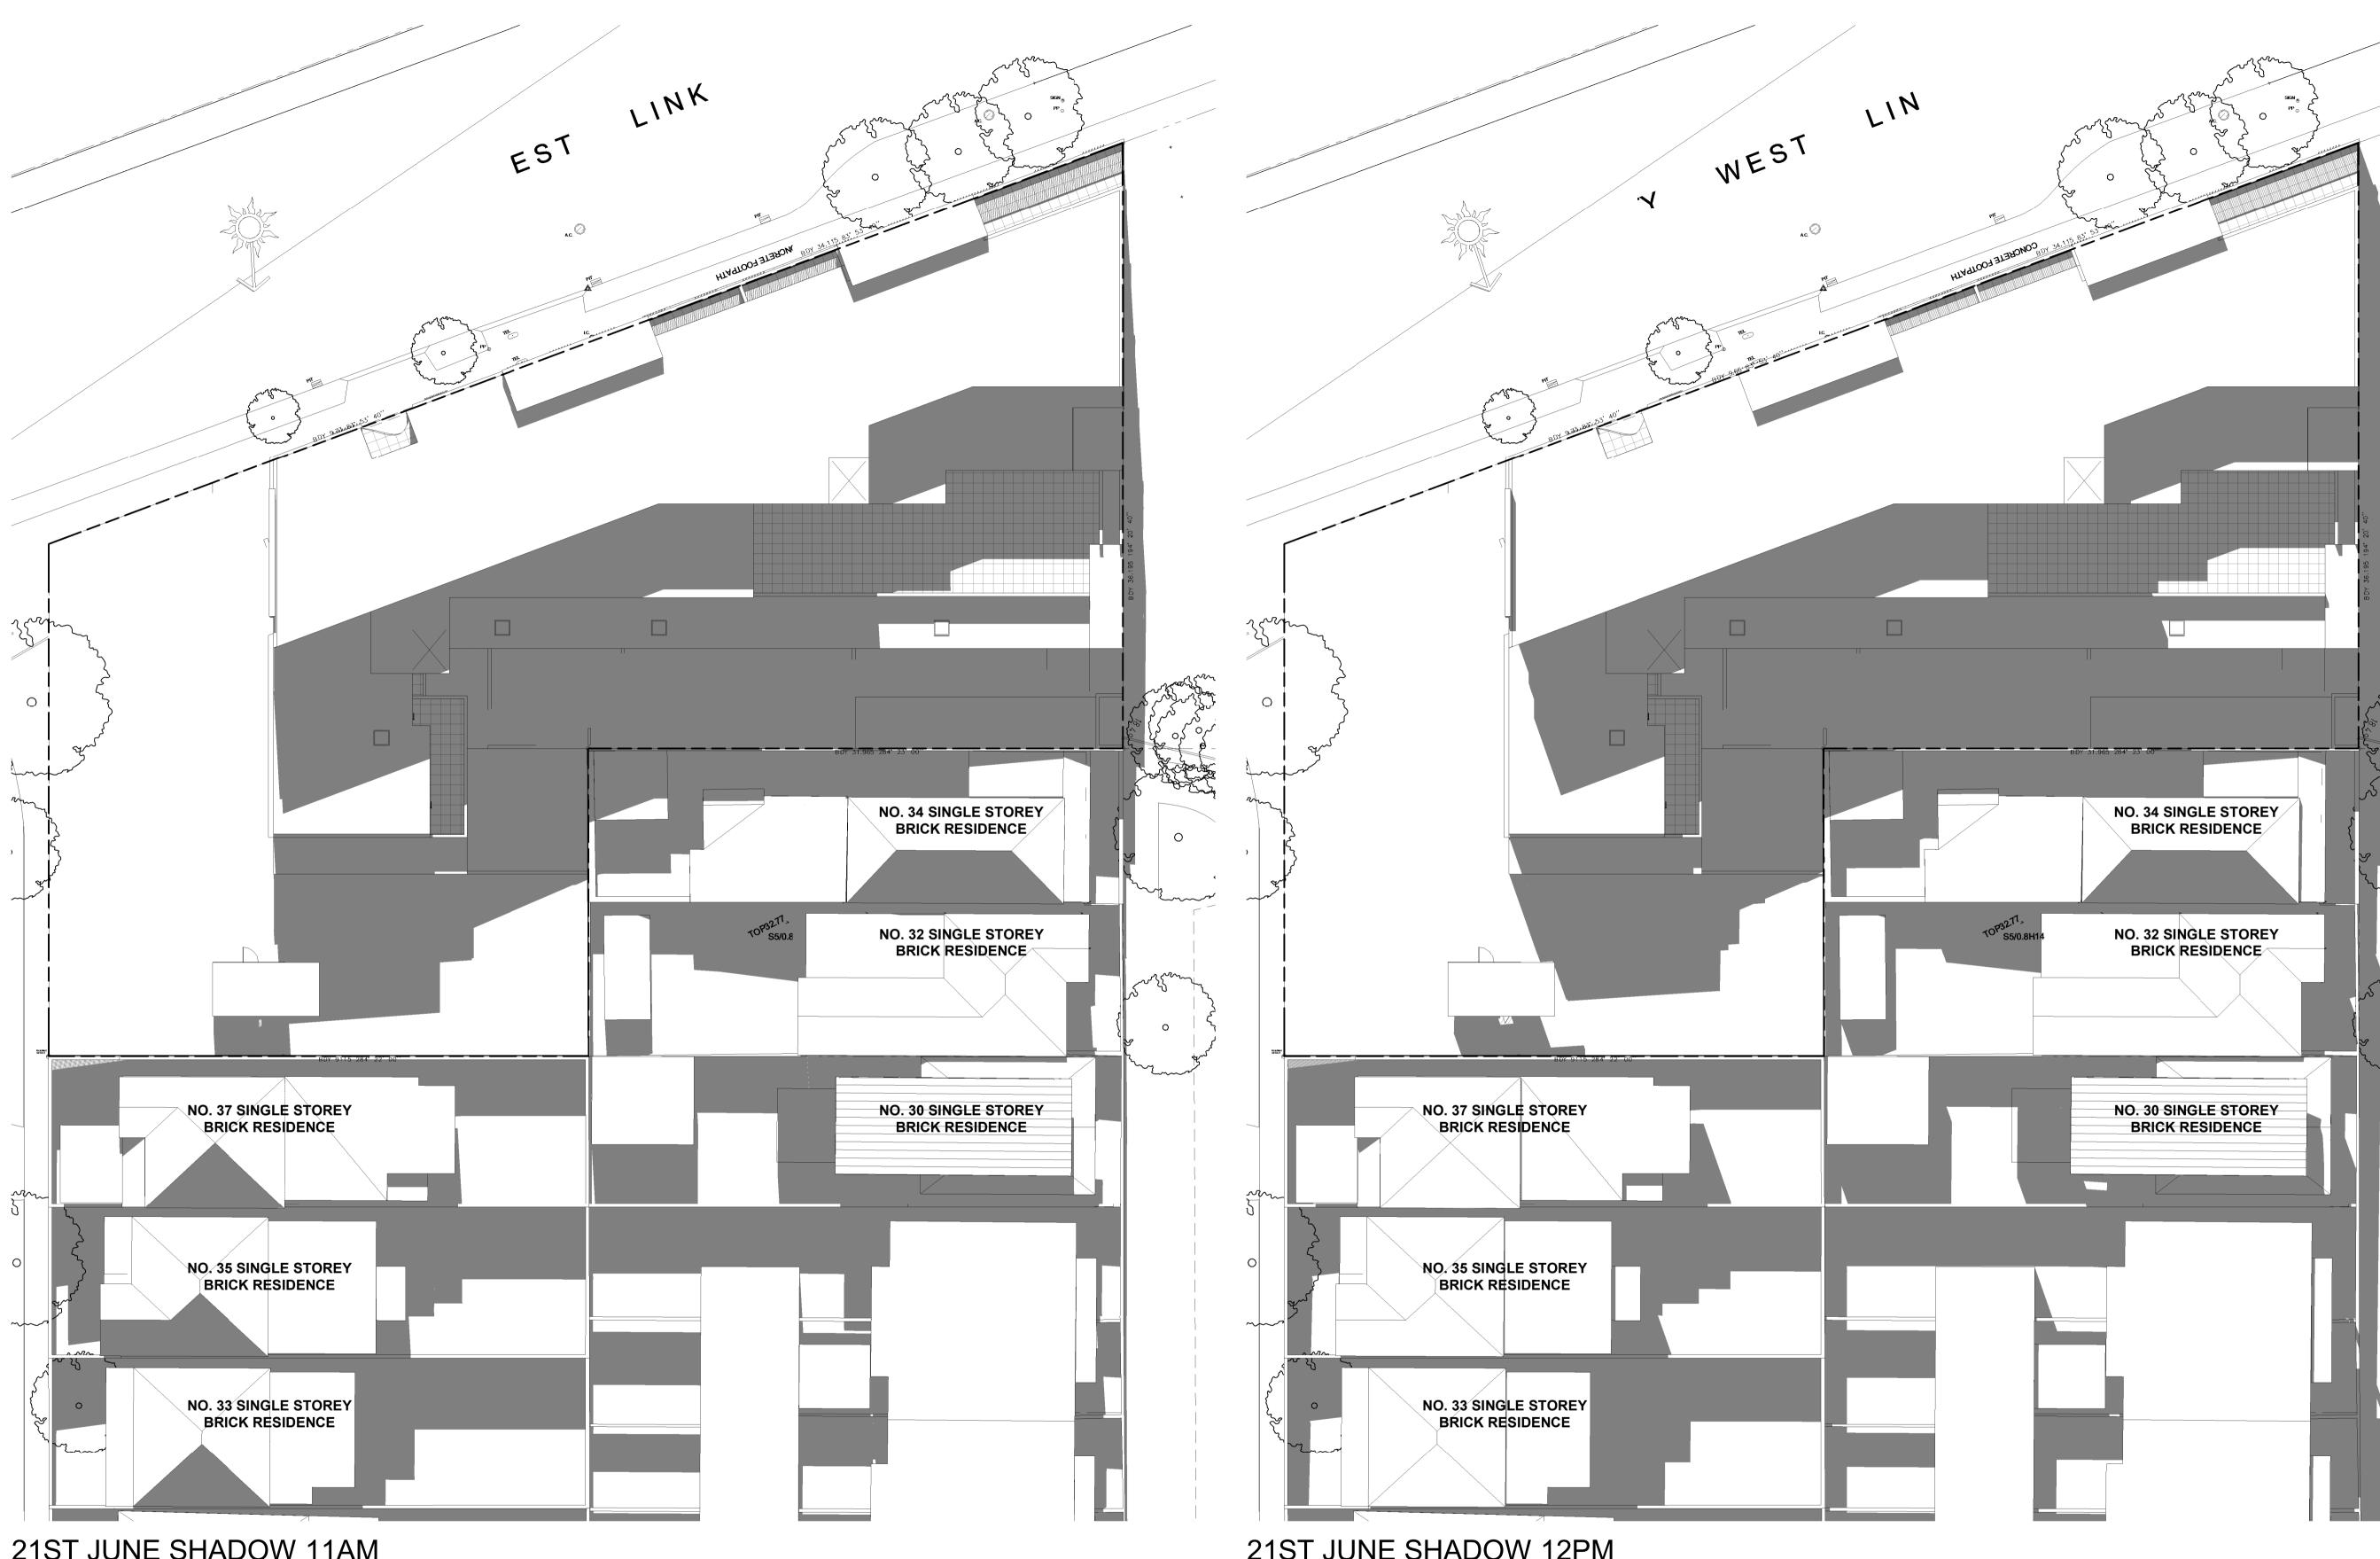

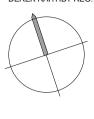
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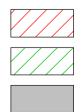
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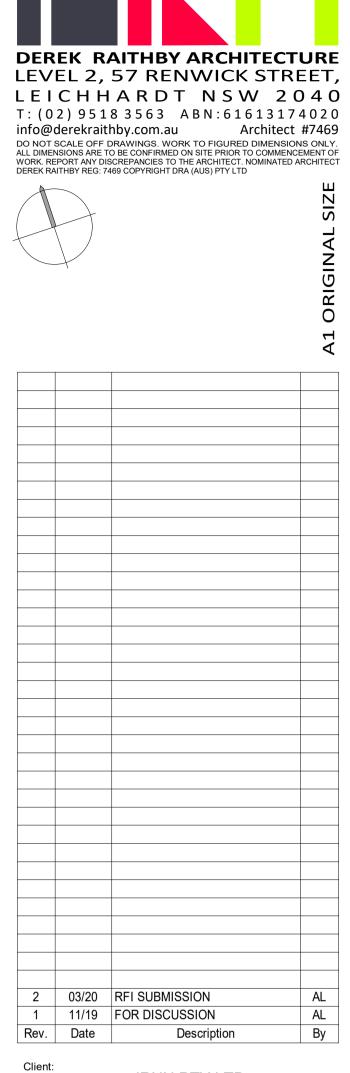
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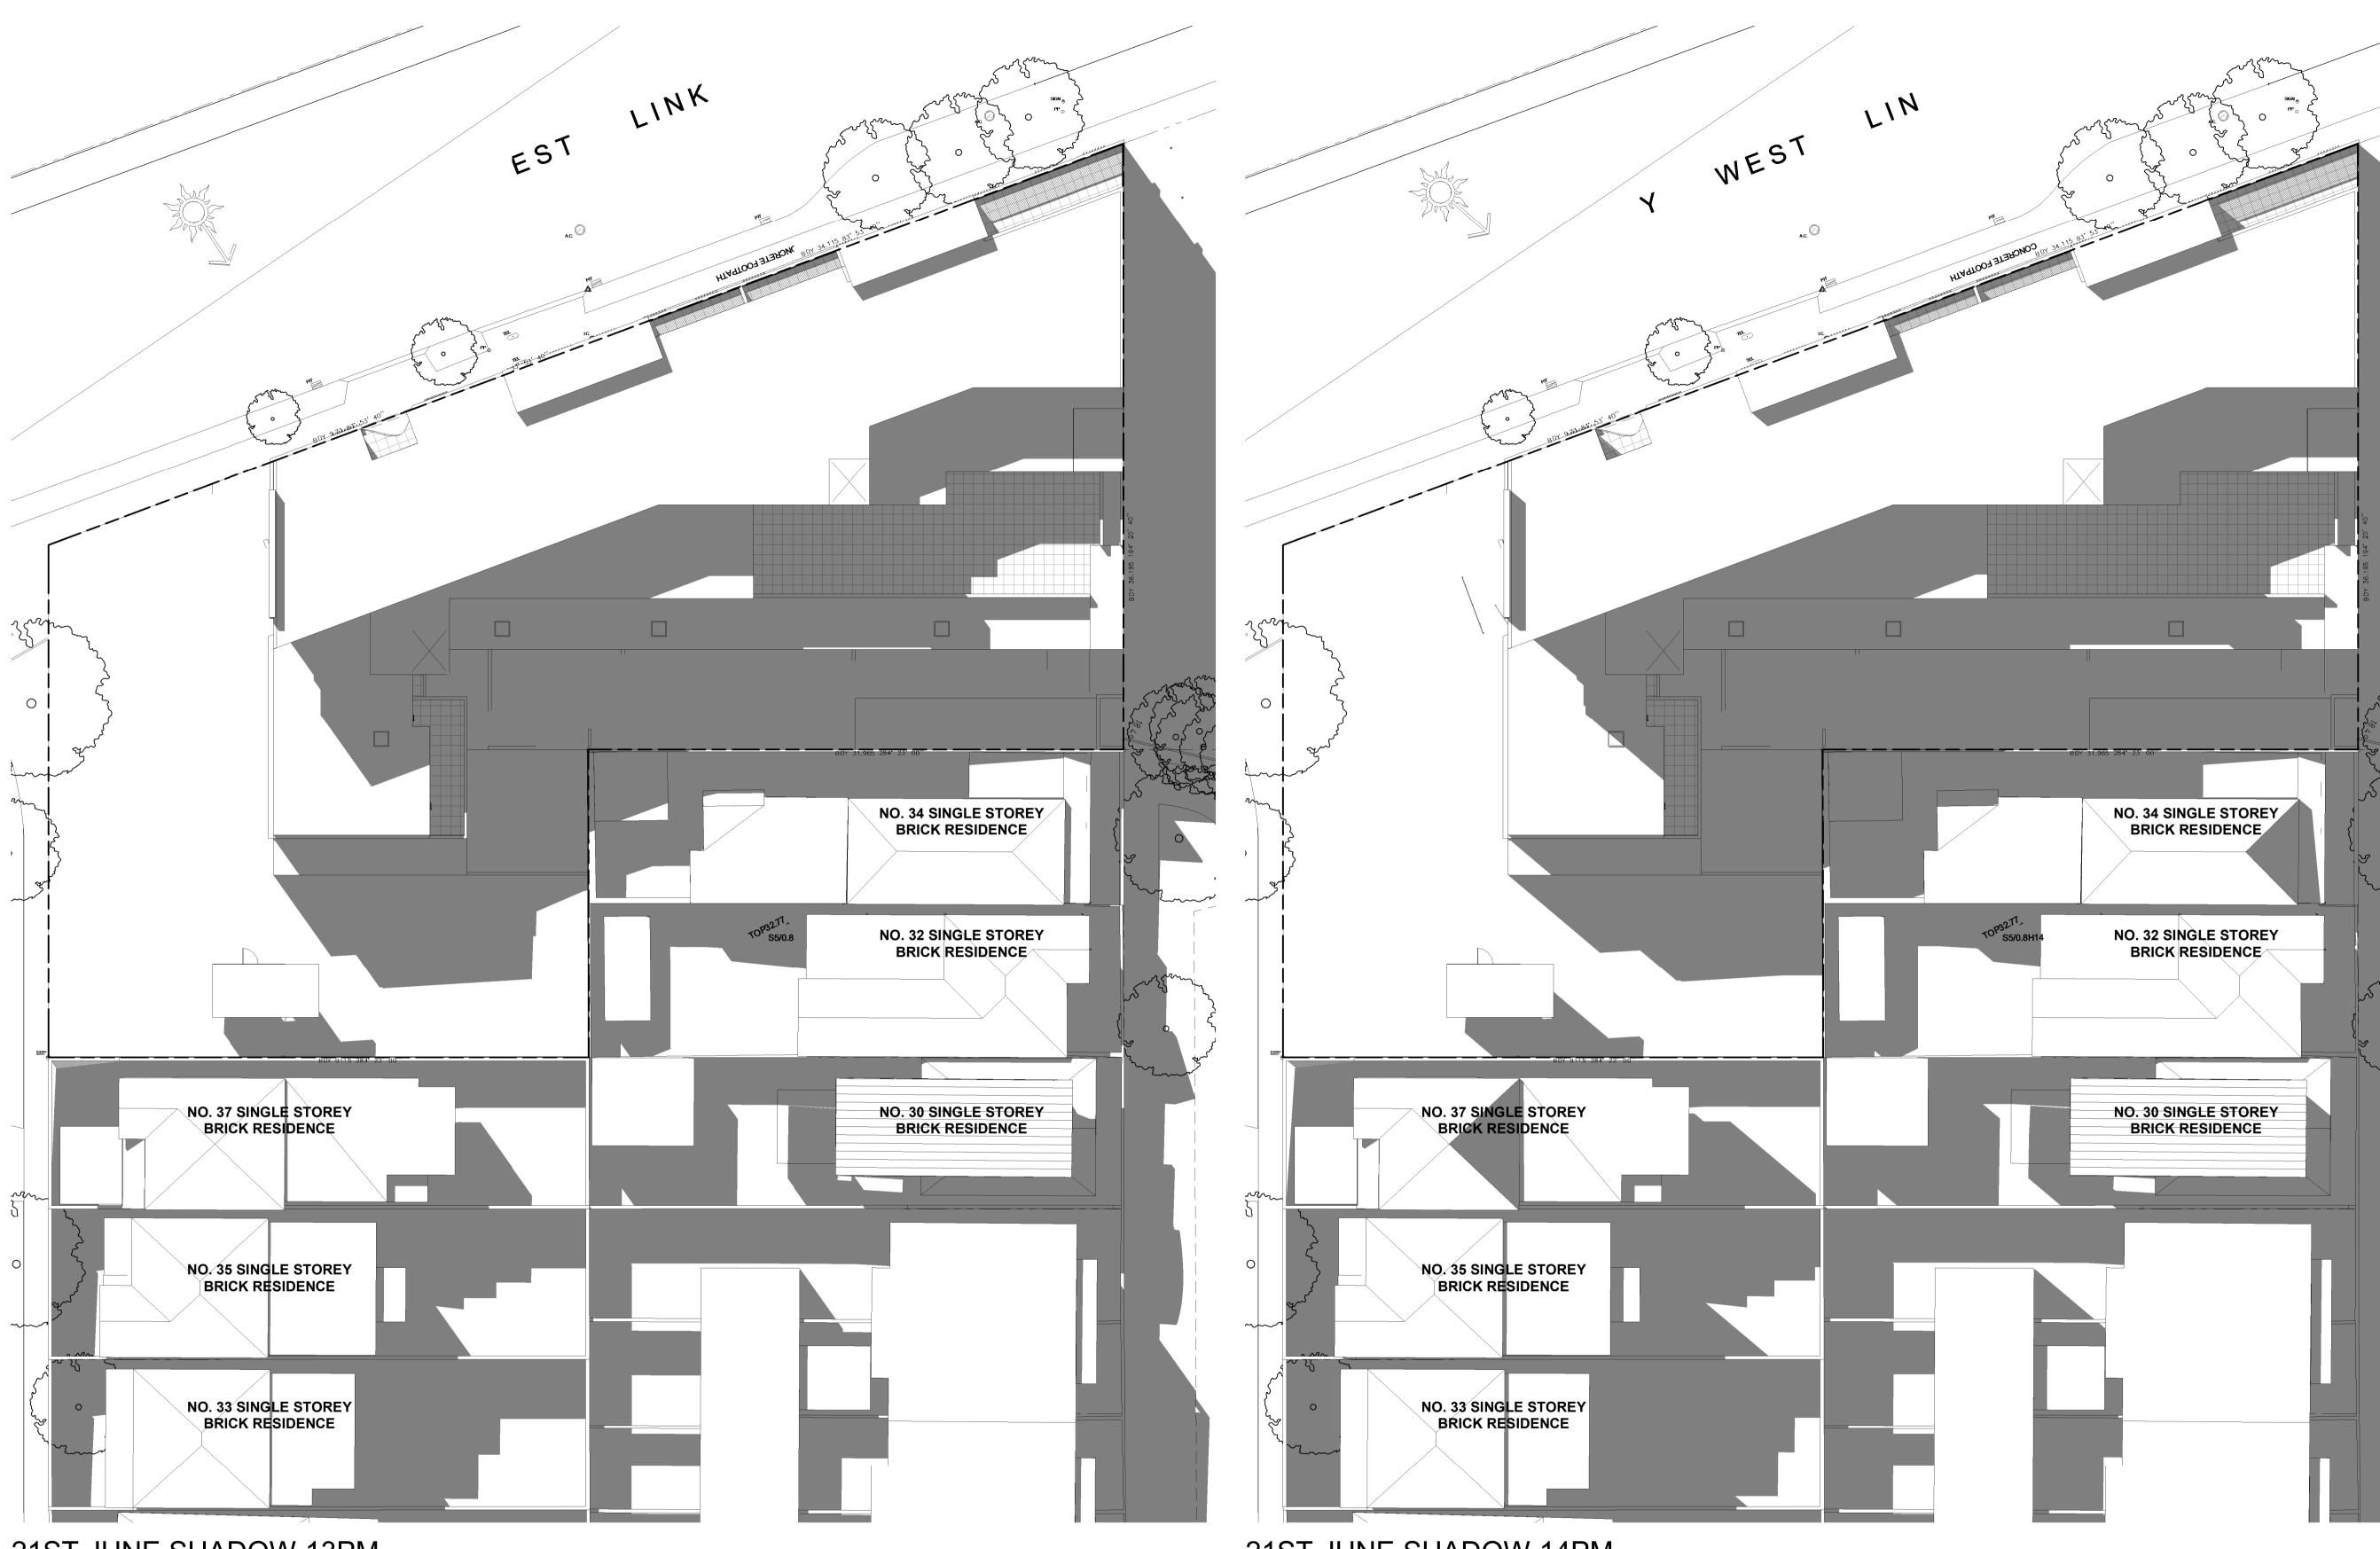
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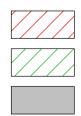
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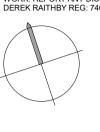





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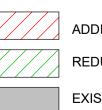
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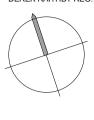
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C.O.S Calculation- Level 1


# Apartment Design Guide


COMPLIANCE

Objective 3D-1 AREA CALCULATIO n adequate area of communal open space is provided to LEVEL SITE AREA enhance residential amenity and to provide opportunities for FIRST FLO andscaping 2145 m² LEVEL TH Design criteria TOTAL Communal open space has a minimum area equal to (30%) (COMPLIES) 25% of the site (see figure 3D.3) Developments achieve a minimum of 50% direct sunlight to the principal usable part of the communal Refer to Drawing No.16-19 open space for a minimum of 2 hours between 9 am and 3 pm on 21 June (mid winter) 1 Design guidance Communal open space should be consolidated into a well designed, easily identified and usable area Communal open space should have a minimum dimension of 3m, and larger developments should consider greater Minimum 5.5 m (Level 3) dimensions Communal open space should be co-located with deep soil areas Allowing access from the Direct, equitable access should be provided to communal street and common areas open space areas from common circulation areas, entries and lobbies Where communal open space cannot be provided at ground level, it should be provided on a podium or roof Where developments are unable to achieve the design criteria, such as on small lots, sites within business zones, or in a dense urban area, they should: --- Minimum deep soil zone area provide communal spaces elsewhere such as a Not Applicable landscaped roof top terrace or a common room provide larger balconies or increased private open space for apartments

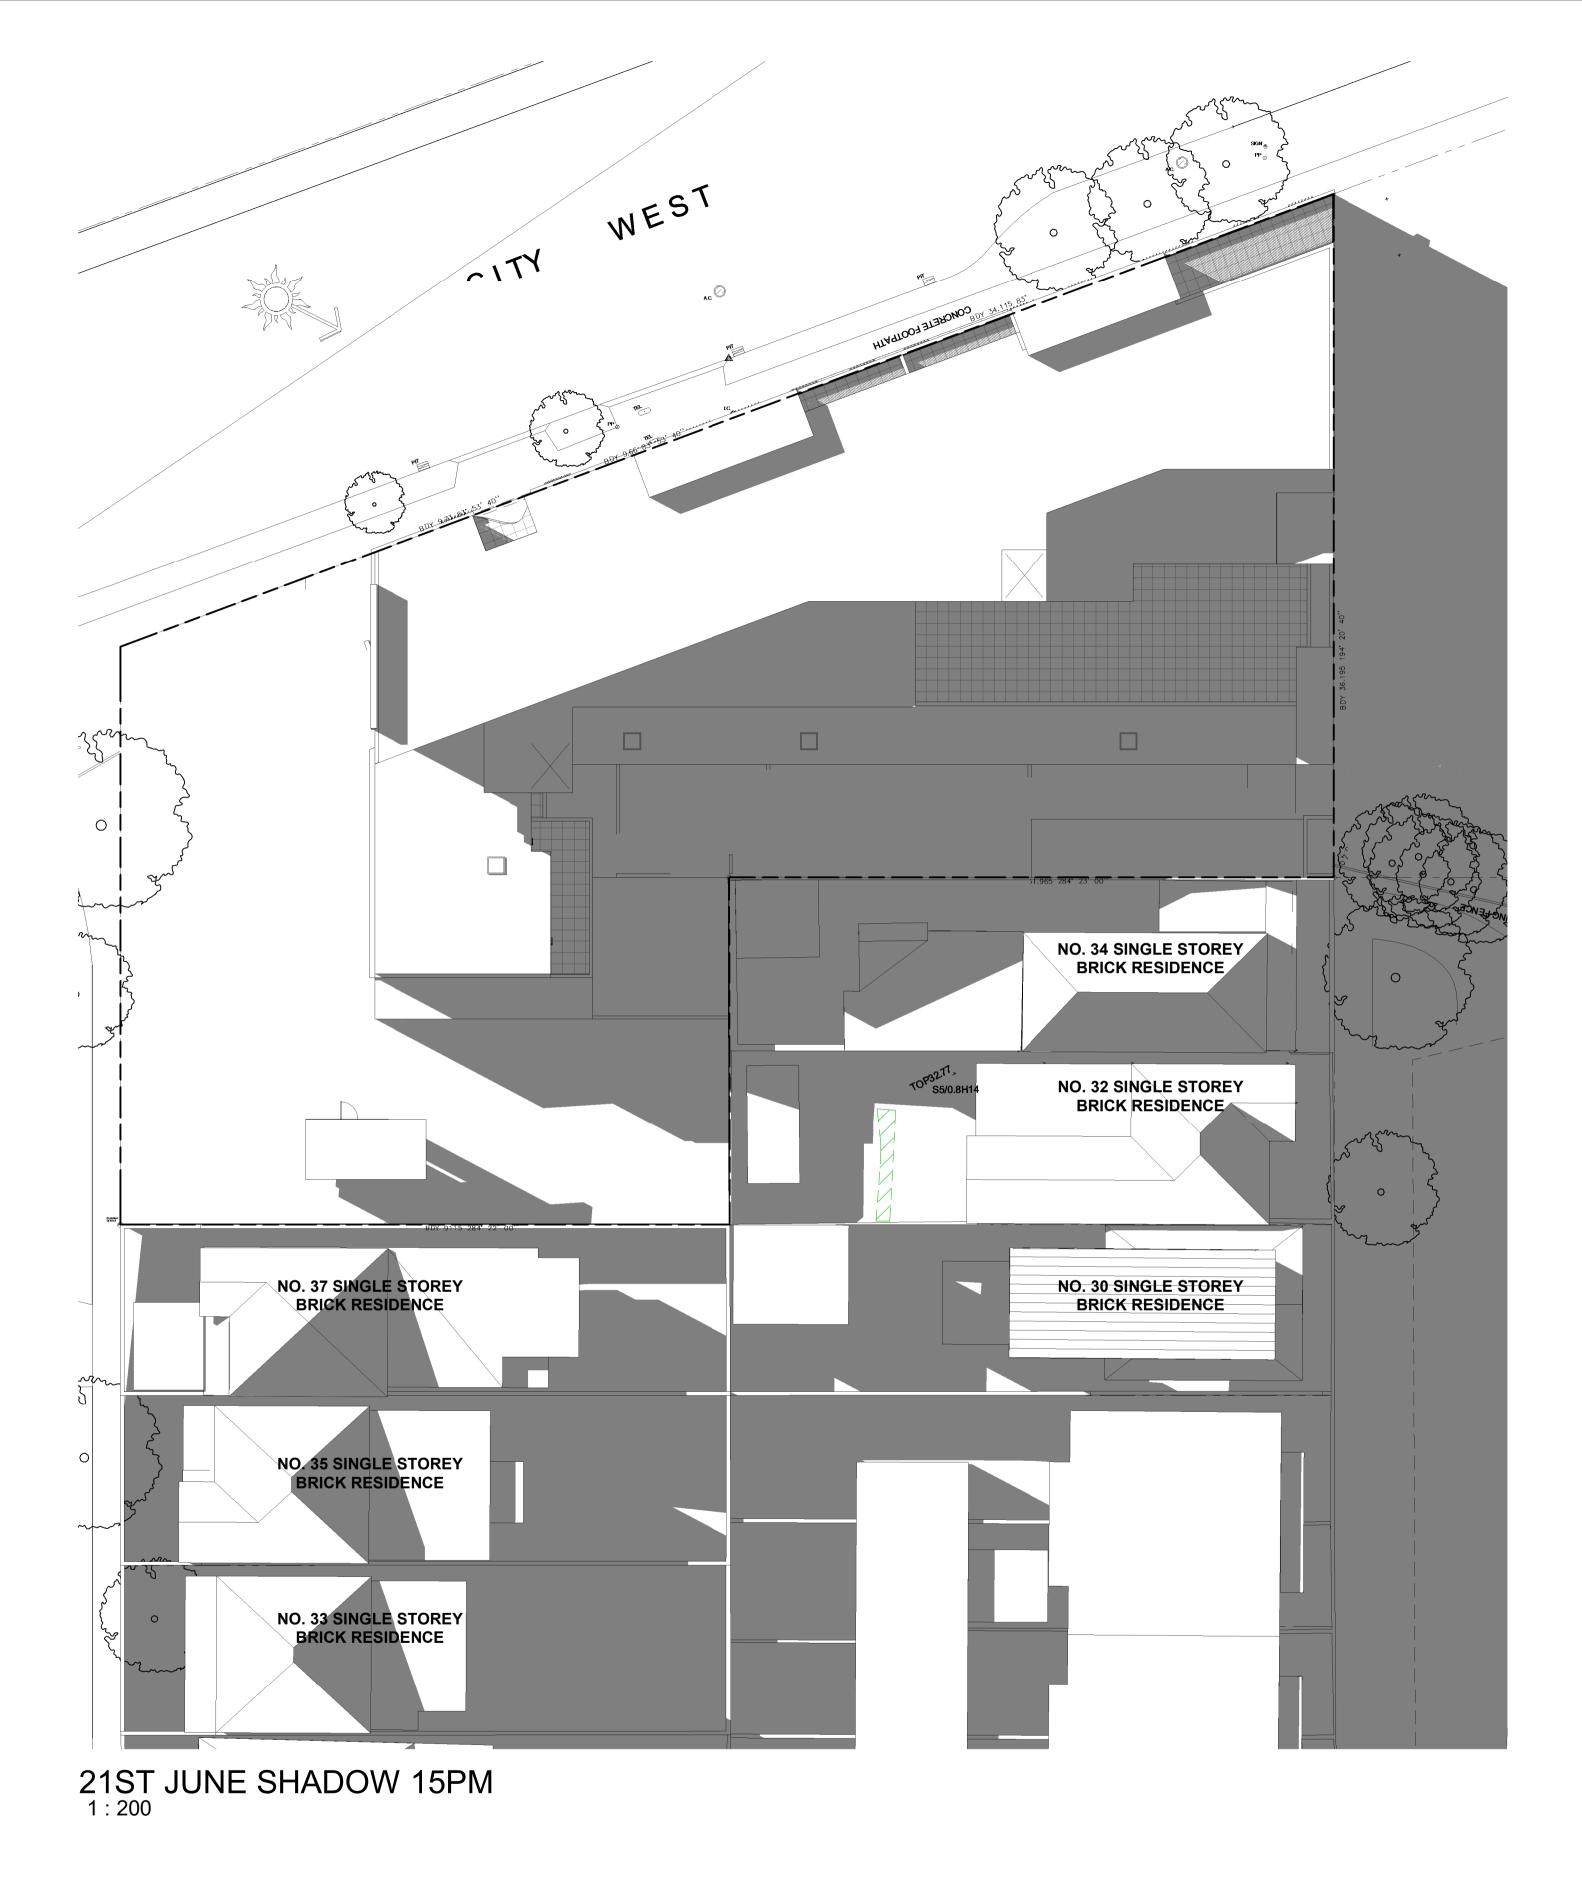demonstrate good proximity to public open space and facilities and/or provide contributions to public open space


C.O.S Calculation - Level 3

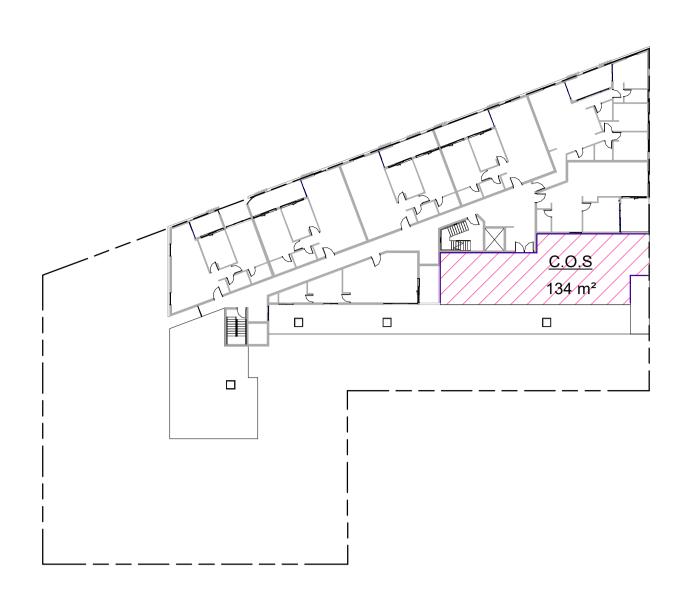

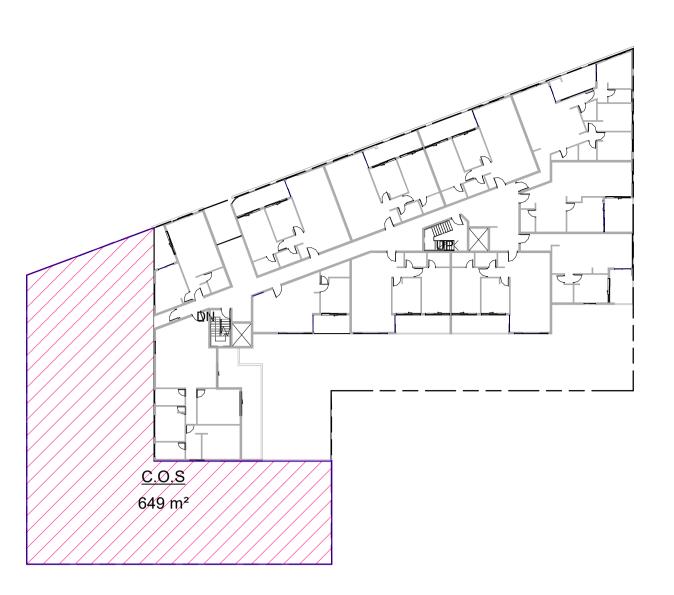

----- Communal open space area

Figure 3E.4 Pedestrian pathways and paving which is specifically designed for tree root growth can occupy up to 10% of the deep soil zone

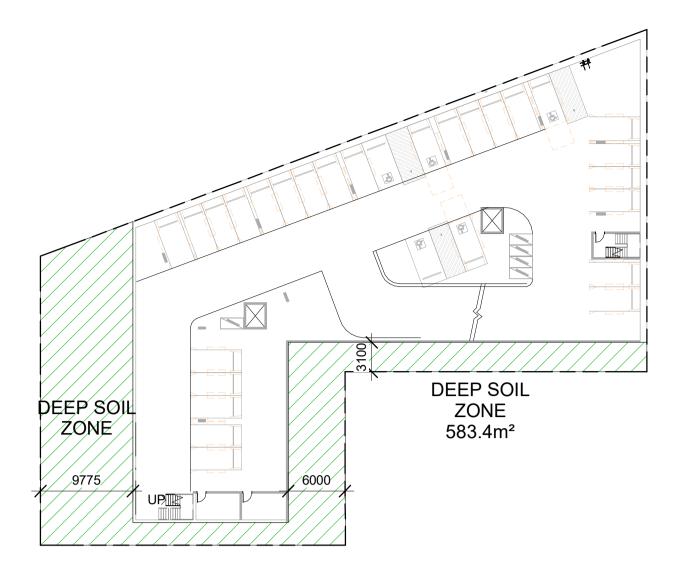

N- COMMUNAL OPEN SPACE				
AREA %				
DOR	649 m²	30%		
REE	134 m²	6%		
	783 m²	36.5%		

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			Deep soil	zone

AREA CALCULATION- DEEP SOIL AREA			
SITE AREA	ADG REQ.%	AREA	%
2145 m²	15%	583.4 m²	27%

(COMPLIES)

Deep Soil Calculation



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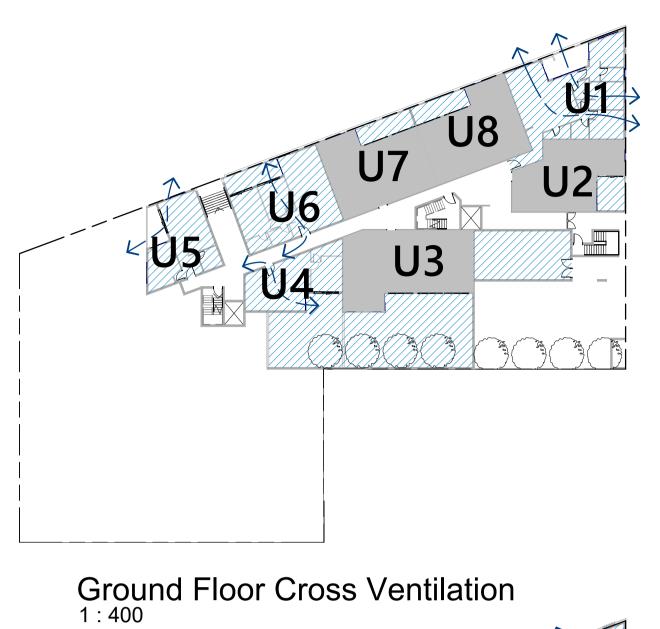
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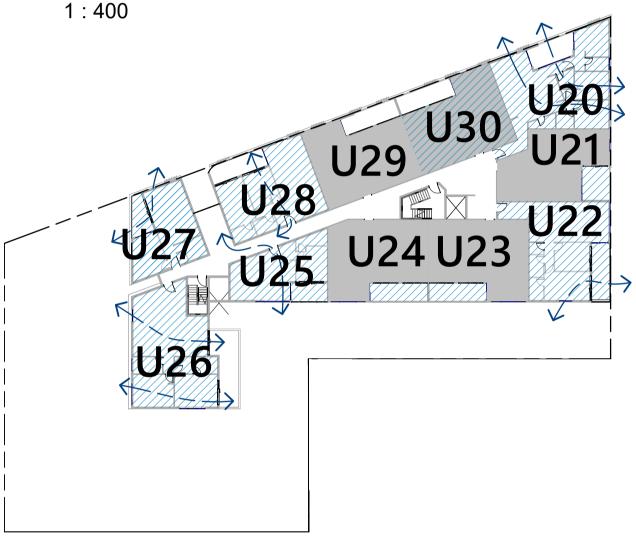
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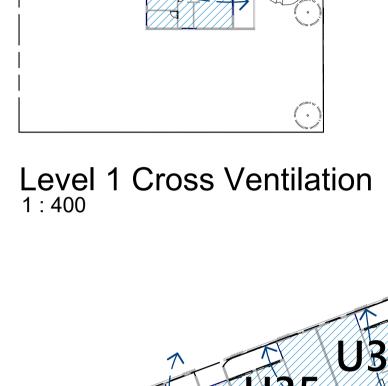
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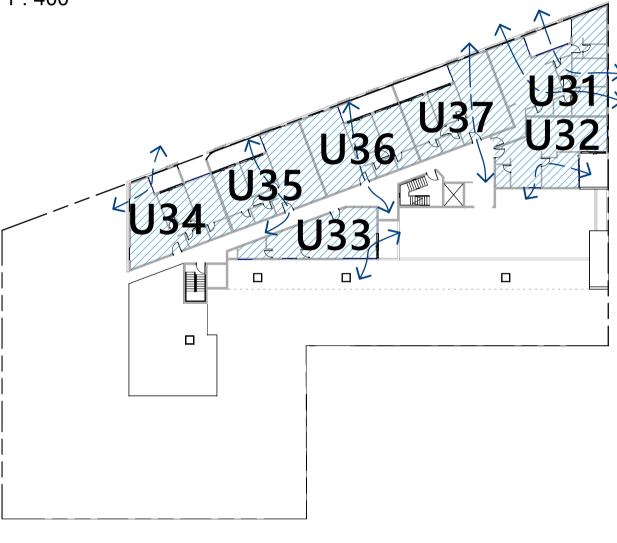
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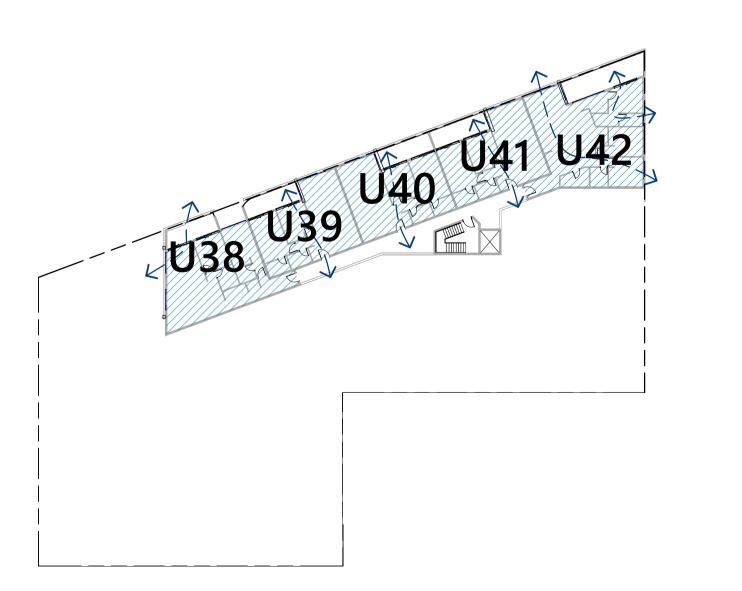









Level 2 Cross Ventilation



Level 4 Cross Ventilation

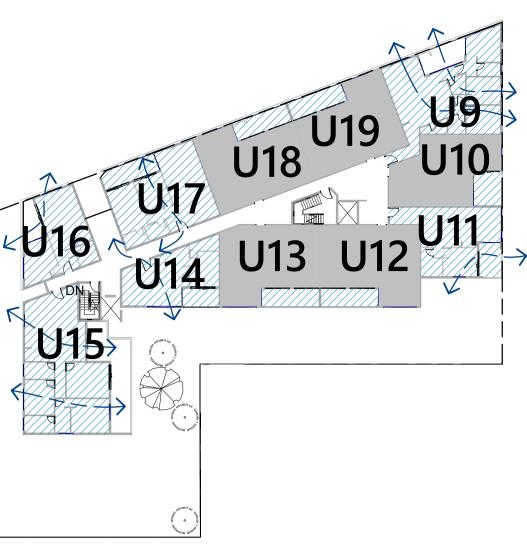

UNIT No.	UNIT TYPE	
U1	3 Bed	Yes
U4	1 Bed	Yes
U5	1 Bed	Yes
U6	2 Bed	Yes
U9	3 Bed	Yes
U11	1 Bed	Yes
U14	1 Bed	Yes
U15	2 Bed	Yes
U16	1 Bed	Yes
U17	2 Bed	Yes
U20	3 Bed	Yes
U22	2 Bed	Yes
U25	1 Bed	Yes
U26	2 Bed	Yes
U27	2 Bed	Yes
U28	2 Bed	Yes
U31	3 Bed	Yes
U32	1 Bed	Yes
U33	1 Bed	Yes
U34	2 Bed	Yes
U35	2 Bed	Yes
U36	2 Bed	Yes
U37	2 Bed	Yes
U38	2 Bed	Yes
U39	2 Bed	Yes
U40	2 Bed	Yes
U41	2 Bed	Yes
U42	3 Bed	Yes

SEPP65 - CROSS VENTILATION COMPLIANCE					
UNITS	UNITS No. OF UNITS PERCENTAGE CRITEREA (SEPP) PASS				
28	42	67%	60%	1	

Where possible

Where possible

Where possible

# Level 3 Cross Ventilation

The max	jective 4B-3 number of apartments with natural cross ventilation is timised to create a comfortable indoor environment for dents	COMPLIANCE
Des	sign criteria	
1.	At least 60% of apartments are naturally cross ventilated in the first nine storeys of the building. Apartments at ten storeys or greater are deemed to be cross ventilated only if any enclosure of the balconies at these levels allows adequate natural ventilation and cannot be fully enclosed	(67%)
2.	Overall depth of a cross-over or cross-through	

apartment does not exceed 18m, measured glass

The building should include dual aspect apartments,

cross through apartments and corner apartments and limit

In cross-through apartments external window and door

opening sizes/areas on the other side of the apartment

Apartments are designed to minimise the number of

corners, doors and rooms that might obstruct airflow

opening sizes/areas on one side of an apartment (inlet side) are approximately equal to the external window and door

line to glass line

(outlet side) (see figure 4B.4)

Design guidance


apartment depths

**APARTMENT DESIGN GUIDE** 

Apartment depths, combined with appropriate ceiling heights, maximise cross ventilation and airflow



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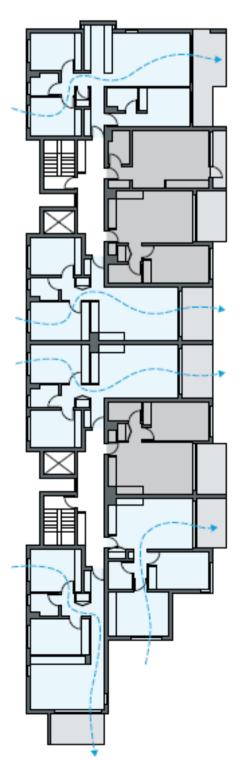


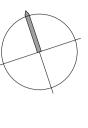Figure 4B.8 The floor plan above demonstrates one approach for how five of a total of eight apartments achieve natural cross ventilation



3D View 1



3D View 2



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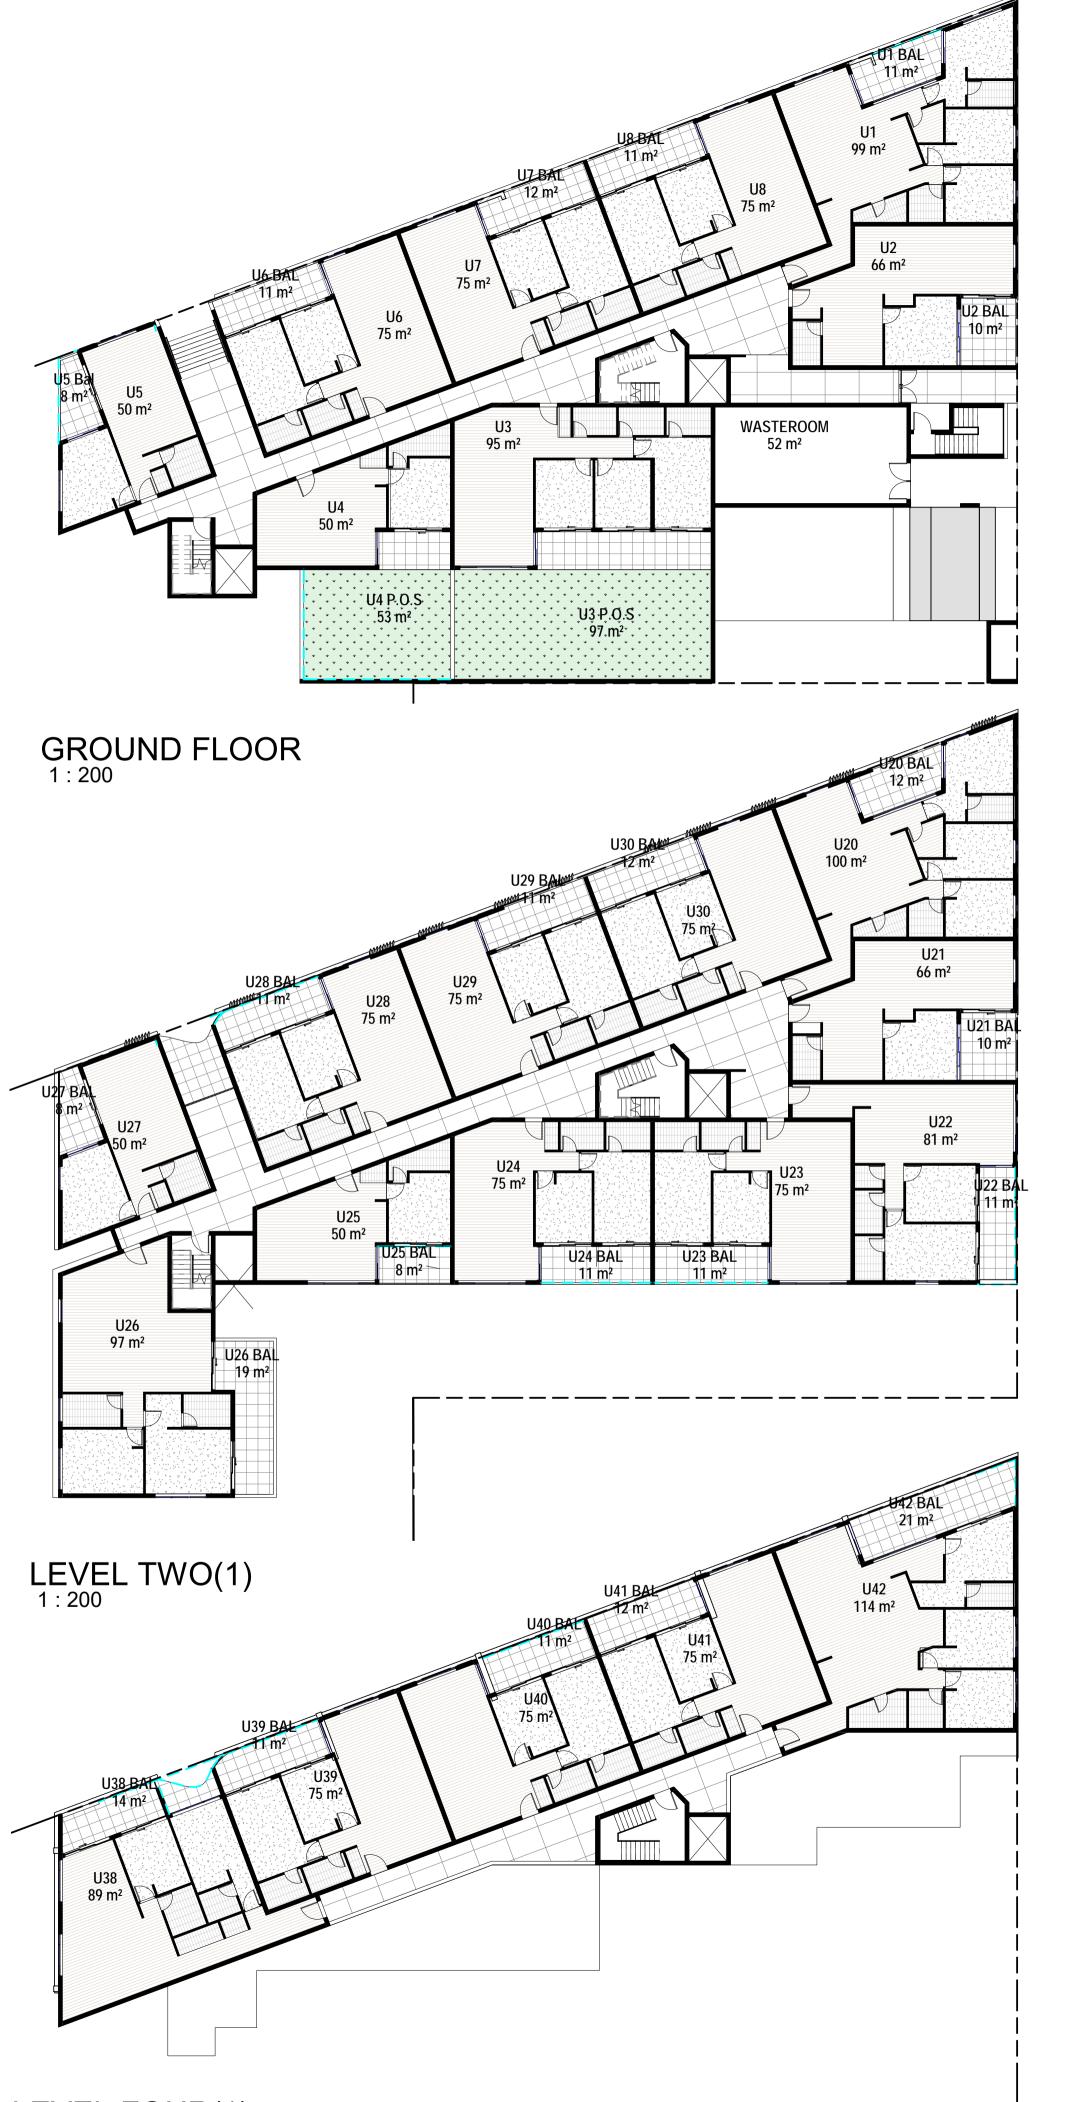
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Client:

### JRNN PTY LTD C/O DEREK RAITHBY ARCHITECTURE

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Project:		
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LEVEL FOUR(1)

U15 110 m²



AREA CALCULATION - PRIVATE OPEN SPACE					
UNIT No.	UNIT TYPE	CRITERIA (ADG)	AREA PROVIDED		
U1 BAL	3 Bed	12 m <sup>2</sup>	11 m <sup>2</sup>	FAIL	
U2 BAL	1 Bed	8 m²	10 m <sup>2</sup>	PASS	
U3 P.O.S	3 Bed	12 m²	97 m²	PASS	
U4 P.O.S	1 Bed	8 m²	53 m²	PASS	
U5 Bal	1 Bed	8 m²	8 m²	PASS	
U6 BAL	2 Bed	10 m²	11 m²	PASS	
U7 BAL	2 Bed	10 m²	12 m²	PASS	
U8 BAL	2 Bed	10 m²	11 m <sup>2</sup>	PASS	
U9 BAL	3 Bed	12 m²	12 m²	PASS	
U10 BAL	1 Bed	8 m²	10 m <sup>2</sup>	PASS	
U11 BAL	1 Bed	8 m²	8 m²	PASS	
U12 BAL	2 Bed	10 m²	11 m <sup>2</sup>	PASS	
U13 BAL	2 Bed	10 m²	11 m <sup>2</sup>	PASS	
U14 BAL	1 Bed	8 m²	8 m²	PASS	
U15 P.O.S	3 Bed	12 m²	30 m <sup>2</sup>	PASS	
U16 BAL	1 Bed	8 m²	8 m²	PASS	
U17 BAL	2 Bed	10 m²	12 m <sup>2</sup>	PASS	
U18 BAL	2 Bed	10 m²	12 m <sup>2</sup>	PASS	
U19 BAL	2 Bed	10 m²	12 m²	PASS	
U20 BAL	3 Bed	12 m²	12 m²	PASS	
U22 BAL	2 Bed	10 m²	11 m²	PASS	
U23 BAL	2 Bed	10 m²	11 m²	PASS	
U24 BAL	2 Bed	10 m²	11 m²	PASS	
U25 BAL	1 Bed	8 m²	8 m²	PASS	
U26 BAL	2 Bed	10 m²	19 m²	PASS	
U27 BAL	1 Bed	8 m²	8 m²	PASS	
U28 BAL	2 Bed	10 m²	11 m²	PASS	
U29 BAL	2 Bed	10 m²	11 m²	PASS	
U30 BAL	2 Bed	10 m²	12 m²	PASS	
U31 BAL	3 Bed	12 m²	12 m²	PASS	
U32 BAL	1 Bed	8 m²	10 m²	PASS	
U33 BAL	1 Bed	8 m²	8 m²	PASS	
U34 BAL	2 Bed	10 m²	10 m²	PASS	
U35 BAL	2 Bed	10 m²	11 m²	PASS	
U36 BAL	2 Bed	10 m²	11 m²	PASS	
U37 BAL	2 Bed	10 m²	11 m <sup>2</sup>	PASS	
U38 BAL	2 Bed	10 m²	14 m²	PASS	
U39 BAL	2 Bed	10 m²	11 m²	PASS	
U40 BAL	2 Bed	10 m²	11 m²	PASS	
U41 BAL	2 Bed	10 m²	12 m²	PASS	
U42 BAL	3 Bed	12 m²	21 m²	PASS	


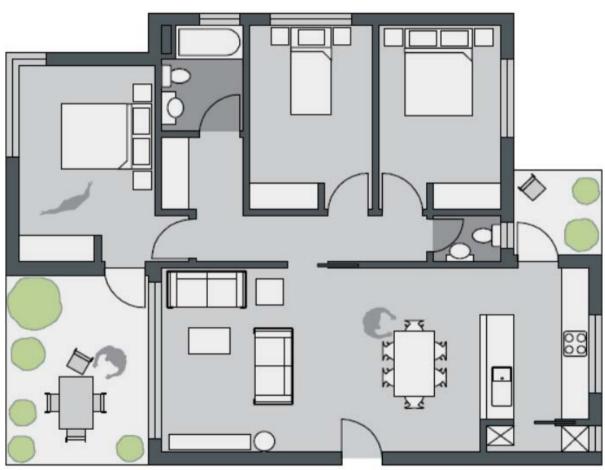


Figure 4E.4 Building layout should maximise balcony use by allowing access from the main living area and a bedroom (where possible). Secondary balconies provide further amenity to apartment living and are best accessed off kitchens and laundries

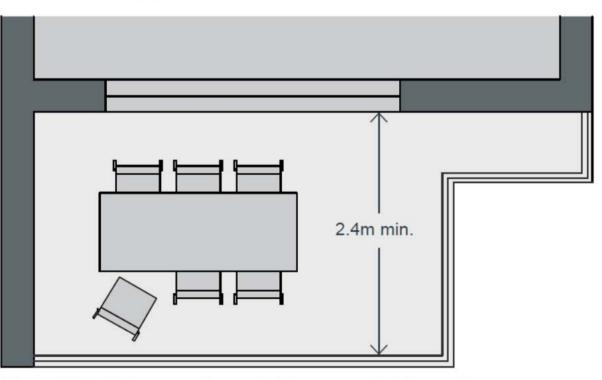


useable and can be easily accessed

# STATE ENVIRONMENTAL PLANNING POLICY 65 – APARTMENT DESIGN GUIDE 4E Private open space and balconies

1.	4E-1 Apartments provide appropriately sized private open	Dwelling type	Min. POS area	Min. POS Depth
	space and balconies to enhance residential amenity	Studio	4m²	-
		1br	8m²	2m
		2br	10m <sup>2</sup>	2m
		3br	12m <sup>2</sup>	2.4m
		The min balcor contributing to		
2.	For apartments at ground level or on a podium or similar structure, a private open space is provided instead of a balcony. It must have a minimum area of 15m2 and a minimum depth of 3m			

Figure 4E.3 Minimum balcony depths ensure that the balcony area is

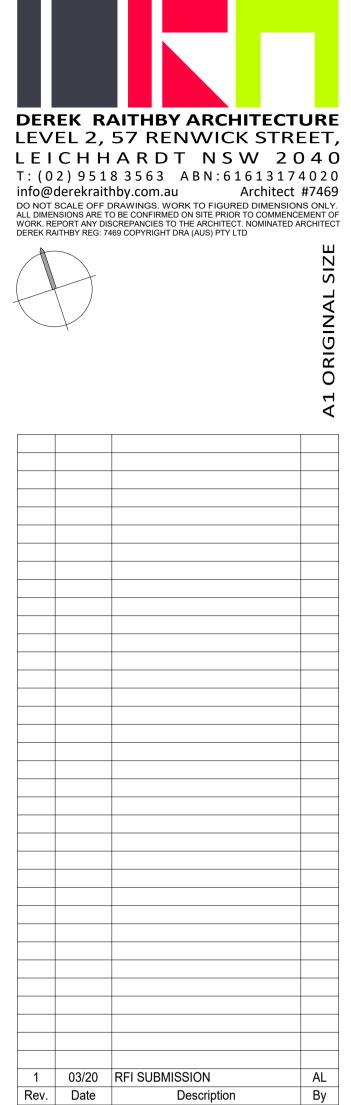

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# JRNN PTY LTD C/O DEREK RAITHBY ARCHITECTURE

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