




RESIDENTIAL DEVELOPMENT LONSDALE STREET & BRENAN STREET, LILYFIELD



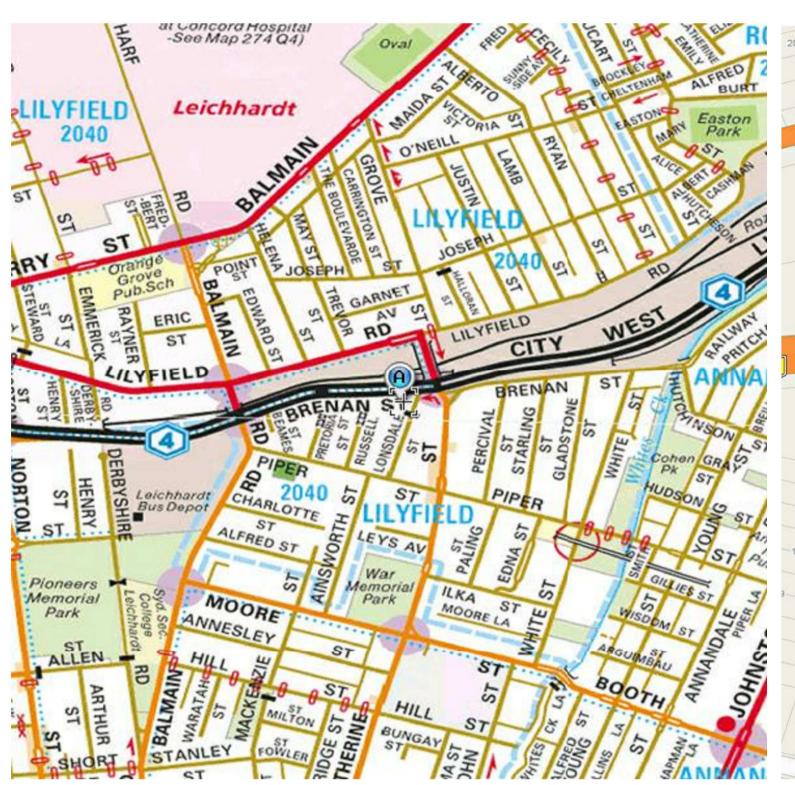

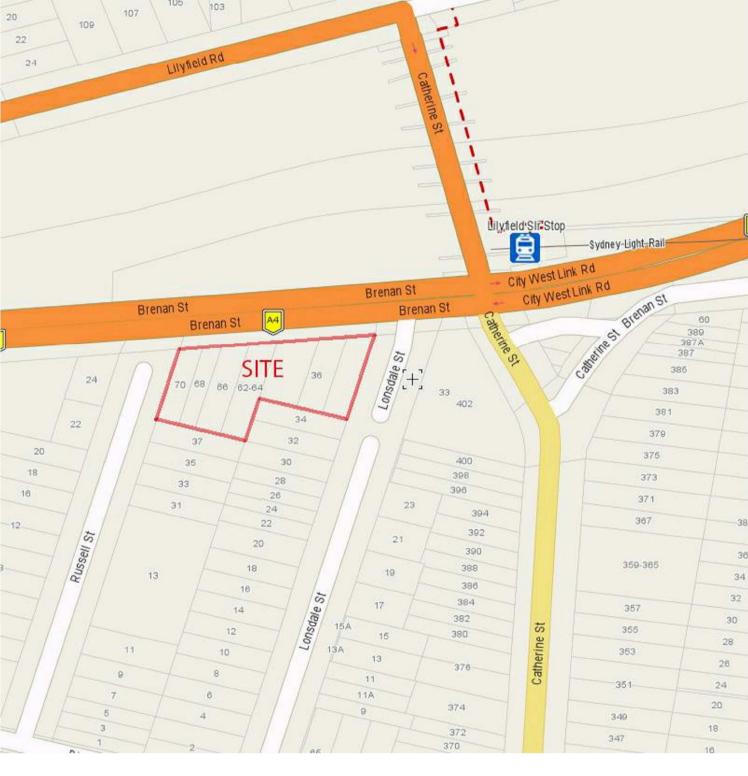

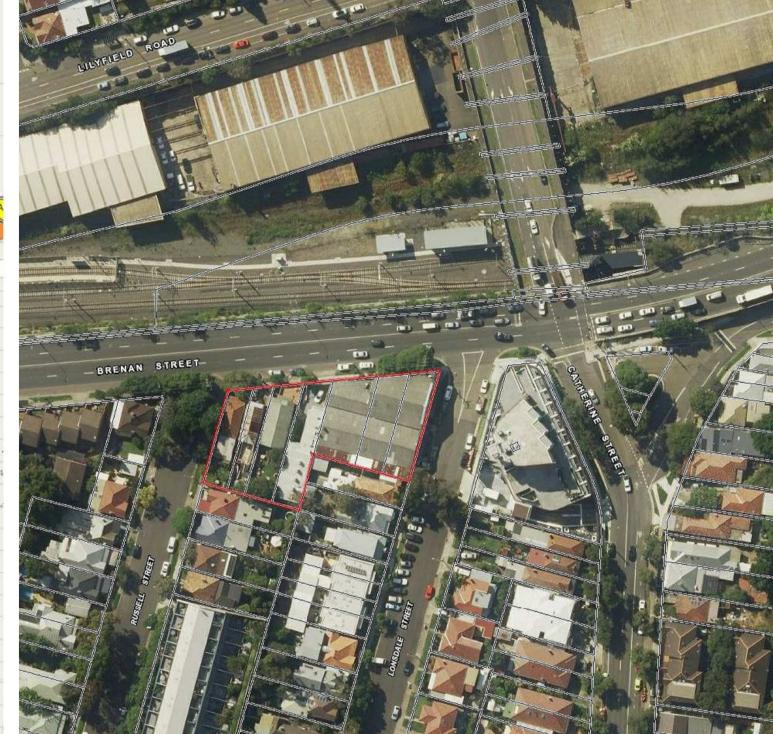

STREET DIRECTORY (www.street-directory.com.au)

STREET DIRECTORY (www.street-directory.com.au)

AERIAL PHOTOGRAPH (maps.six.nsw.gov.au)

ARCH	IITEC	TURAL DRAWINGS
Project#	DWG#	TITLE
1919	00	COVER PAGE

AERIAL PHOTOGRAPH - 1943(maps.six.nsw.gov.au)

Project#	DWG#	TITLE	SCALE	ISSUE	DATE
1919	00	COVER PAGE		4	03/20
	01	ADG COMPLIANCE SUMMARY		2	03/20
	02	SITE ANALYSIS PLAN		4	03/20
	03	BASEMENT TWO PLAN			
	04	BASEMENT ONE PLAN		2	03/20
	05	GROUND FLOOR PLAN		4	03/20
	06	FIRST FLOOR PLAN		4	03/20
	07	SECOND FLOOR PLAN		4	03/20
	80	THIRD FLOOR PLAN		4	03/20
	09	FOURTH FLOOR PLAN		4	03/20
	10	ROOF PLAN		4	03/20
	11	ELEVATIONS		4	03/20
	12	SECTIONS		3	03/20
	13	DIAGRAM - GFA		2	03/20
	14	DIAGRAM - SOLAR ACCESS			
	15	DIAGRAM- LANDSCAPE & COVERAGE		2	01/20
	16	DIAGRAM- SHADOW ANALYSIS 1 OF 4		2	03/20
	17	DIAGRAM- SHADOW ANALYSIS 2 OF 4		2	03/20
	18	DIAGRAM- SHADOW ANALYSIS 3 OF 4		2	03/20
	19	DIAGRAM- SHADOW ANALYSIS 4 OF 4		2	03/20
	20	DIAGRAM- COMMUNAL OPEN SPACE		3	03/20
	21	DIAGRAM- CROSS VENTILATION		2	01/20
	22	FINISHES SCHEDULE			
	23	WINDOW AND DOOR SCHEDULE			
	24	ADAPTABLE HOUSING			
	25	PERSPECTIVES		3	03/20
	26	EXISTING HOUSE SHADOW DIAGRAM		1	01/20
	27	DIAGRAM- PRIVATE OPEN SPACE		1	03/20



Artist Impression


	BED 1	BED 2	BED 3	TOTAL
GROUND FLOOR	3	3	2	
GROUND FLOOR	37.5%	37.5%	25%	8
FIRST FLOOR	4	5	2	
FIRST FLOOR	36.3%	45.5%	18.2%	11
0500ND 51 00D	3	6	2	- 11
SECOND FLOOR	27.3%	54.5%	18.2%	
	2	4	1	7
THIRD FLOOR	28.6%	57.1%	14.3%	'
FOURTH FLOOR	0	4	1	5
FOURTHFLOOR	-	80%	10%	


TOTAL NUMBER OF UNITS (INCLUDING 1 BED, 2 BED & 3 BED)= 42 =100%

TOTAL NUMBER OF 1 BED UNITS= 12 = 28.6% OF TOTAL UNITS TOTAL NUMBER OF 2 BED UNITS= 22 = 52.4% OF TOTAL UNITS

TOTAL NUMBER OF 3 BED UNITS= 8 = 19.0% OF TOTAL UNITS

STATE ENVIRO	NMENTAL PLANNING POLICY 6	55 – APARTMENT DESIGN GUIDE	E – COMPLIAN	ICE TABLE						
03 SITTING	OBJECTIVES	DESIGN CRITERIA	PROPOSED	COMPLIANCE		OBJECTIVES	DESIGN CRITERIA	PROPOSED CO	OMPLIANCE	
3D Communal and public open space	3D-1 An adequate area of communal open space is provided to enhance residential amenity and to provide opportunities for	Communal open space has a minimum area equal to 25% of the site	36.4%			Every habitable room must have total minimum glass area of not lof the room. Daylight and air may rooms	less than 10% of the floor area	COMPLIES		DEREK RAITHBY ARCHITECTURE LEVEL 2, 57 RENWICK STREET, LEICHHARDT NSW 2040 T: (02) 9518 3563 ABN:61613174020 info@derekraithby.com.au Architect #7469 DO NOT SCALE OFF DRAWINGS. WORK TO FIGURED DIMENSIONS ONLY.
3E Deep soil	landscaping 3E-1 Deep soil zones provide	7% of the site area				4D-2 Environmental performance of the apartment is maximised	Habitable room depths are limited to a maximum of 2.5 x the ceiling height	CAN COMPLY		ALL DIMENSIONS ARE TO BE CONFIRMED ON SITE PRIOR TO COMMENCEMENT OF WORK. REPORT ANY DISCREPANCIES TO THE ARCHITECT. NOMINATED ARCHITECT DEREK RAITHBY REG: 7469 COPYRIGHT DRA (AUS) PTY LTD
zones	areas on the site that allow for and support healthy plant and tree growth. They improve residential amenity		27%			In open plan layouts (where the loombined) the maximum habitab		CAN COMPLY		A1 ORIGIN,
3F Visual	and promote management of water and air quality 3F-1 Adequate building	habitable Non Building rooms & -habitable				4D-3 Apartment layouts are designed to accommodate a variety of household activities	Bedrooms have minimum area Bedroom type Min. area Min. dim. Master 10m² 3m			
privacy	separation distances are shared equitably between neighbouring sites, to achieve	height balconies rooms Up to 12m (4 storeys) 6m 3m	COMPLIES			and needs	other bedroom 9m² 3m (both measurement excluding wardrobe space)	COMPLIES		
	reasonable levels of external and internal visual privacy	Up to 25m 9m 4.5m (5-8 storeys) 12m 6m (9+ storeys) 6m					Living rooms or combined living/dining rooms have a minimum width of:		•	
3J Bicycle and car parking	3J-1 Car parking is provided based on proximity to public	Within 800m to rail station or light rail stop, car parking needs					Studio & 1 br 3.6m 2br & 3 br 4m	COMPLIES		
04 DESIGNING	transport in metropolitan Sydney and centres in regional areas	in Guide to Traffic Generating Developments apply	60m		4E Private open space and balconies	private open space and balconies to enhance	Dwelling type Min. POS area Studio 4m² - 1br 8m² 2m	COMPLIES		
	10 1 To optimica the pumber	Living recome and private anap				residential amenity	2br 10m² 2m 3br 12m² 2.4m			2 03/20 RFI SUBMISSION AL
4A Solar and daylight access	4A-1 To optimise the number of apartments receiving sunlight to habitable rooms, primary windows and private	Living rooms and private open spaces of at least 70% of apartments in a building receive minimum of 2 hours direct	a 88%				The min balcony depth to be counted as contributing to balcony is 1m			1 11/19 FOR DISCUSSION AL Rev. Date Description By Client: JRNN PTY LTD C/O DEREK RAITHBY ARCHITECTURE
	open space	sunlight between 9 am and 3 pn at mid-winter	າ			For apartments at ground level o structure, a private open space is must have a minimum area of 15	s provided instead of a balcony. It	COMPLIES		STRUCTURAL ENGINEER Consultant RAFELETOS ZANUTTINI ENGINEERS Address LVL 2, 103 VANESSA STREET, SYDNEY Phone (02) 9554 9311
	A maximum of 15% of apartment sunlight between 9 am and 3 pm	•	12%		4F Common circulation	4F-1 Common circulation spaces achieve good amenity	The maximum number of apartments off a circulation	2 CORES		e-mail admin@rafzan.com.au HYDRAULIC ENGINEER Consultant ACOR CONSULTANTS (CC) Address 58 HILLS STREET, GOSFORD 2250
4B Natural ventilation	4B-1 All habitable rooms are naturally ventilated 4B-2 The layout and design	At least 60% of apartments are naturally cross ventilated in the first nine storeys of the building.					core on a single level is 8			Phone (02) 4323 3499 e-mail RHamilton@acor.com.au MECHANICAL ENGINEER
	of single aspect apartments maximises natural ventilation 4B-3 The number of	Overall depth of a cross-over or cross-through apartment does not exceed 18m, measured			4G Storage	designed storage is provided	Minimum volume requirement for storage			Consultant RMJ ENGINEERS 7 RING Address STREET, BELMORE NSW 2192 Phone (02) 8540 3461 e-mail jsabbouh@rmjengineer.com.au
	apartments with natural cross ventilation is maximised to create a comfortable indoor environment for residents	glass line to glass line				in each apartment	Dwelling type Storage size volume Studio 4m³ 1br 6m³ 2br 8m³	CAN COMPLY		LANDSCAPE DESIGN Consultant CONZEPT LANDSCAPE ARCHITECTS Address 101/506 MILLERS STREET, CAMMERAY 2062 Phone (02) 9922 5312 e-mail rob@conzept.net.au BASIX/ SECTION J
4C Ceiling heights	4C-1 Ceiling height achieves sufficient natural ventilation and daylight access	Habitable rooms 2.7m Non-habitable rooms 2.4m	2.7m 2.4m				At least 50% of storage within the apartment			Consultant Address PARTNERS ENERGY P.O. BOX 185 ALSTONEVILLE 2477 Phone 0421 381 005 david@partnersenergy.com.au Project:
	4D-1 The layout of rooms within an apartment is functional, well organised and provides a high standard of amenity	Dwelling typeMin. sizeStudio $35m^2$ 1br $50m^2$ 2br $70m^2$ 3br $90m^2$	CAN COMPLY							RESIDENTIAL DEVELOPMENT 36 LONSDALE STREET & 64 - 70 BRENAN STREET, LILYFIELD DRAWING TITLE ADG COMPLIANCE SUMMARY Date: Drawing No. Scale: 1:1@A1 1:0@A3 Project No. 1919
		additional bathroom 5m ² 4 th bed and further bathroom – extra 12								Drawn/Checked PRELIMINARY

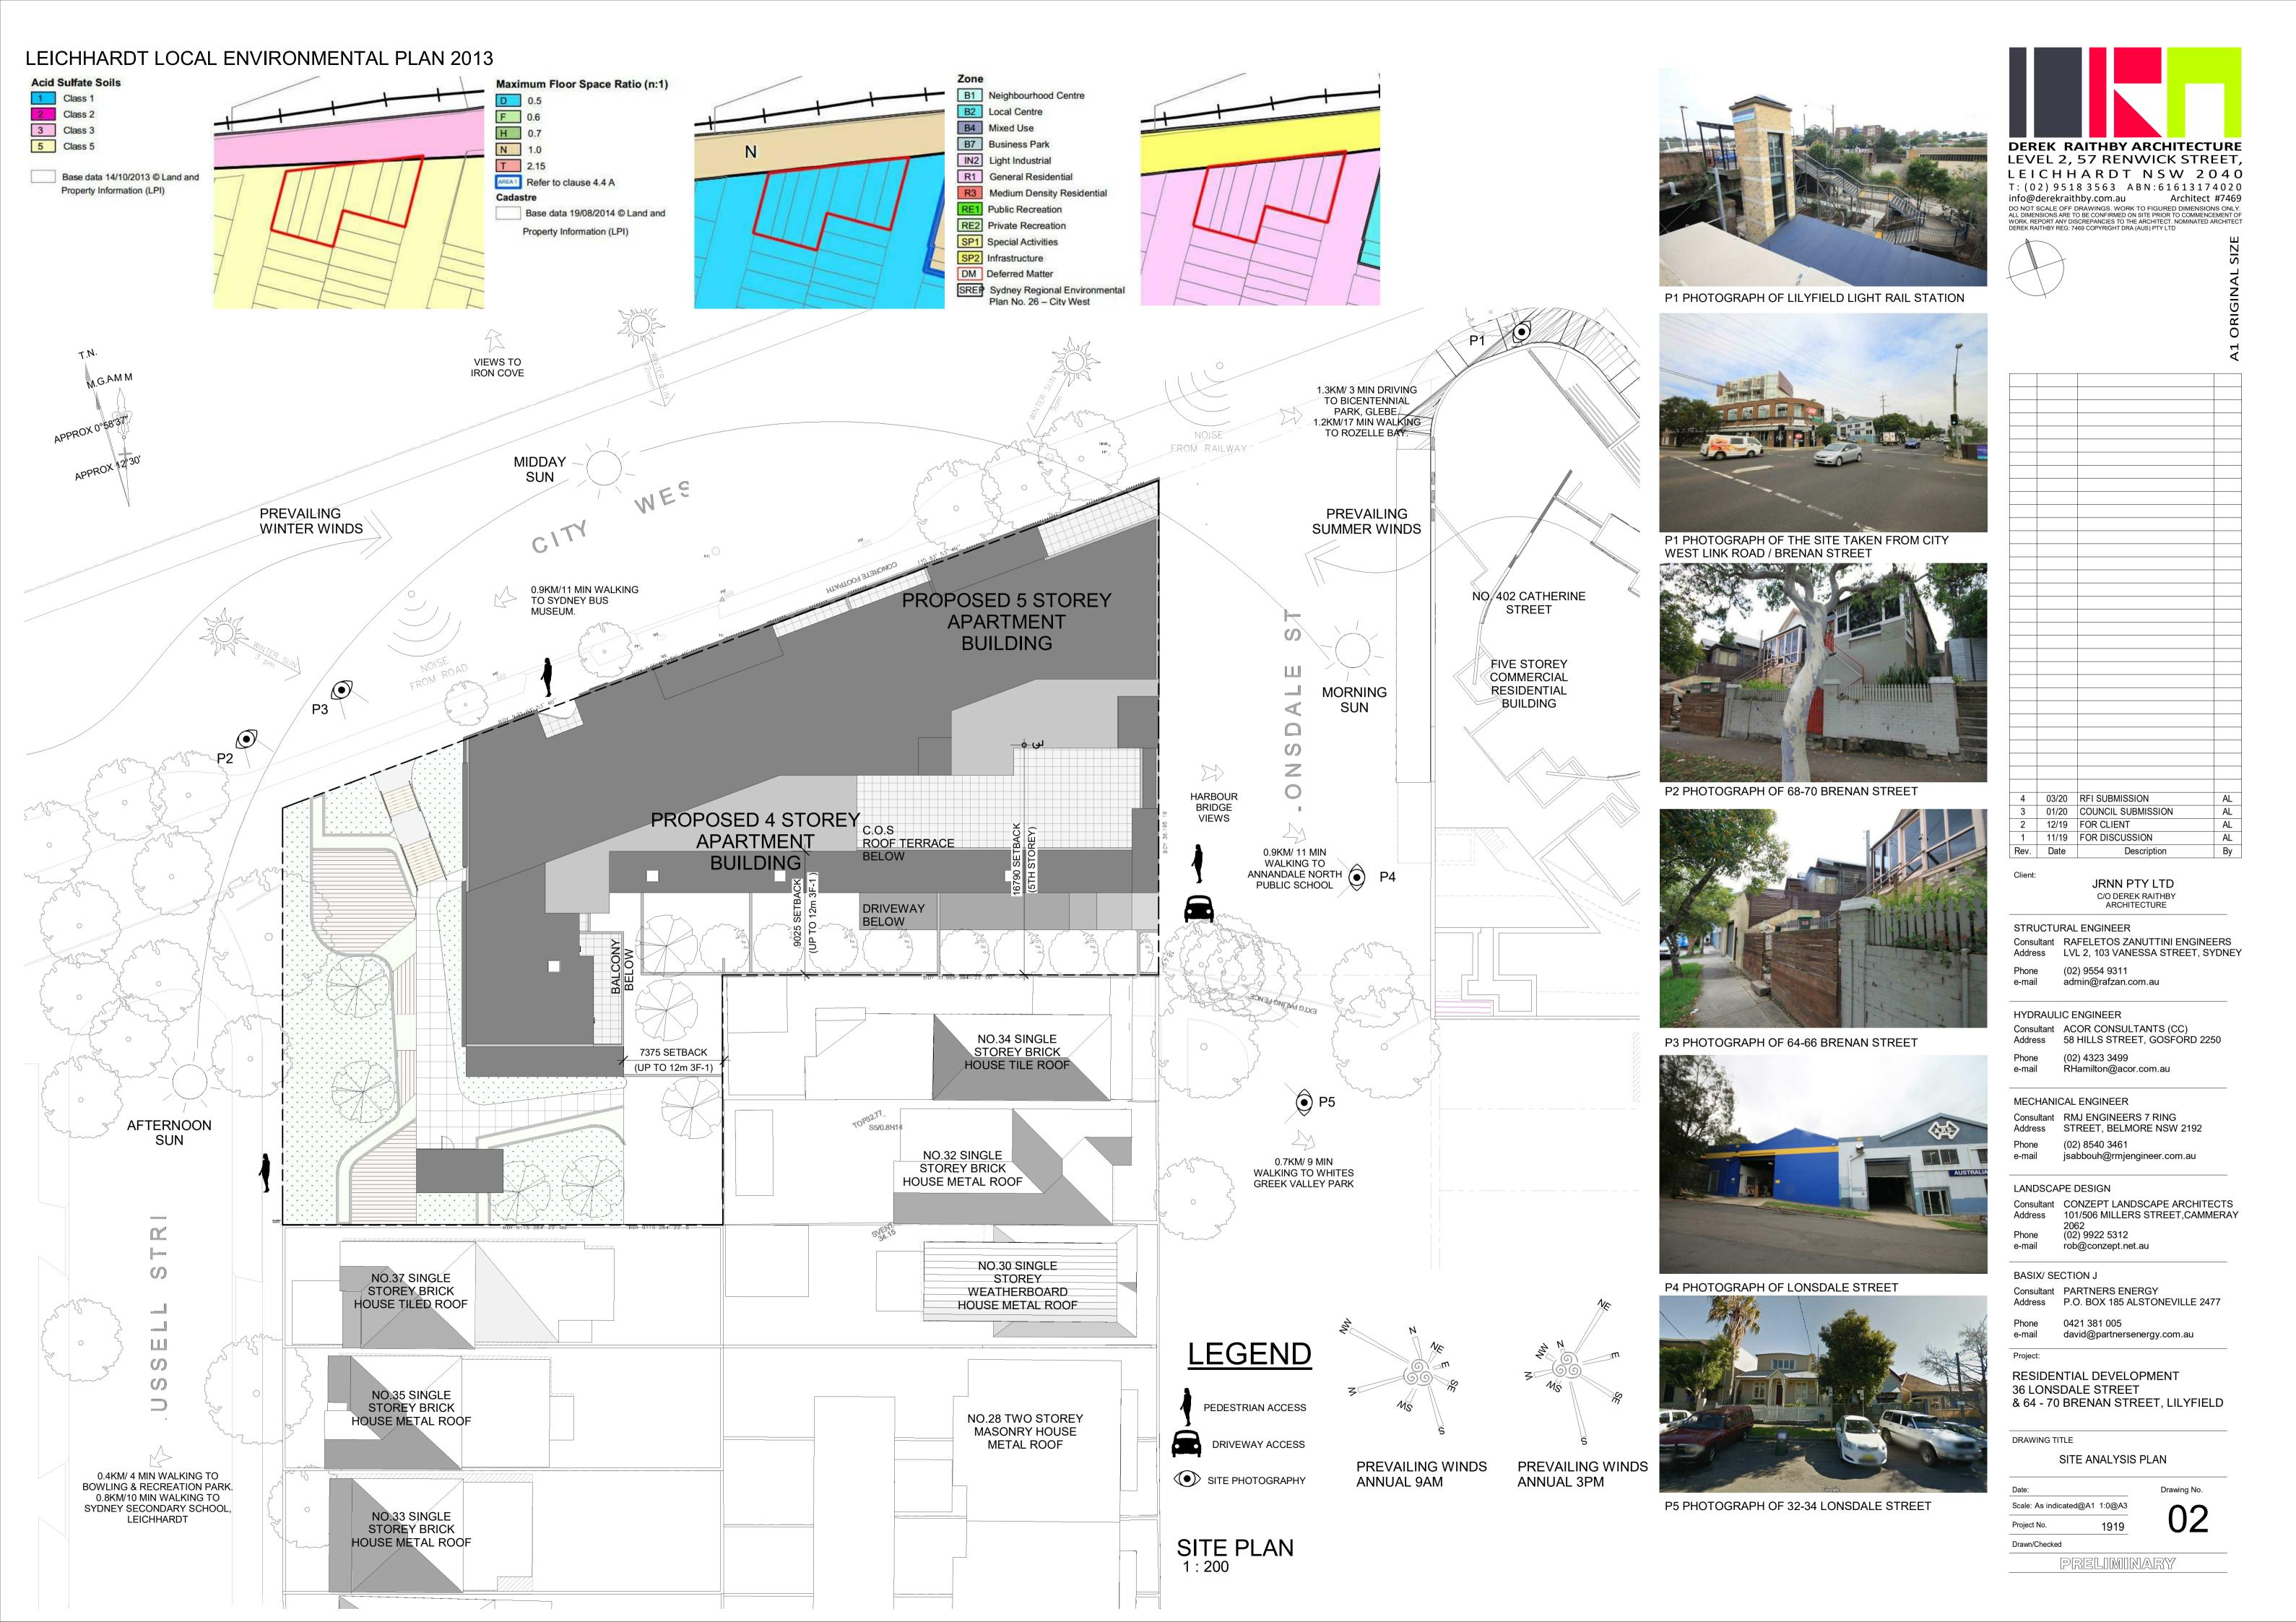

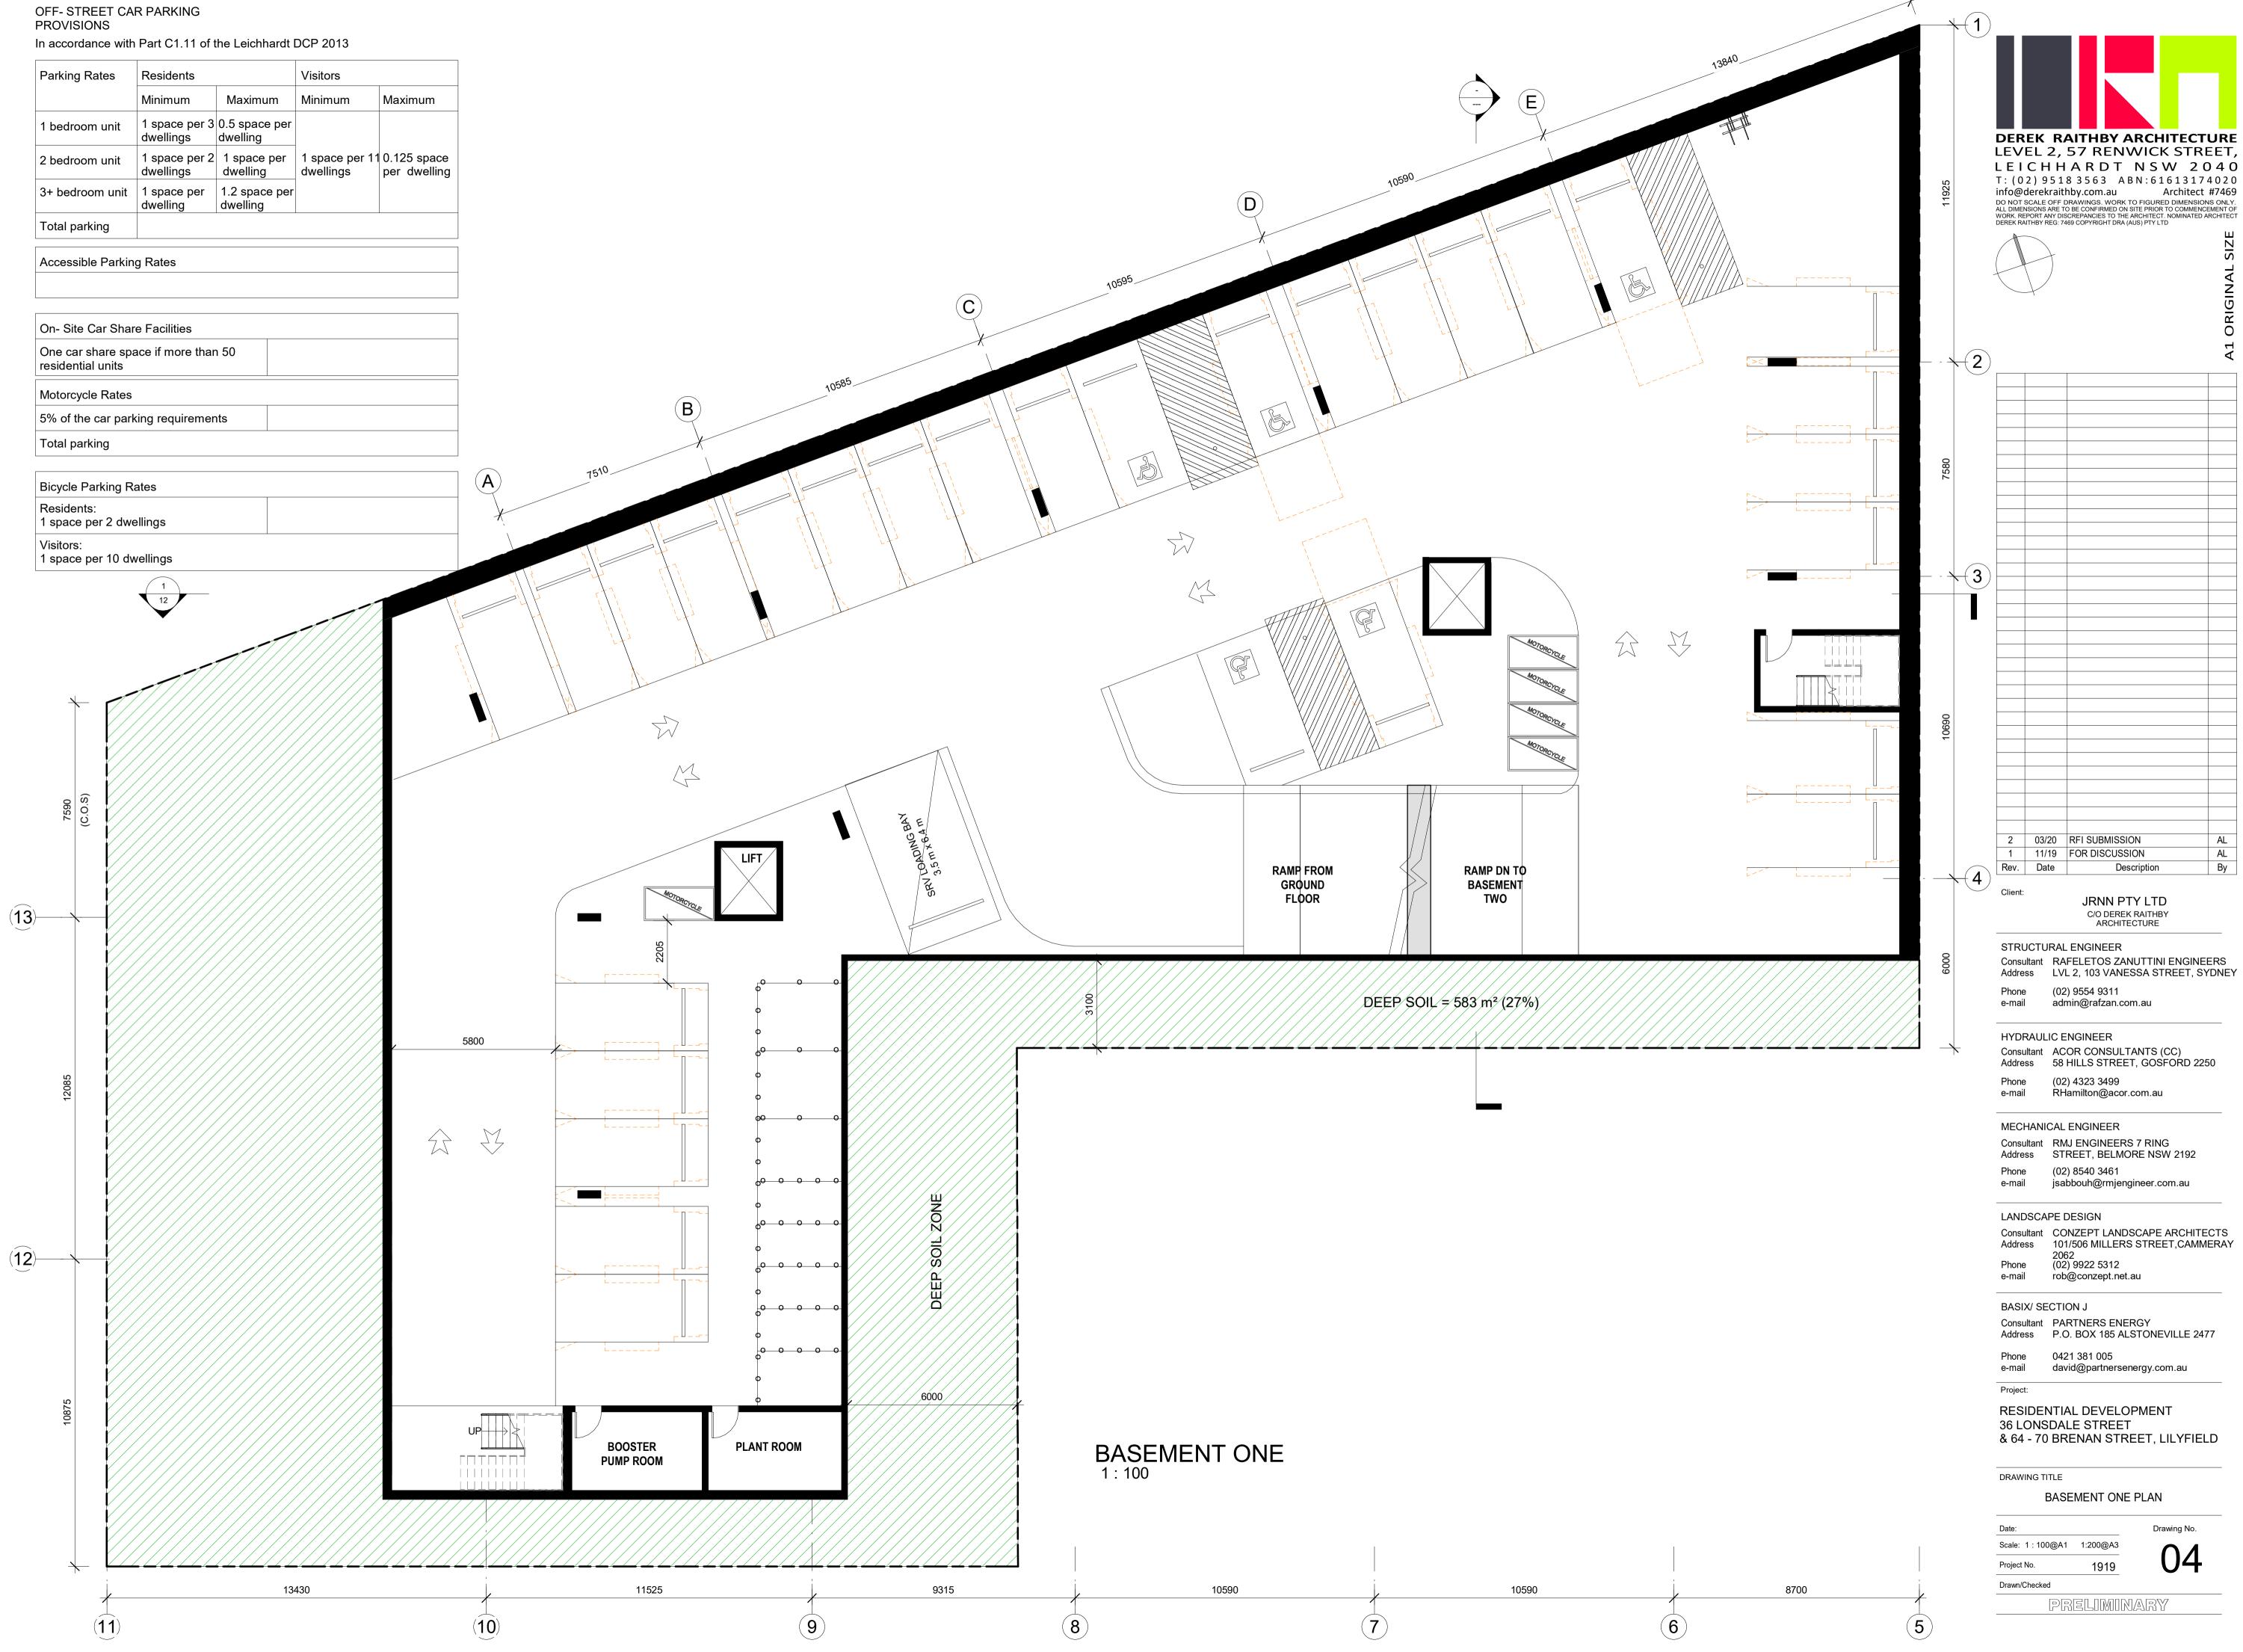
















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info@derekraithby.com.au Architect #7469
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North Elevation



South Elevation

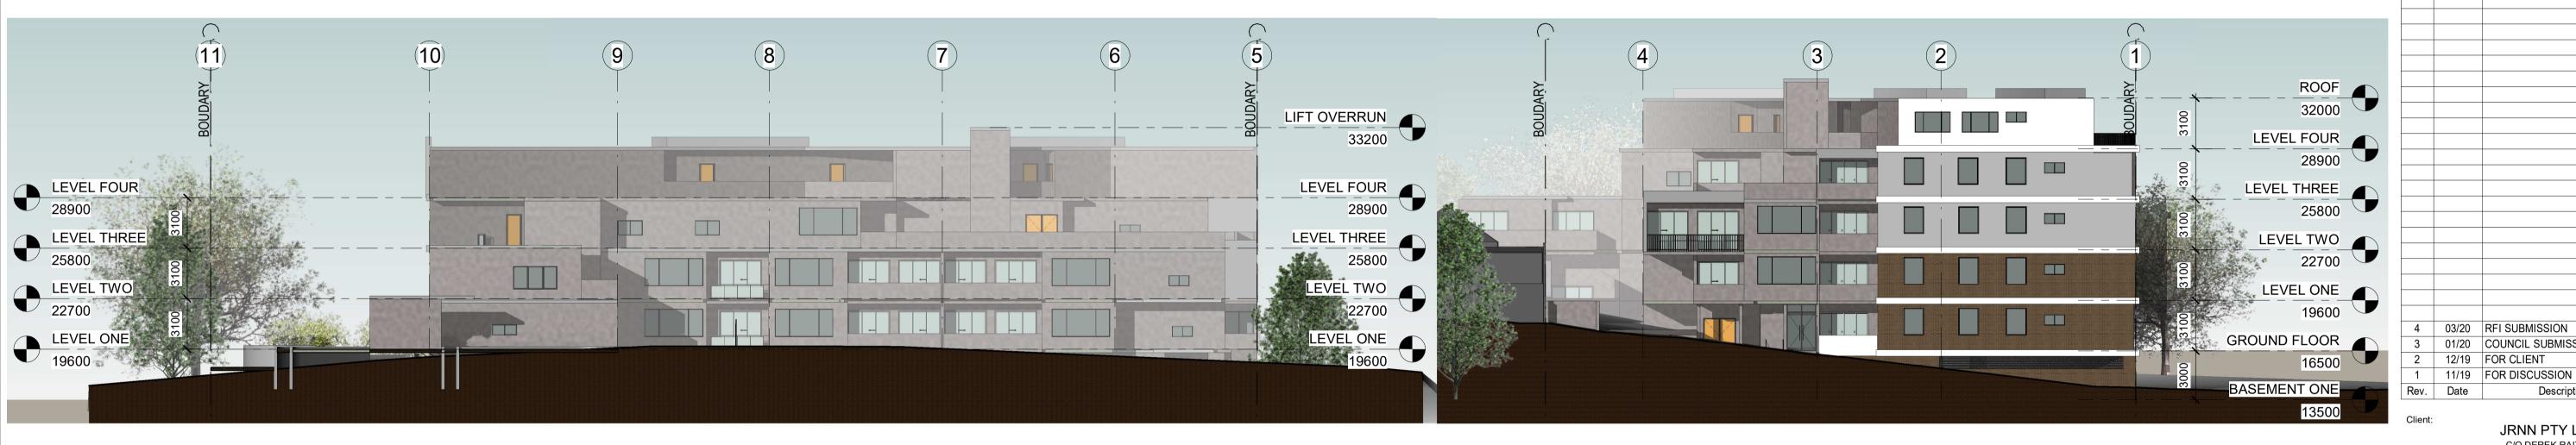East Elevation



West Elevation
1:200

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RESIDENTIAL DEVELOPMENT 36 LONSDALE STREET & 64 - 70 BRENAN STREET, LILYFIELD


DRAWING TITLE

ELEVATIONS

Date:	
Scale: 1:200@A1	1:400@
Project No.	191

Drawn/Checked



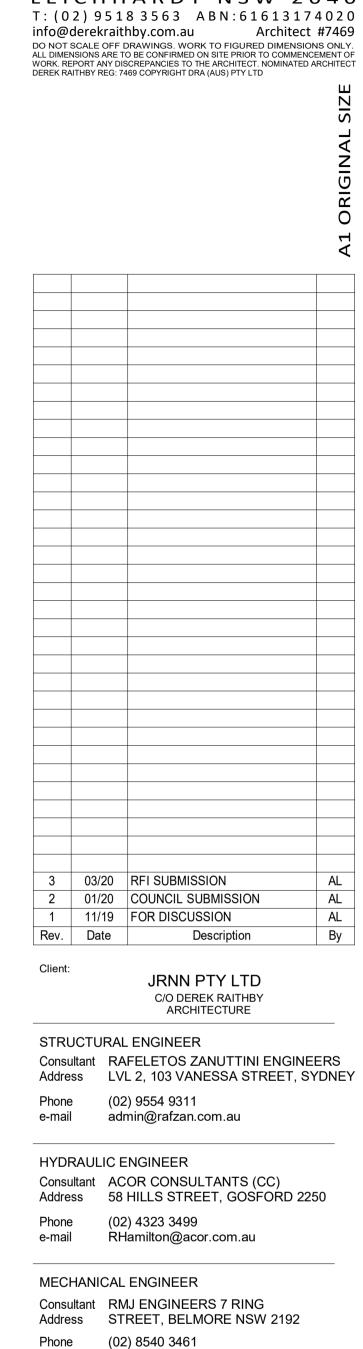

AL AL By

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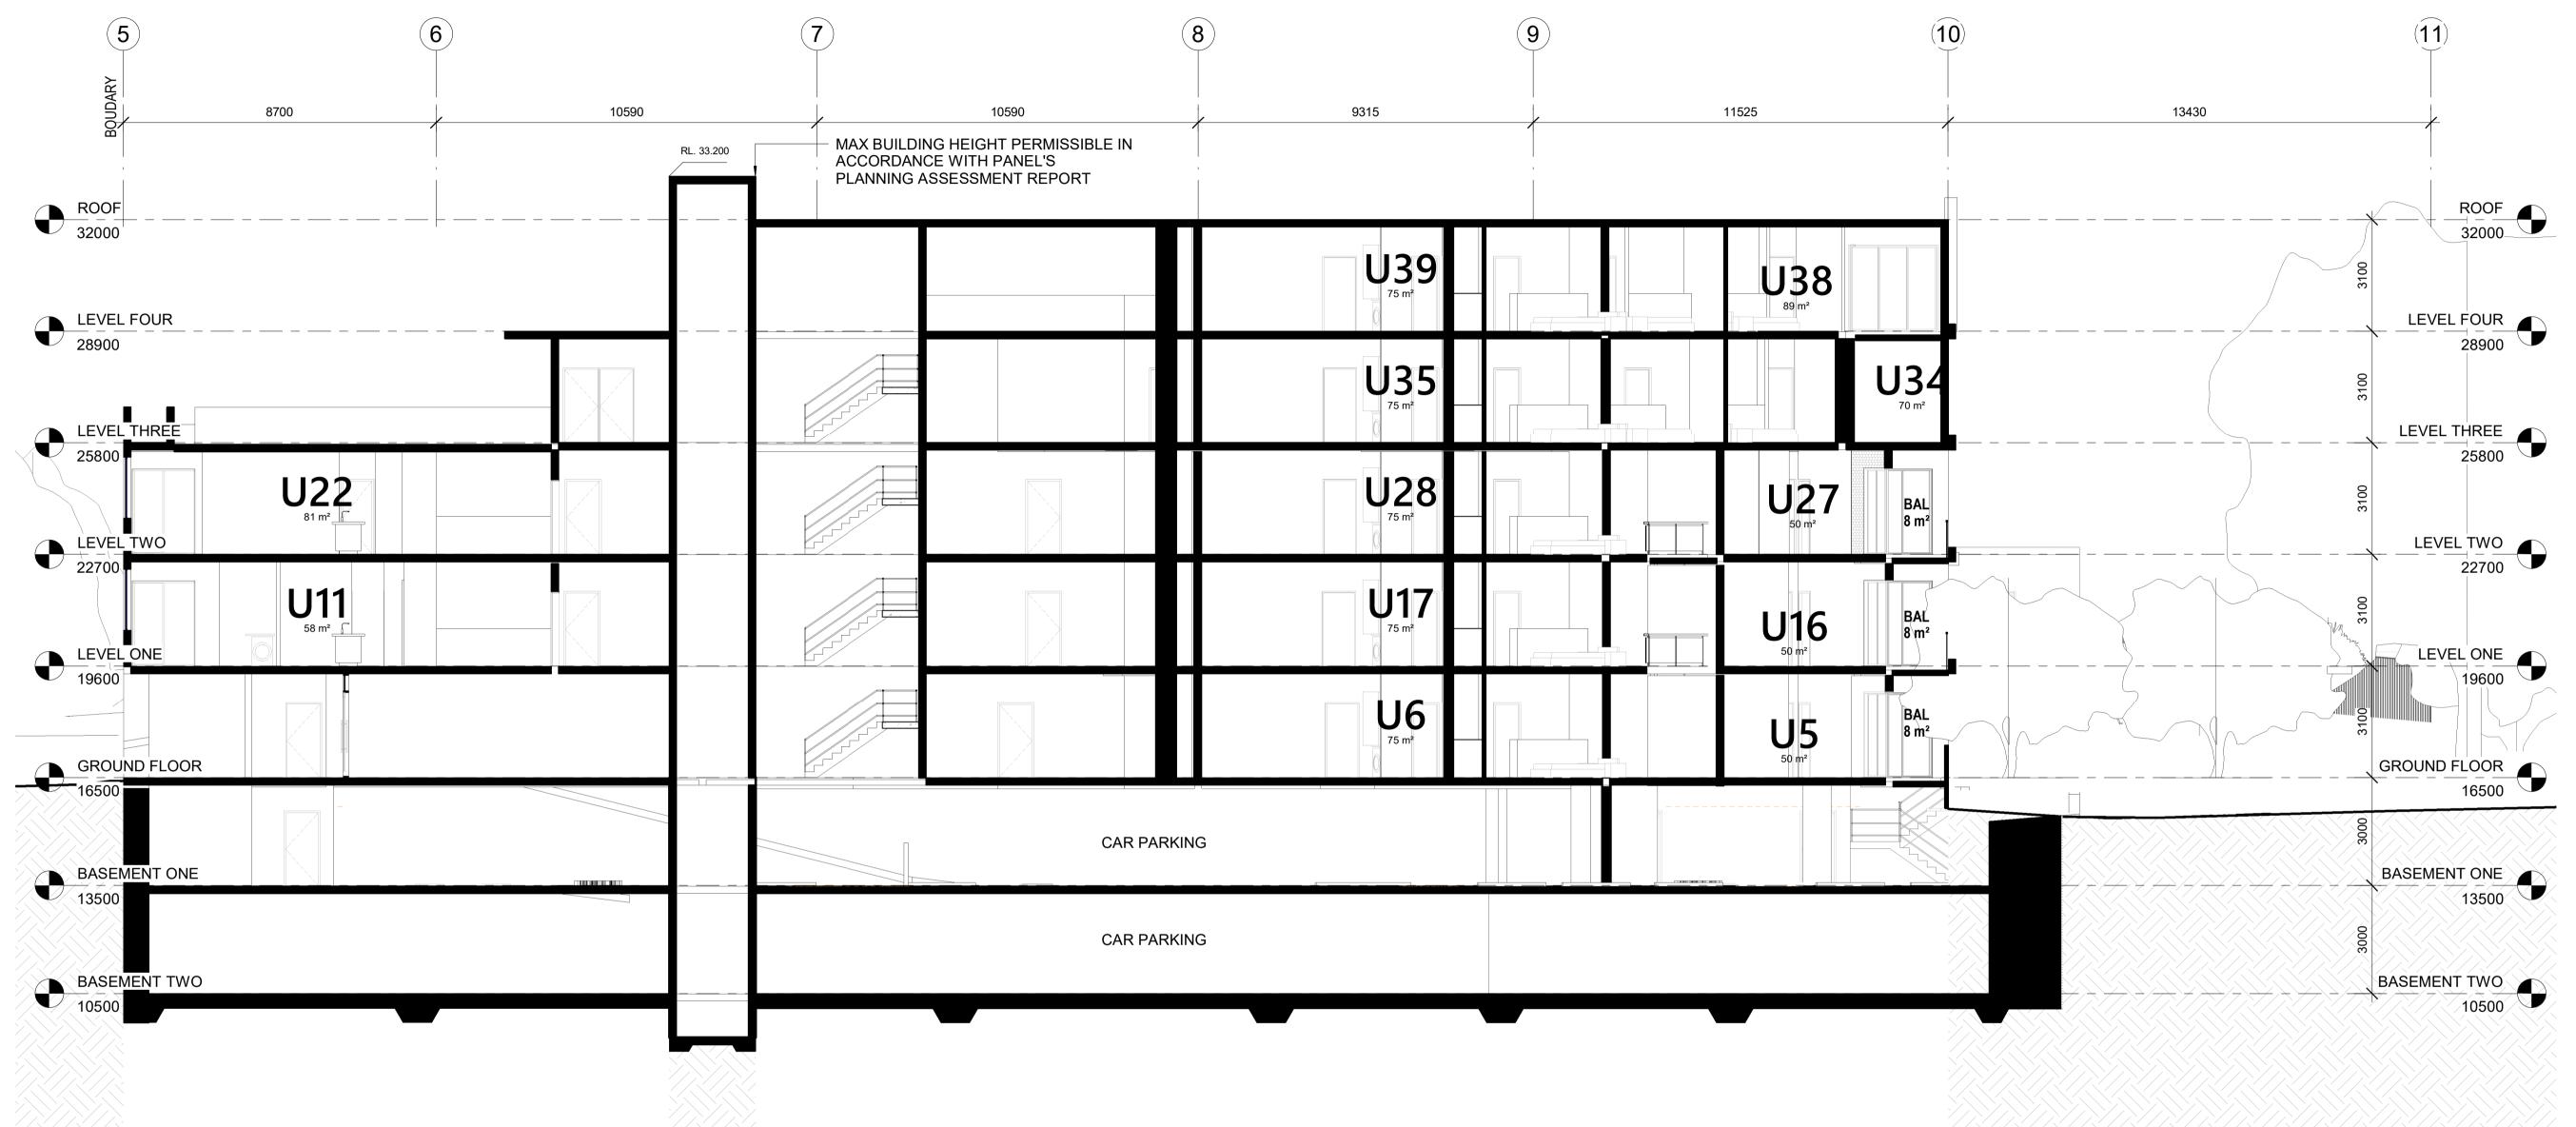
RESIDENTIAL DEVELOPMENT 36 LONSDALE STREET & 64 - 70 BRENAN STREET, LILYFIELD

DRAWING TITLE


SECTIONS

Drawing No. Scale: 1:100@A1 1:200@A3 Project No. 1919 Drawn/Checked


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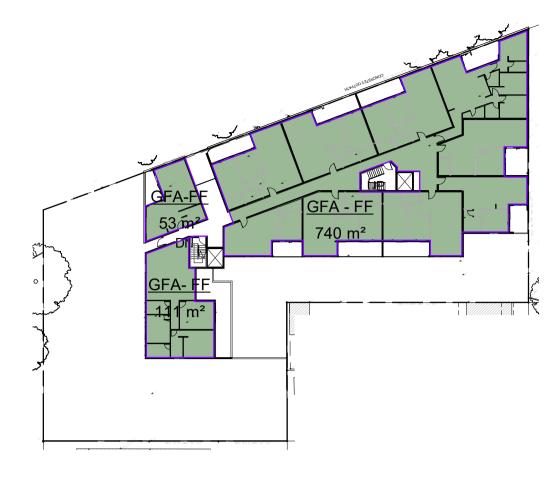
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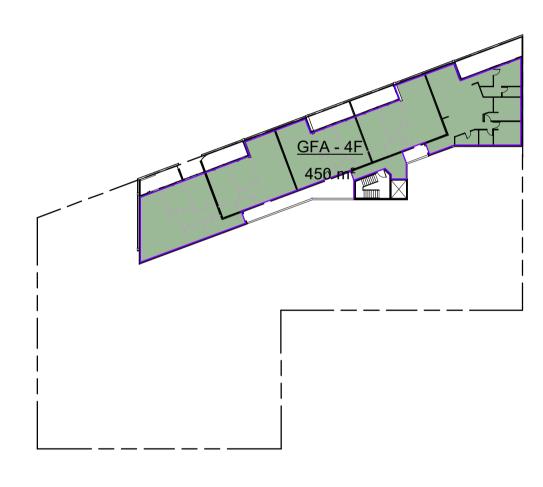
GFA Diagram - Ground Floor Plan




GFA Diagram - Third Floor Plan

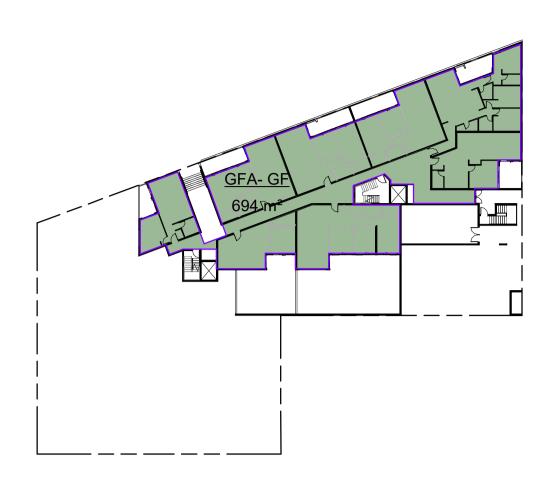

GFA Diagram - First Floor Plan

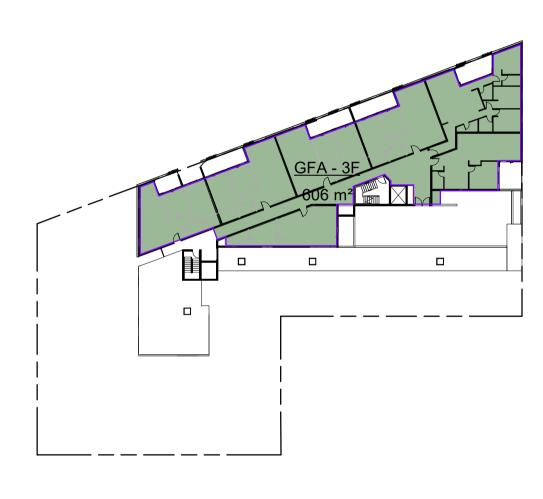

GFA Diagram - Fourth Floor Plan

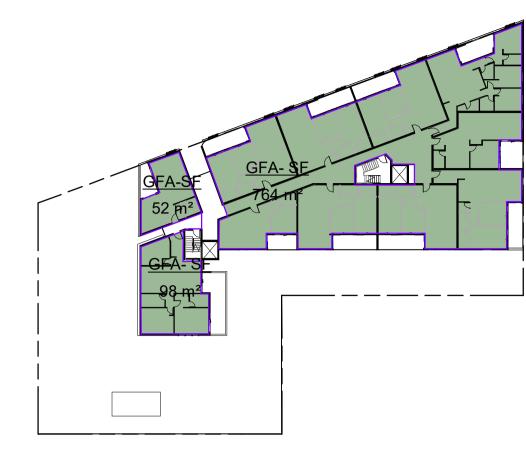

GFA Diagram - Second Floor Plan

AREA CALCULATION - GROSS FLOOR AREA					
SITE AREA	SITE AREA TOTAL AREA FSR FSR				
2145 m²	3568 m²	1.66	2.0		

GROSS FLOOR AREA

means the sum of the floor area of each floor of a building measured from the internal face of external walls, or from the internal face of walls separating the building from any other building, measured at a height of 1.4 metres above the floor, and includes—

(a) the area of a mezzanine, and

(b) habitable rooms in a basement or an attic, and

(c) any shop, auditorium, cinema, and the like, in a basement or attic, but excludes—

(d) any area for common vertical circulation, such as lifts and stairs, and

(e) any basement— (i) storage, and

(ii) vehicular access, loading areas, garbage and services, and

(f) plant rooms, lift towers and other areas used exclusively for mechanical services or ducting, and (g) car parking to meet any requirements of the consent authority (including access to that car parking),

(h) any space used for the loading or unloading of goods (including access to it), and

(i) terraces and balconies with outer walls less than 1.4 metres high, and (j) voids above a floor at the level of a storey or storey above.

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0421 381 005

david@partnersenergy.com.au


RESIDENTIAL DEVELOPMENT 36 LONSDALE STREET & 64 - 70 BRENAN STREET, LILYFIELD

DRAWING TITLE

Drawn/Checked

DIAGRAM - GFA

Scale: As indicated@A1 1:0@A3 1919

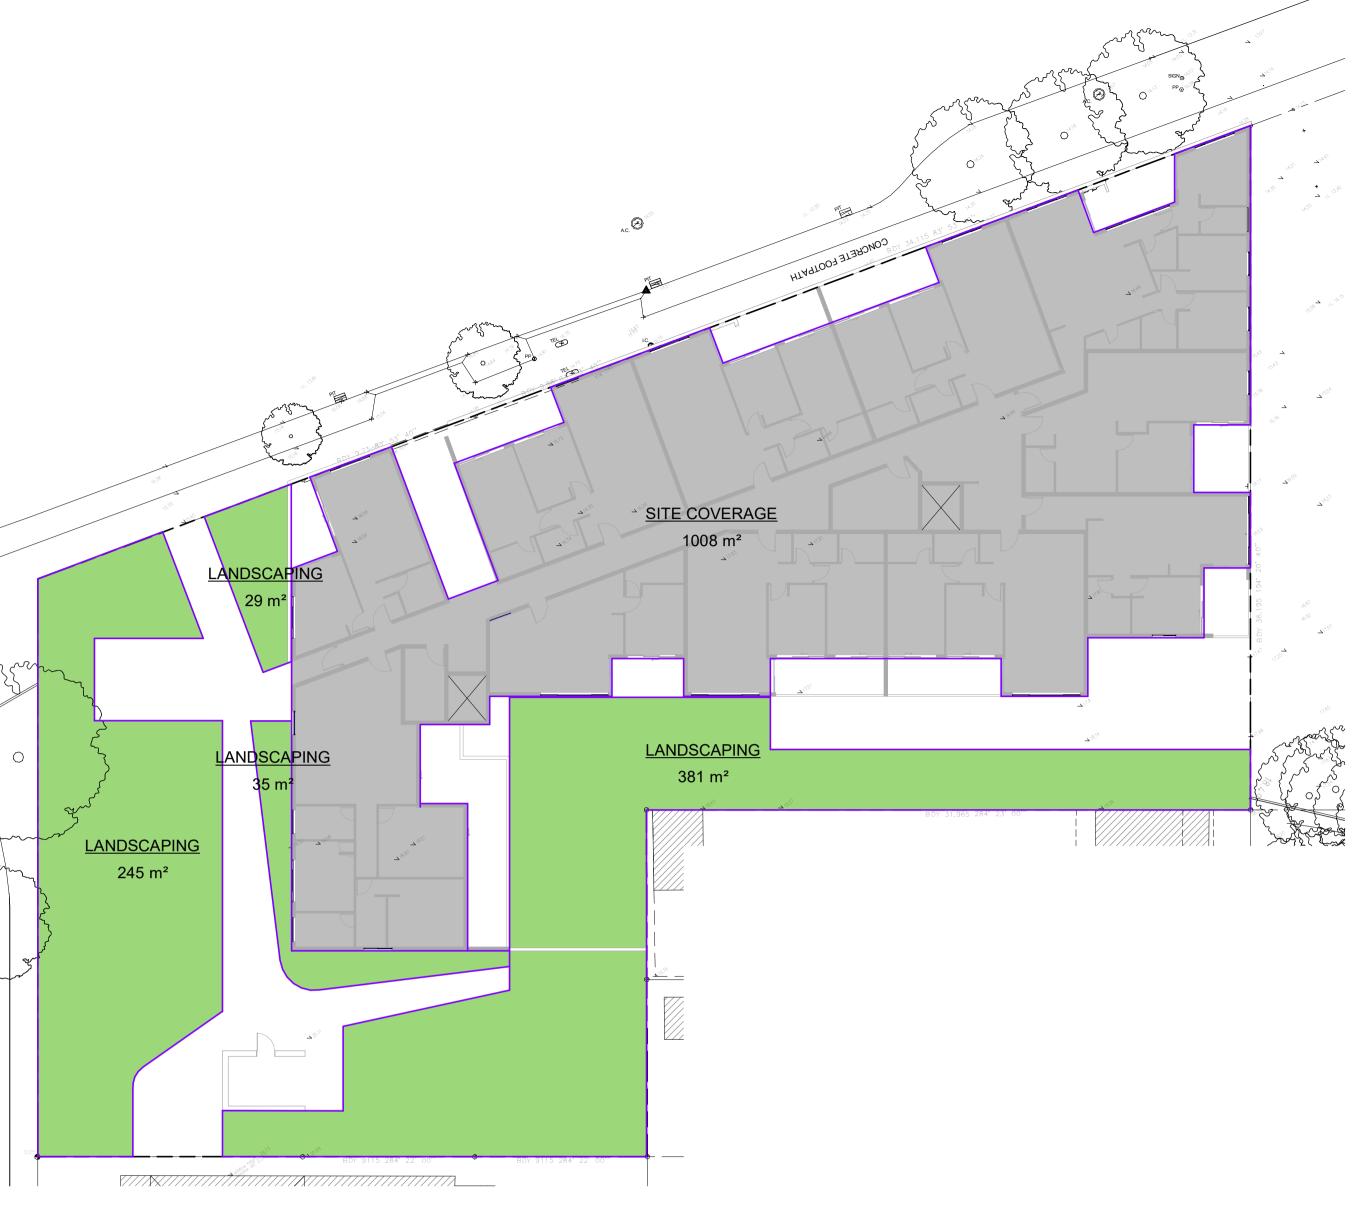

Landscaping & Site Coverage Calculation - Level 1

LEICHHARDT DEVELOPMENT CONTROL PLAN 2013

4.3A LANDSCAPED AREAS FOR RESIDENTIAL ACCOMMODATION IN ZONE R1

- (1) The objectives of this clause are as follows—
- (a) to provide landscaped areas that are suitable for substantial tree planting and for the use and enjoyment of residents,
- (b) to maintain and encourage a landscaped corridor between adjoining properties, (c) to ensure that development promotes the desired future character of the
- neighbourhood,
- (d) to encourage ecologically sustainable development by maximising the retention and absorption of surface drainage water on site and by minimising obstruction to the underground flow of water,
- (e) to control site density,
- (f) to limit building footprints to ensure that adequate provision is made for landscaped areas and private open space.
- (2) This clause applies to development for the purpose of residential accommodation on land in Zone R1 General Residential.
- (3) Development consent must not be granted to development to which this clause applies unless-
- (a) the development includes landscaped area that comprises at least—
- (i) where the lot size is equal to or less than 235 square metres—15% of the site area, or
- (ii) where the lot size is greater than 235 square metres—20% of the site area, and
- (b) the site coverage does not exceed 60% of the site area. (4) For the purposes of subclause (3)—
- (a) the site area is to be calculated under clause 4.5 (3), and
- (b) any area that—
- (i) has a length or a width of less than 1 metre, or
- (ii) is greater than 500mm above ground level (existing),
- is not to be included in calculating the proportion of landscaped area, and
- (c) any deck or balcony or the like (whether enclosed or unenclosed) is not to be included in calculating the site coverage if—
- (i) it is 2.4 metres or more above ground level (existing), as measured from the underside of the structure and the area below the structure is able to be landscaped or used for recreational purposes, or
- (ii) the finished floor level is 500mm or less above ground level (existing).

Site coverage means the proportion of a site area covered by buildings. However, the following are not included for the purpose of calculating site coverage—

- (a) any basement.
- (b) any part of an awning that is outside the outer walls of a building and that adjoins the street frontage or other site boundary,
- (c) any eaves,
- (d) unenclosed balconies, decks, pergolas and the like.

Landscaped area means a part of a site used for growing plants, grasses and trees, but does not include any building, structure or hard paved area.

	AREA CALCULATION - LANDSCAPE				
Name	SITE AREA	LANDSCAPE AREA	Total %	DCP REQ.	
LANDSCA PING	2145 m²	690 m²	32%	20%	PASS

	AREA CALCUL	ATION - SITI	E COVERAGE	
SITE AREA	SITE COVERAGE AREA	%	DCP REQ.	
2145 m²	1008 m²	47%	60%	PASS



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2 01/20 COUNCIL SUBMISSION 1 11/19 FOR DISCUSSION

Client:

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0421 381 005 david@partnersenergy.com.au

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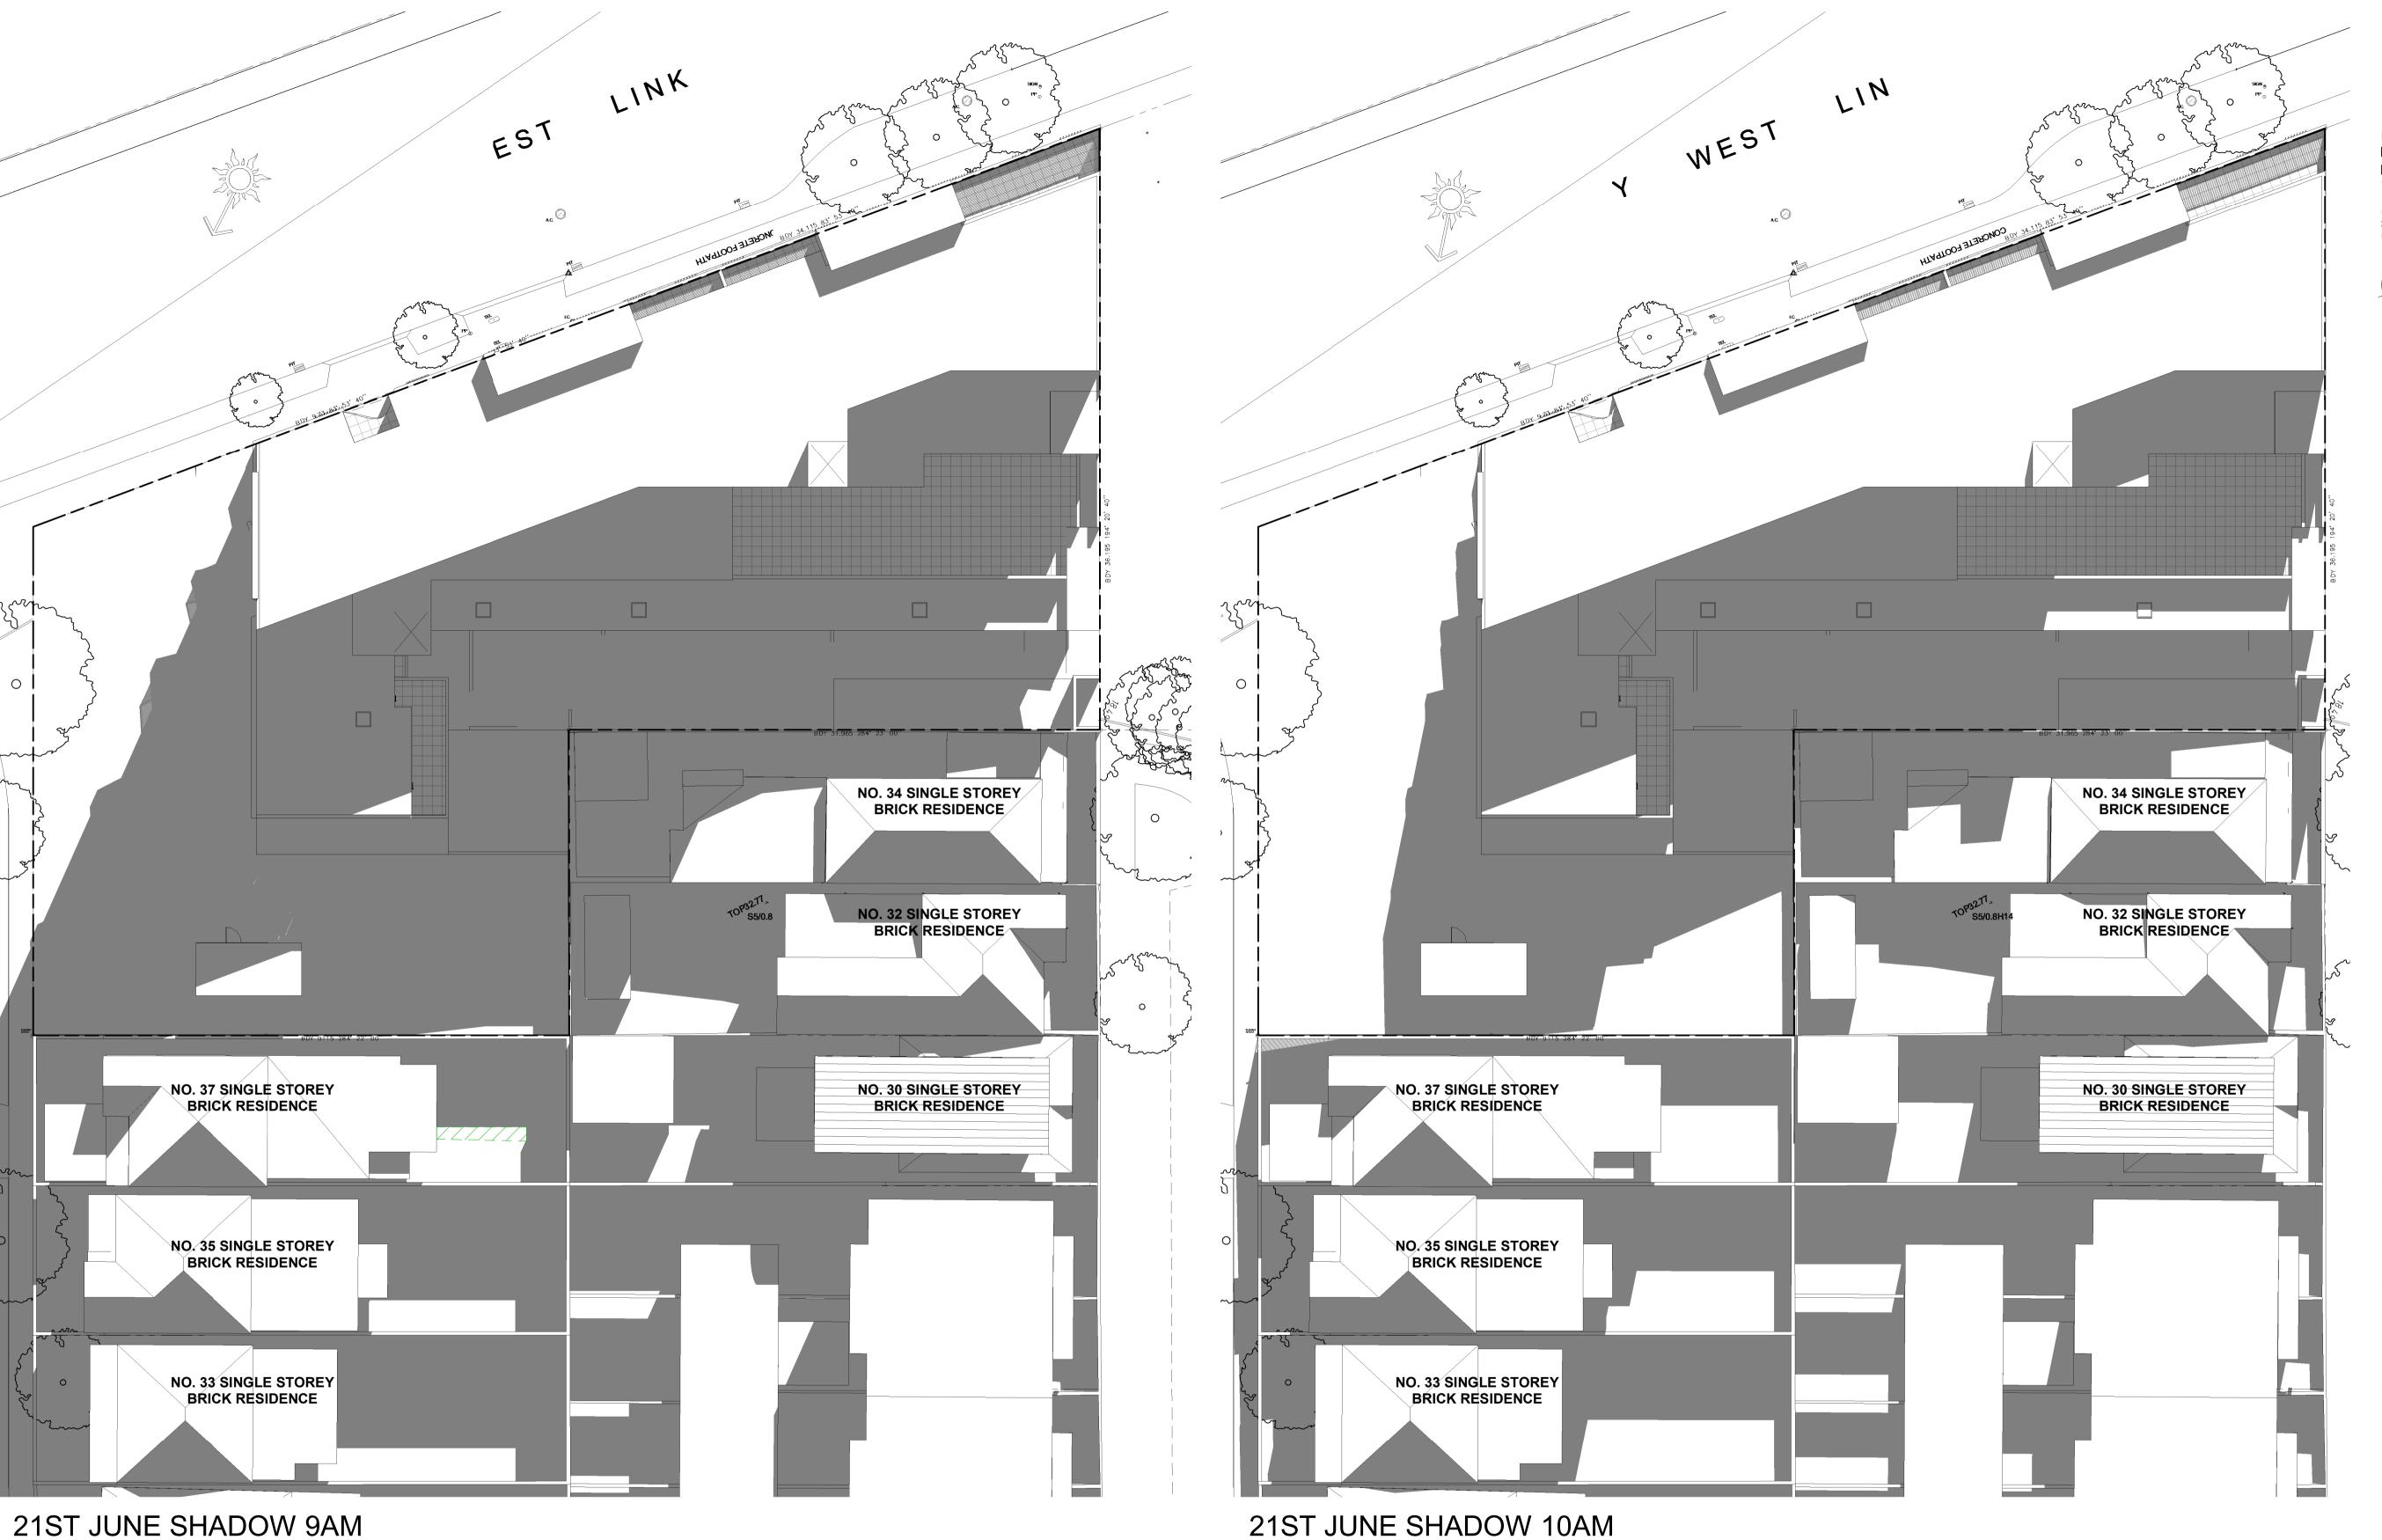
DRAWING TITLE

DIAGRAM- LANDSCAPE & COVERAGE

Scale: As indicated@A1 1:0@A3 Project No.

1919 Drawn/Checked

PRELIMINARY



1:200

LEGEND:

ADDITIONAL SHADOW CAST

REDUCTION IN SHADOW CAST


EXISTING SHADOW CAST

21ST JUNE SHADOW 10AM

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Project:

RESIDENTIAL DEVELOPMENT 36 LONSDALE STREET & 64 - 70 BRENAN STREET, LILYFIELD


DRAWING TITLE

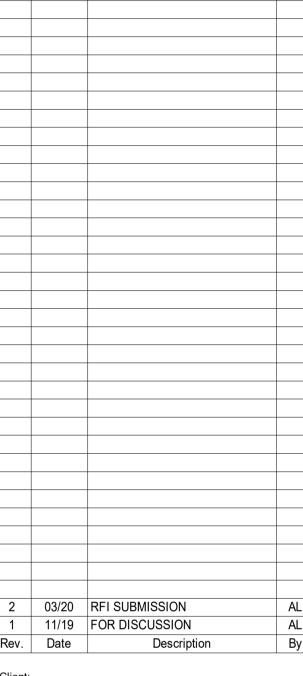DIAGRAM- SHADOW ANALYSIS 1 OF 4

Drawing No.

Scale: As indicated@A1:400@A3 Project No. 1919

Drawn/Checked

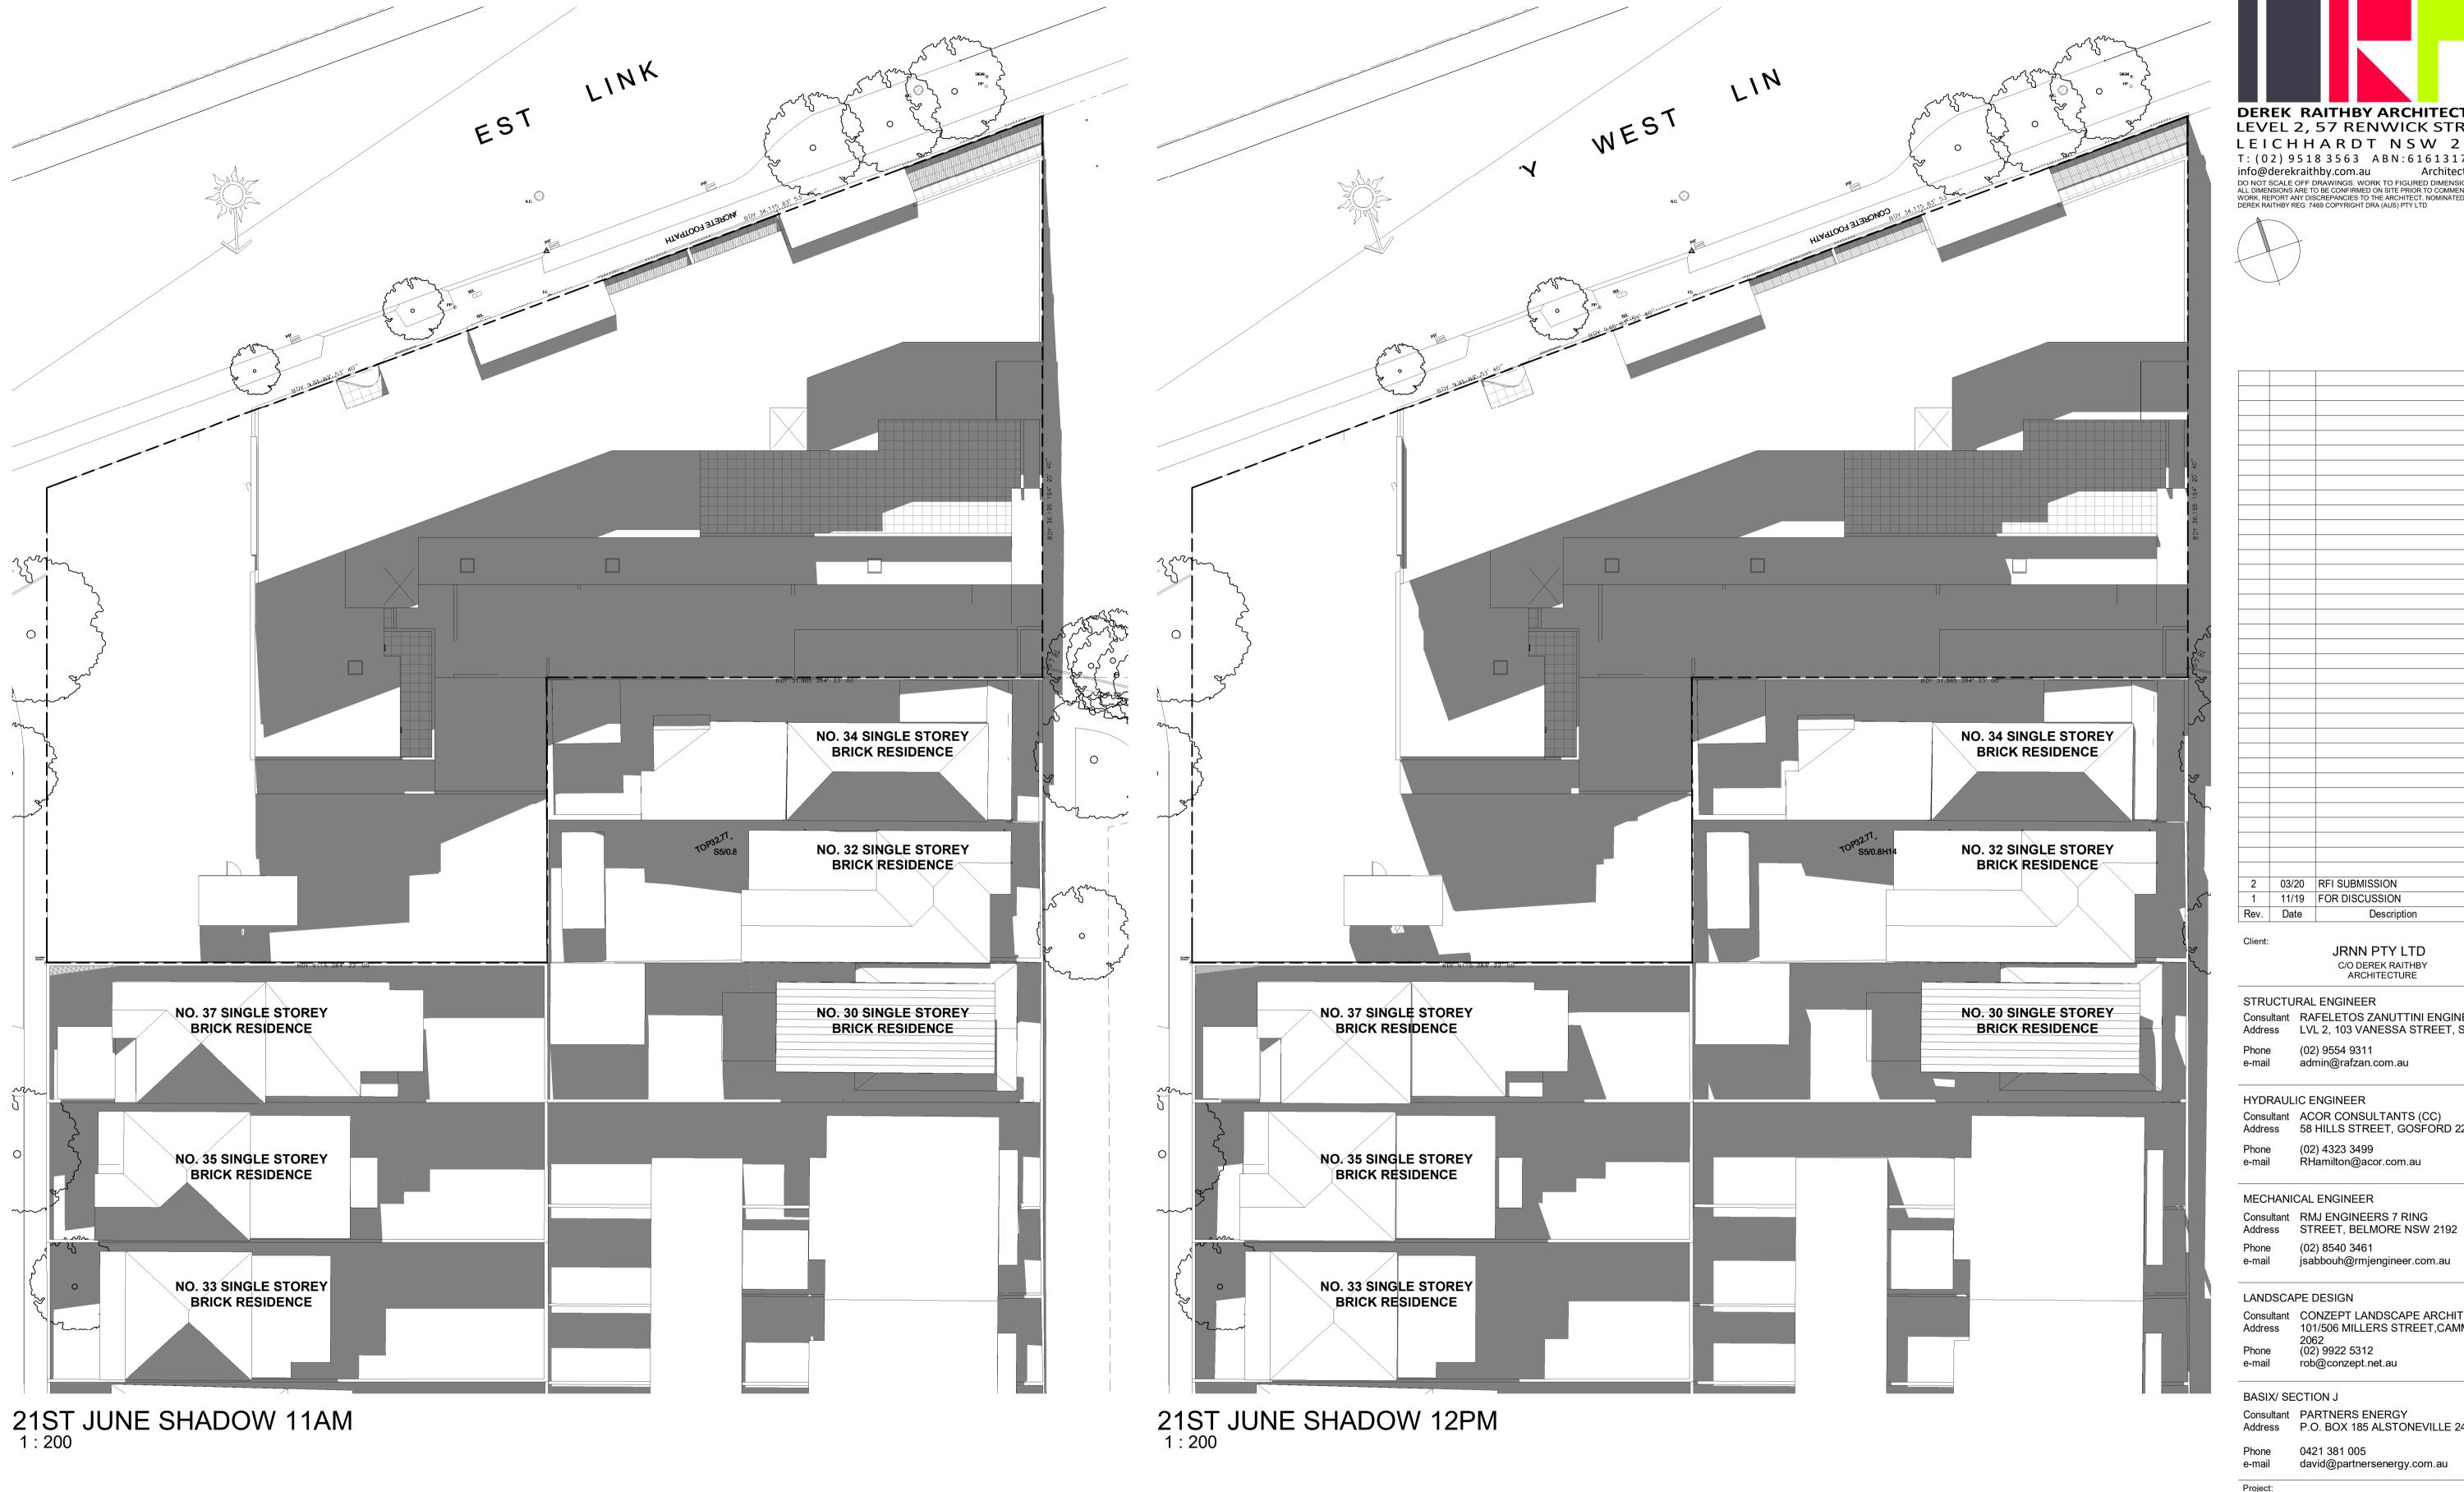

LEGEND:

ADDITIONAL SHADOW CAST

EXISTING SHADOW CAST

REDUCTION IN SHADOW CAST

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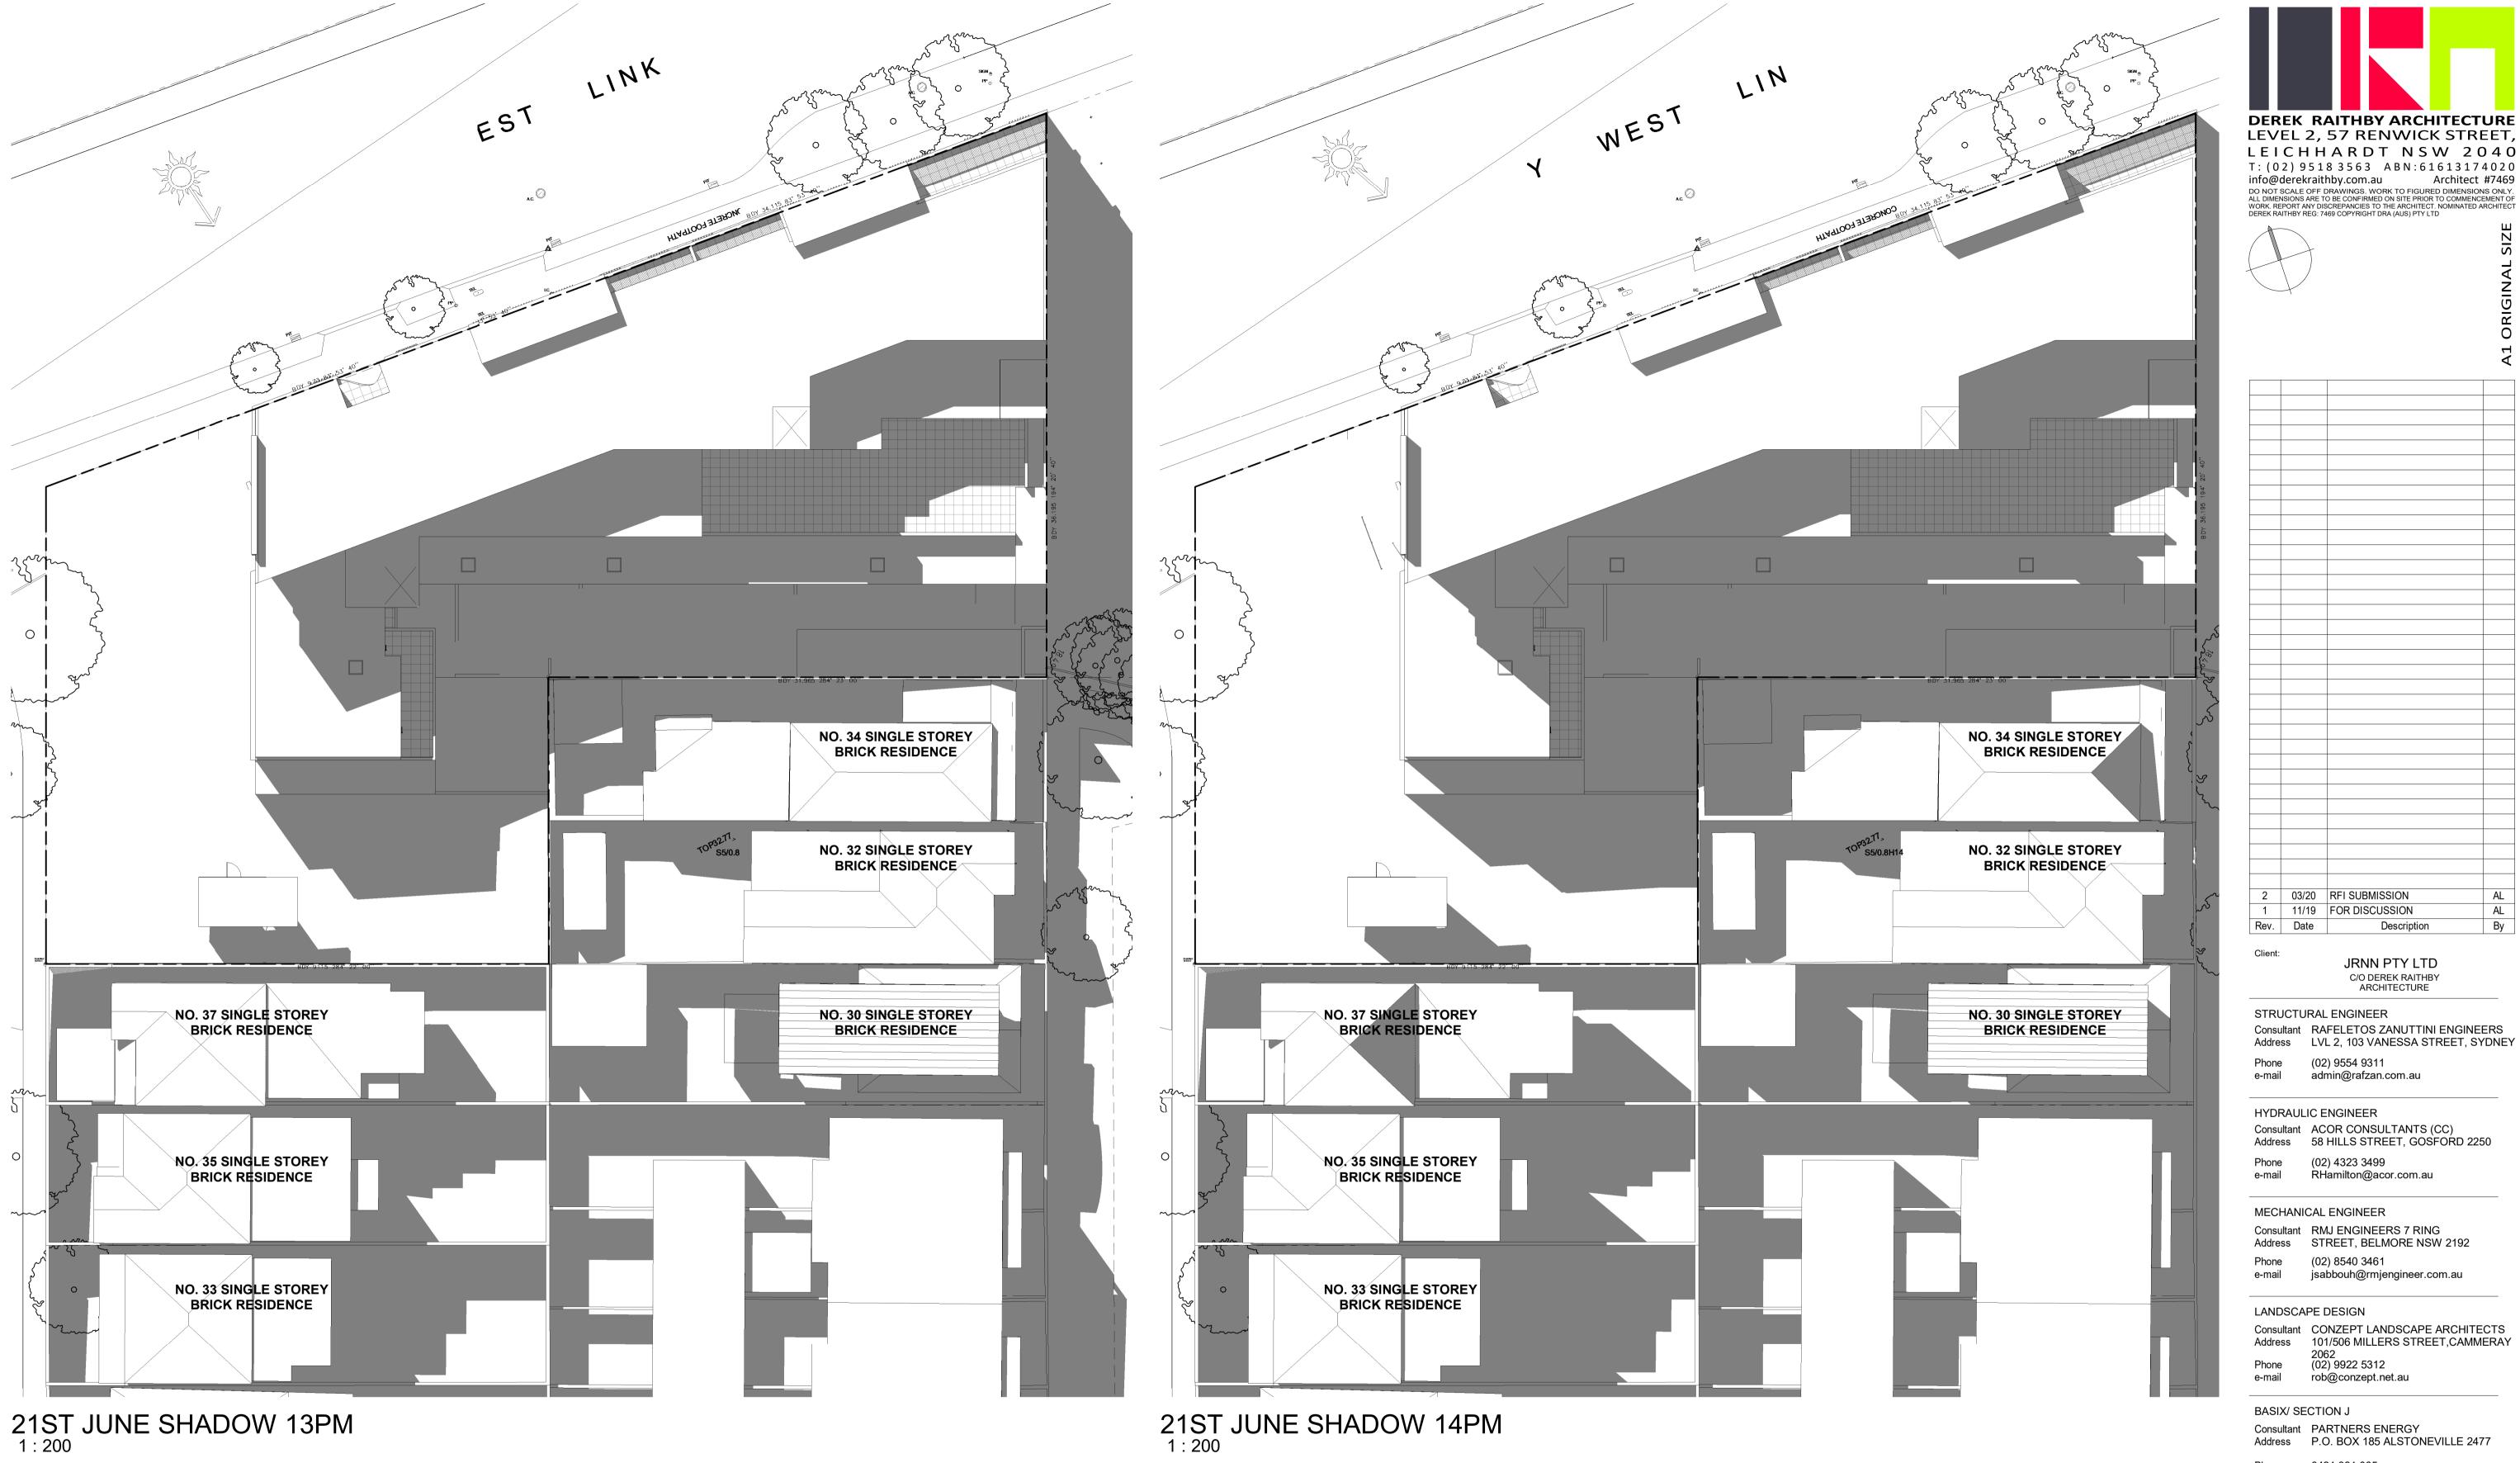
RESIDENTIAL DEVELOPMENT 36 LONSDALE STREET & 64 - 70 BRENAN STREET, LILYFIELD

DRAWING TITLE

DIAGRAM- SHADOW ANALYSIS 2 OF 4

Drawing No. Scale: As indicated@A1:400@A3 Project No. 1919

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LEGEND:

ADDITIONAL SHADOW CAST

EXISTING SHADOW CAST

REDUCTION IN SHADOW CAST

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Project:

RESIDENTIAL DEVELOPMENT

36 LONSDALE STREET & 64 - 70 BRENAN STREET, LILYFIELD


DRAWING TITLE

Drawn/Checked

DIAGRAM- SHADOW ANALYSIS 3 OF 4


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21ST JUNE SHADOW 15PM



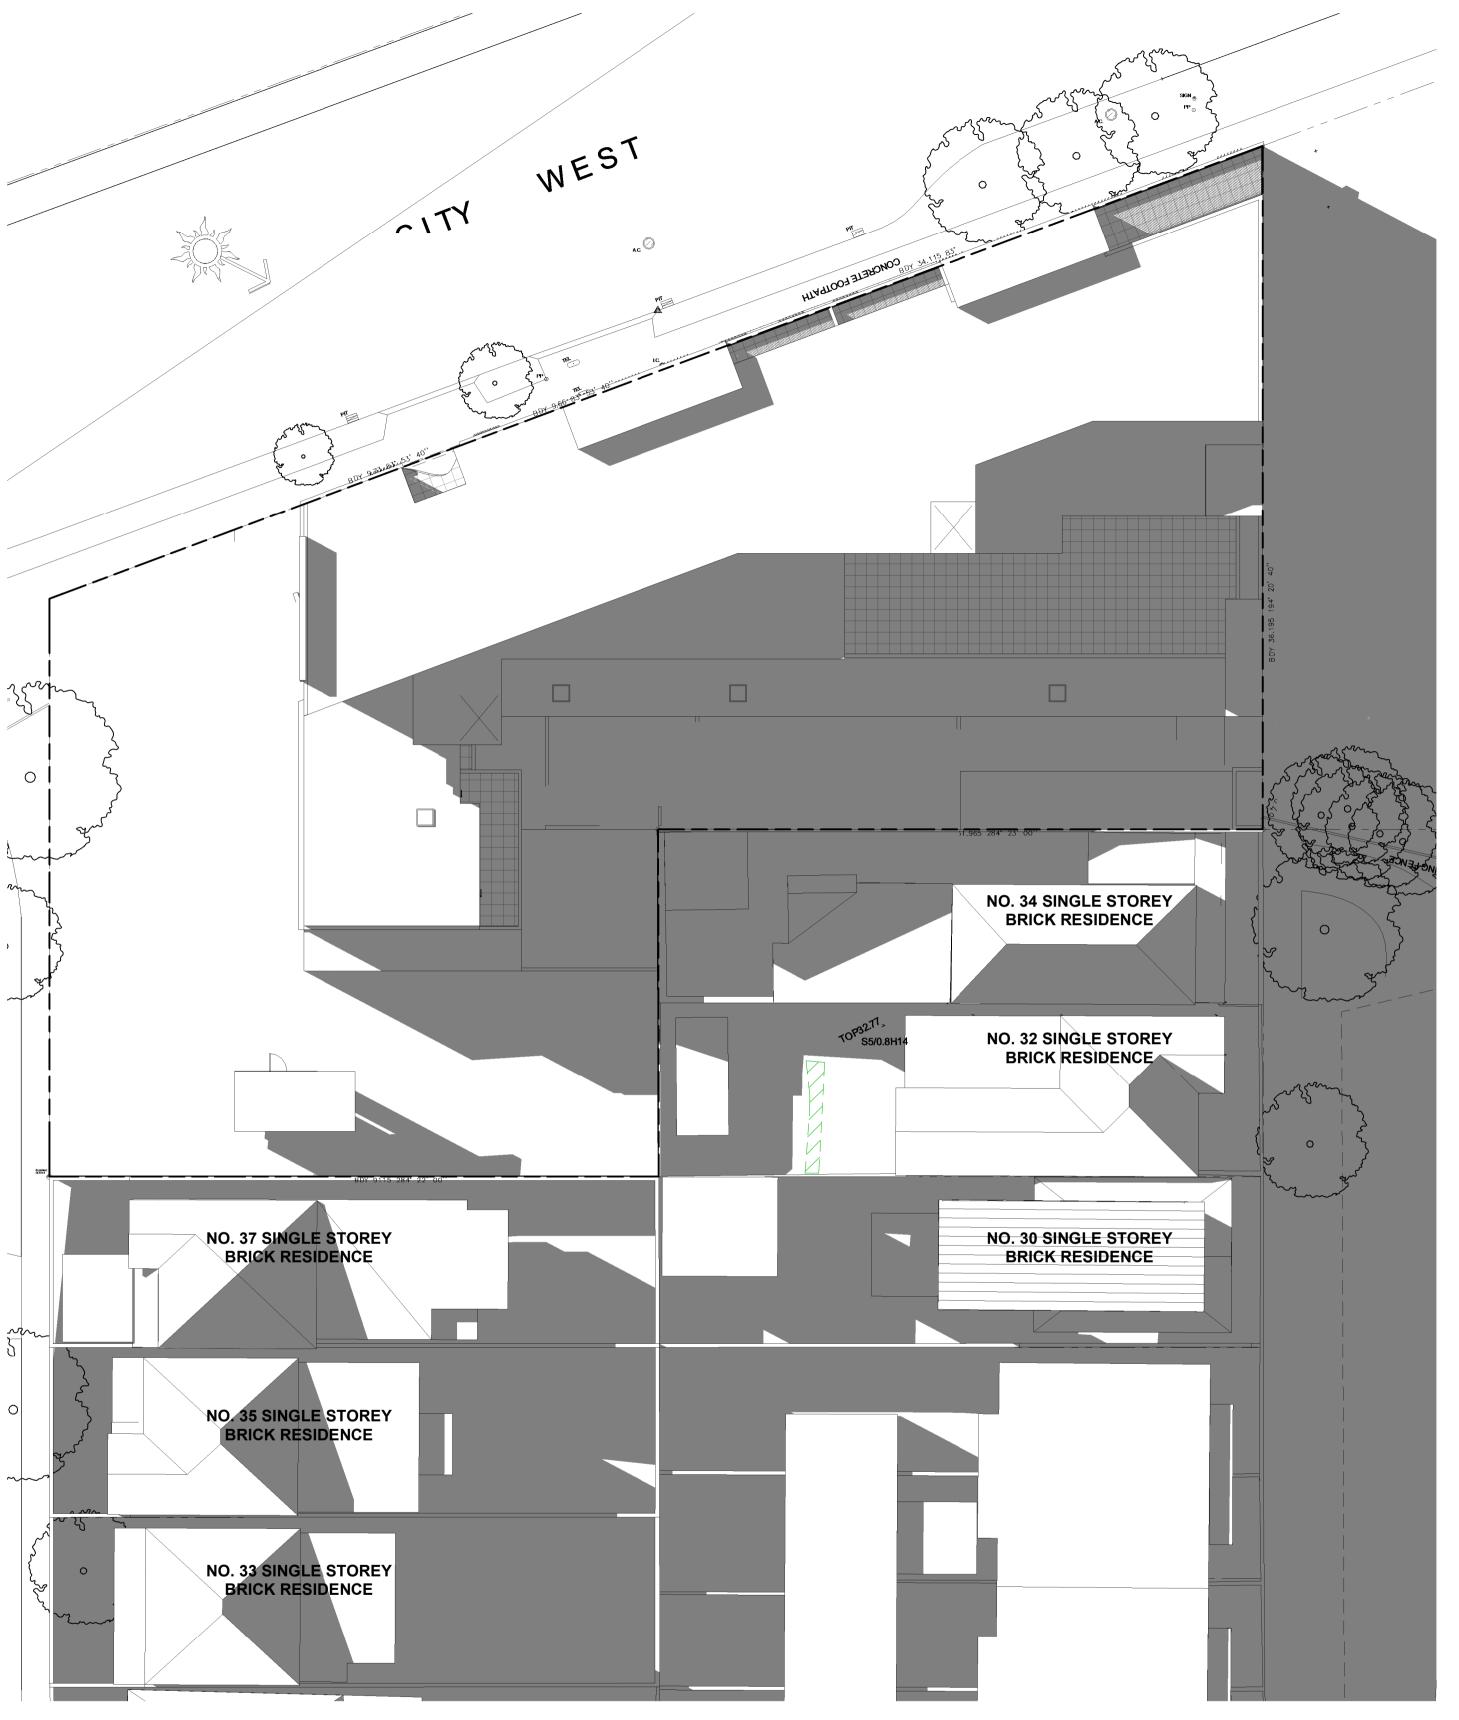



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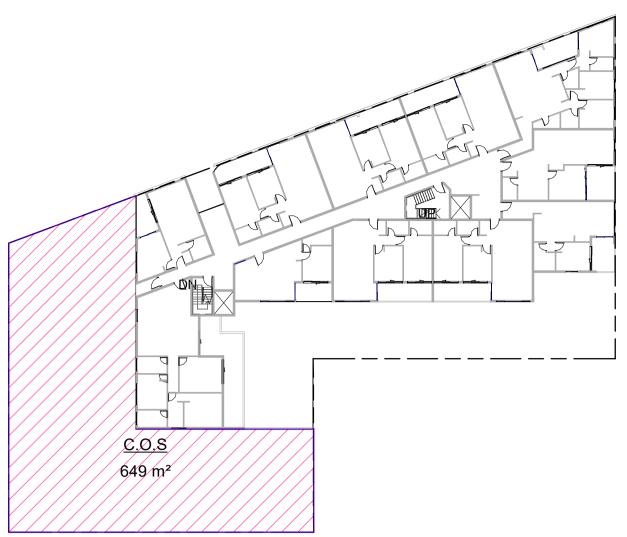
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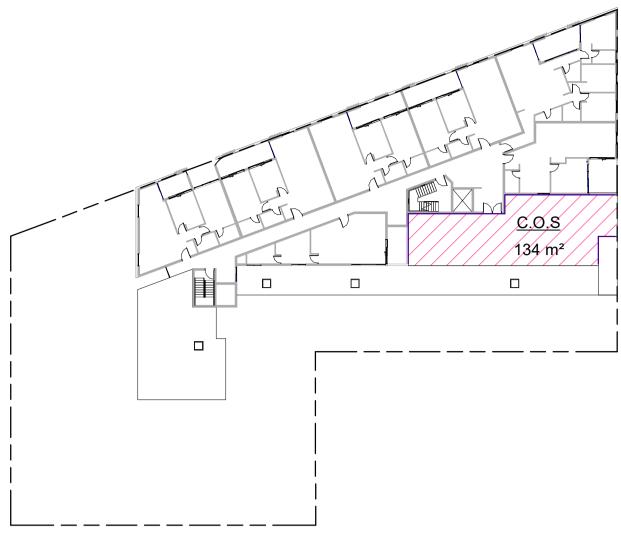
DIAGRAM- SHADOW ANALYSIS 4 OF 4
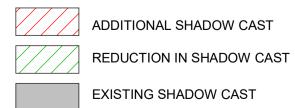
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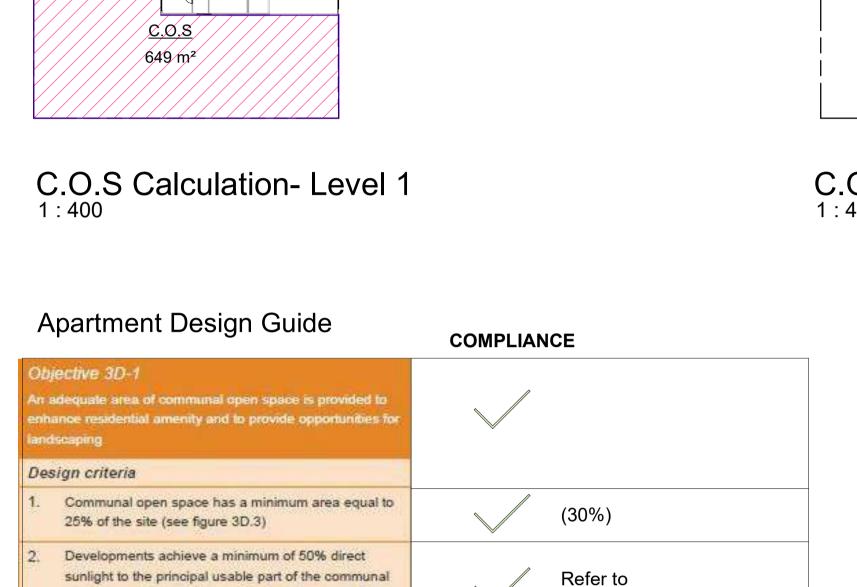
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C.O.S Calculation - Level 3



	COMPLIANCE
Objective 3D-1 An adequate area of communal open space is provided to enhance residential amenity and to provide opportunities for landscaping Design criteria	
Communal open space has a minimum area equal to 25% of the site (see figure 3D.3)	(30%)
Developments achieve a minimum of 50% direct sunlight to the principal usable part of the communal open space for a minimum of 2 hours between 9 am and 3 pm on 21 June (mid winter)	Refer to Drawing No.16-19
Design guidance	
Communal open space should be consolidated into a well designed, easily identified and usable area	
Communal open space should have a minimum dimension of 3m, and larger developments should consider greater dimensions	Minimum 5.5 m (Level 3)
Communal open space should be co-located with deep soil areas	
Direct, equitable access should be provided to communal open space areas from common circulation areas, entries and lobbies	Allowing access from the street and common areas
Where communal open space cannot be provided at ground level, it should be provided on a podium or roof	
Where developments are unable to achieve the design criteria, such as on small lots, sites within business zones, or in a dense urban area, they should: • provide communal spaces elsewhere such as a landscaped roof top terrace or a common room • provide larger balconies or increased private open space for apartments • demonstrate good proximity to public open space and facilities and/or provide contributions to public open	Not Applicable

space

AREA CALCULATION- COMMUNAL OPEN SPACE				
SITE AREA	LEVEL	AREA	%	
0445 3	FIRST FLOOR	649 m²	30%	
2145 m²	LEVEL THREE	134 m²	6%	
	TOTAL	783 m²	36.5%	
(COMPLIES)				


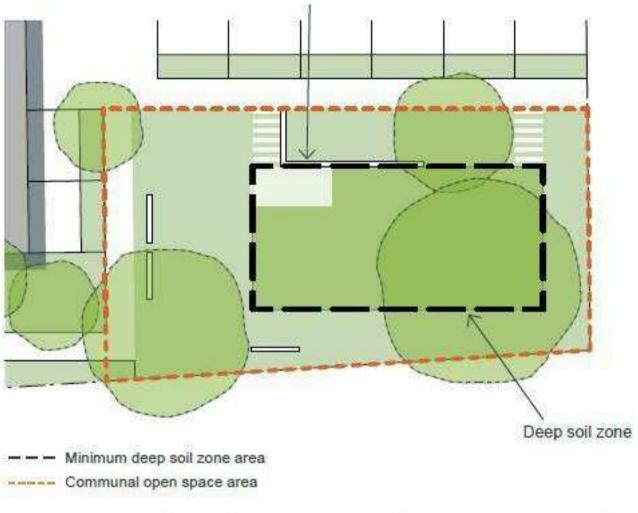


Figure 3E.4 Pedestrian pathways and paving which is specifically designed for tree root growth can occupy up to 10% of the deep soil zone

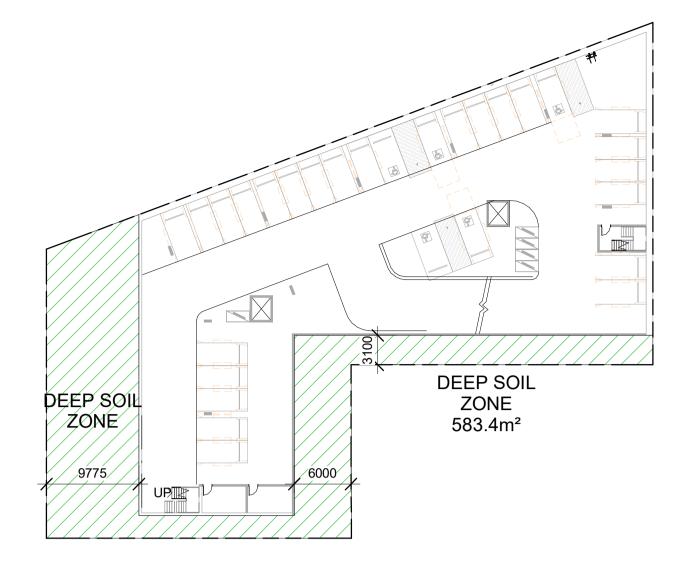

Deep Soil Calculation

AREA CALCULATION- DEEP SOIL AREA				
SITE AREA ADG REQ.% AREA %				
2145 m²	15%	583.4 m²	27%	

(COMPLIES)



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Project:

RESIDENTIAL DEVELOPMENT 36 LONSDALE STREET & 64 - 70 BRENAN STREET, LILYFIELD

DRAWING TITLE

Project No.

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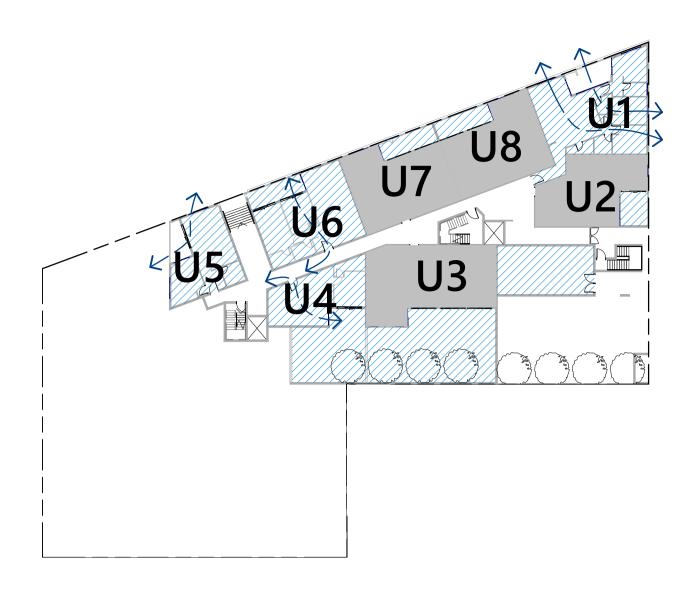
DIAGRAM- COMMUNAL OPEN SPACE


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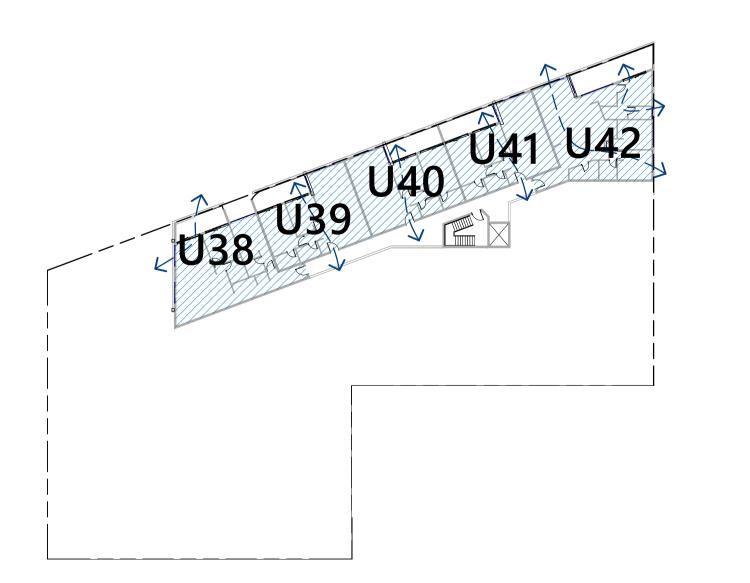
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1919







Level 2 Cross Ventilation

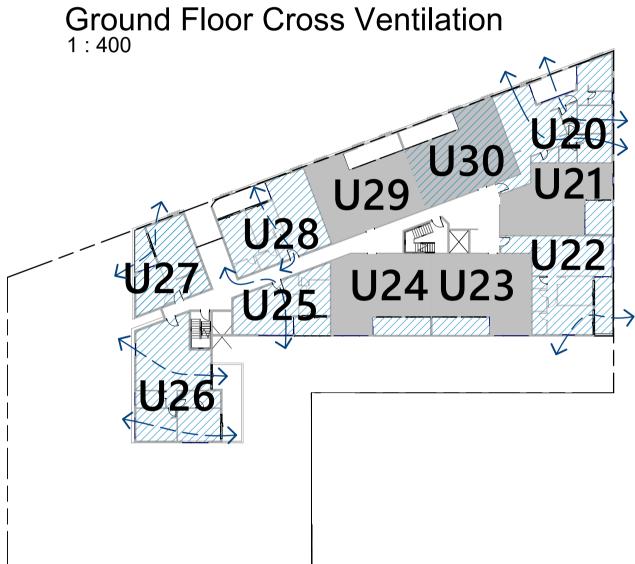

Level 4 Cross Ventilation

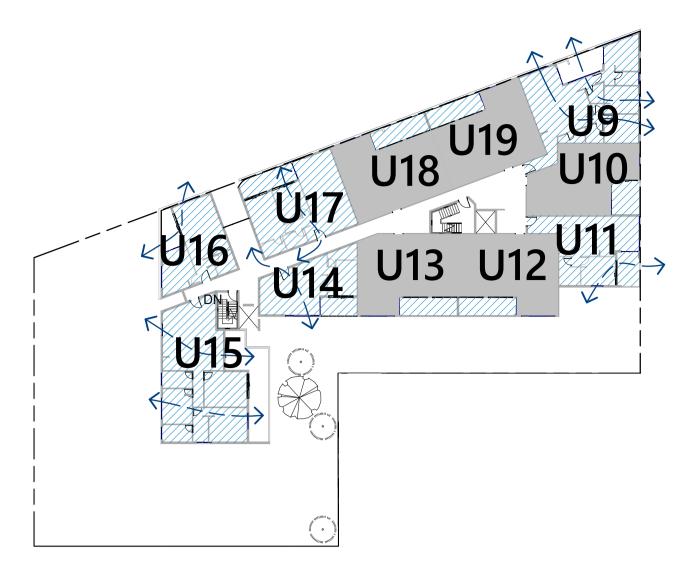

Level 1 Cross Ventilation

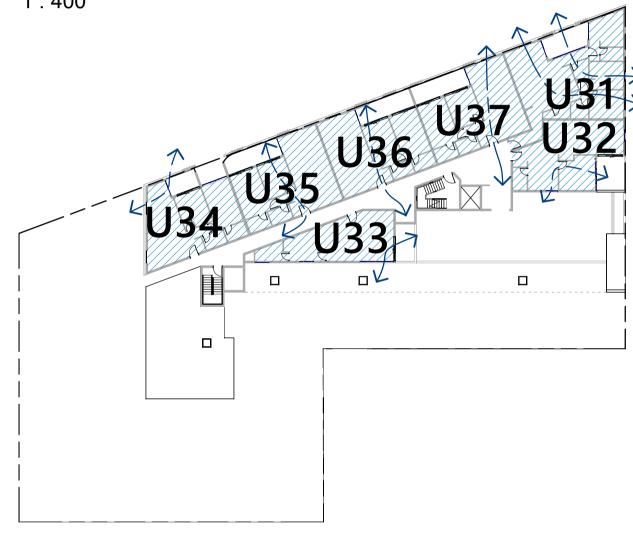



Level 3 Cross Ventilation

UNIT No.	UNIT TYPE	
U1	3 Bed	Yes
U4	1 Bed	Yes
U5	1 Bed	Yes
U6	2 Bed	Yes
U9	3 Bed	Yes
U11	1 Bed	Yes
U14	1 Bed	Yes
U15	2 Bed	Yes
U16	1 Bed	Yes
U17	2 Bed	Yes
U20	3 Bed	Yes
U22	2 Bed	Yes
U25	1 Bed	Yes
U26	2 Bed	Yes
U27	2 Bed	Yes
U28	2 Bed	Yes
U31	3 Bed	Yes
U32	1 Bed	Yes
U33	1 Bed	Yes
U34	2 Bed	Yes
U35	2 Bed	Yes
U36	2 Bed	Yes
U37	2 Bed	Yes
U38	2 Bed	Yes
U39	2 Bed	Yes
U40	2 Bed	Yes
U41	2 Bed	Yes
U42	3 Bed	Yes

28

	SEPP65 - CROSS VENTILATION COMPLIANCE						
UNITS	No. OF UNITS	PERCENTAGE	CRITEREA (SEPP)	PASS			
28	42	67%	60%	1			

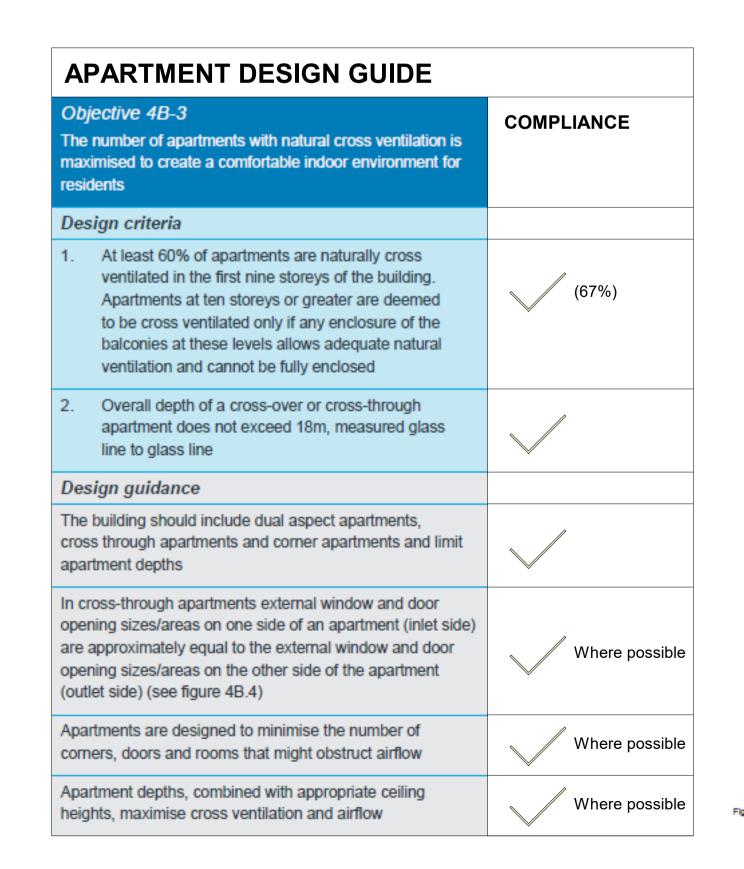

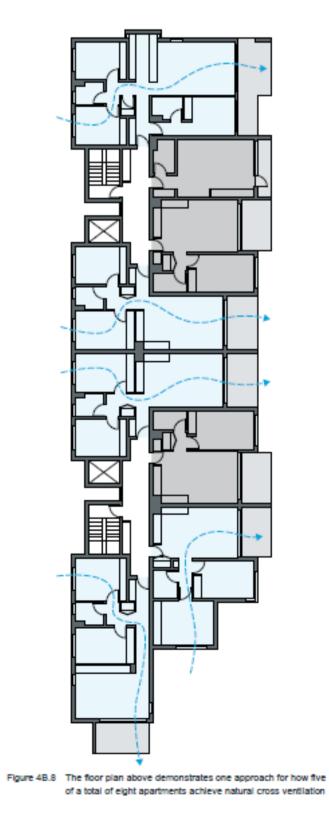




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RESIDENTIAL DEVELOPMENT 36 LONSDALE STREET & 64 - 70 BRENAN STREET, LILYFIELD

DRAWING TITLE

DIAGRAM- CROSS VENTILATION

Scale: As indicated@A1 1:0@A3
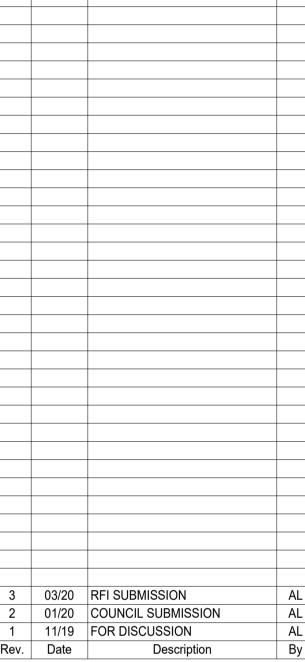
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3D View 1



3D View 2



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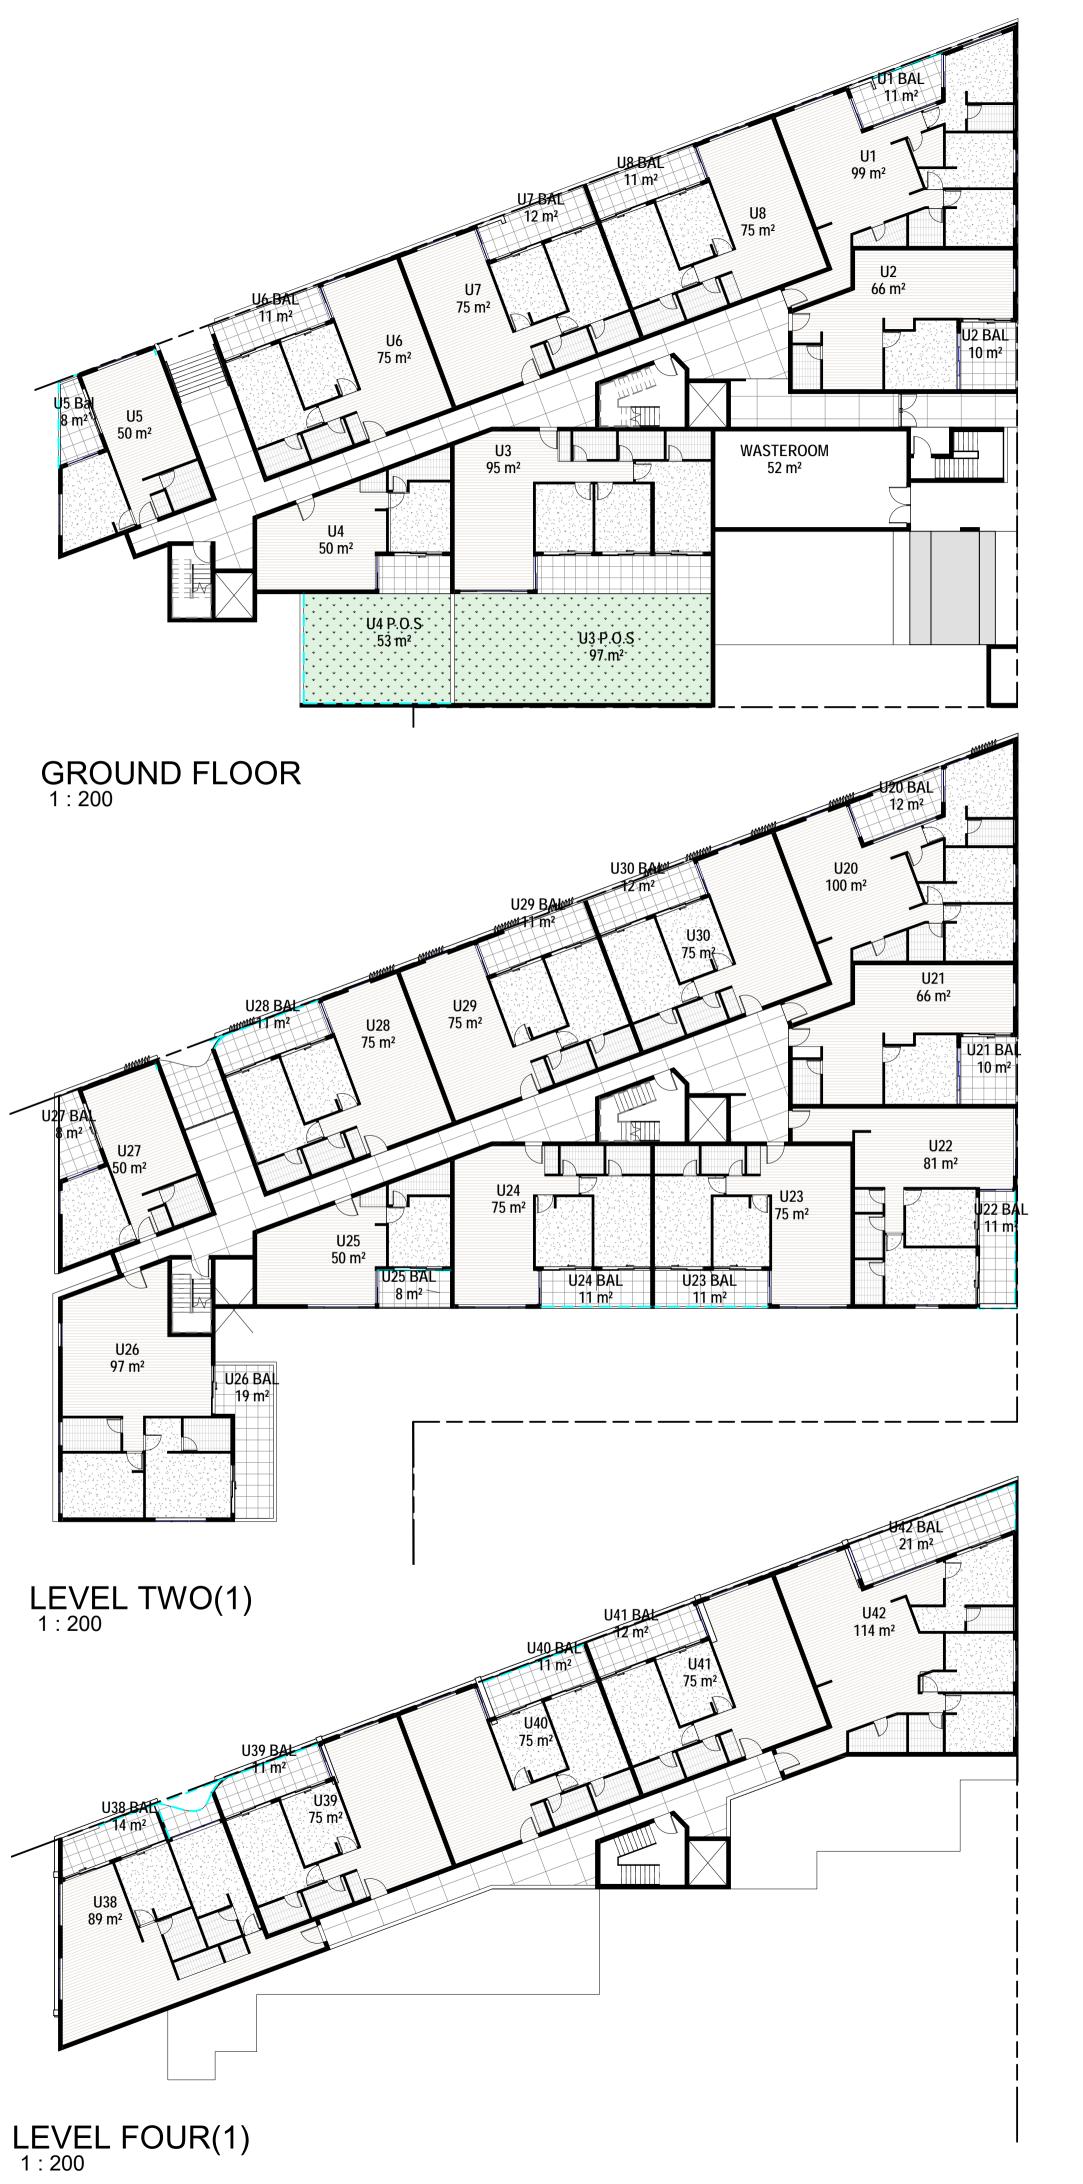
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DRAWING TITLE

PERSPECTIVES

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4E Private open space and balconies

appropriately sized private open

space and balconies to enhance

4E-1 Apartments provide

residential amenity

minimum depth of 3m

Min. POS

area

8m²

10m²

The min balcony depth to be counted as

contributing to balcony is 1m

Dwelling

type

Studio

1br

2br

2. For apartments at ground level or on a podium or similar structure, a private open space is provided instead of a balcony. It must have a minimum area of 15m2 and a


Min. POS

Depth

2m

2m

2.4m

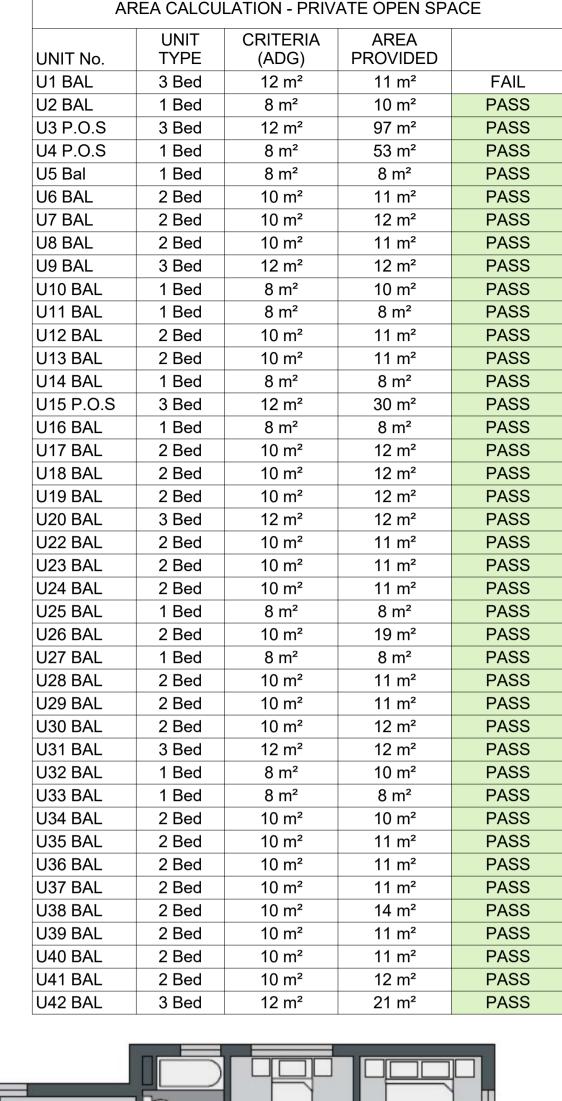

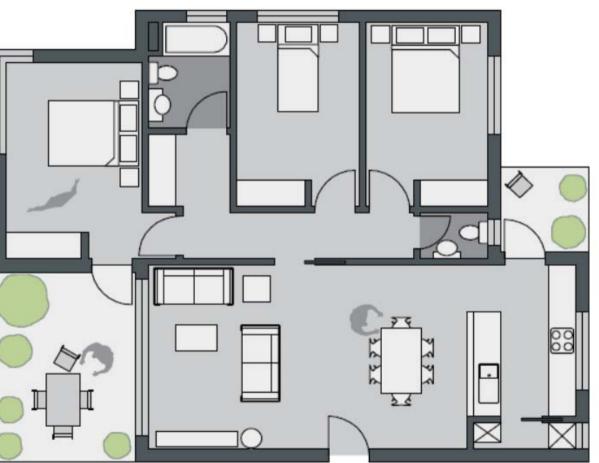


Figure 4E.4 Building layout should maximise balcony use by allowing access from the main living area and a bedroom (where possible). Secondary balconies provide further amenity to apartment living and are best accessed off kitchens and laundries

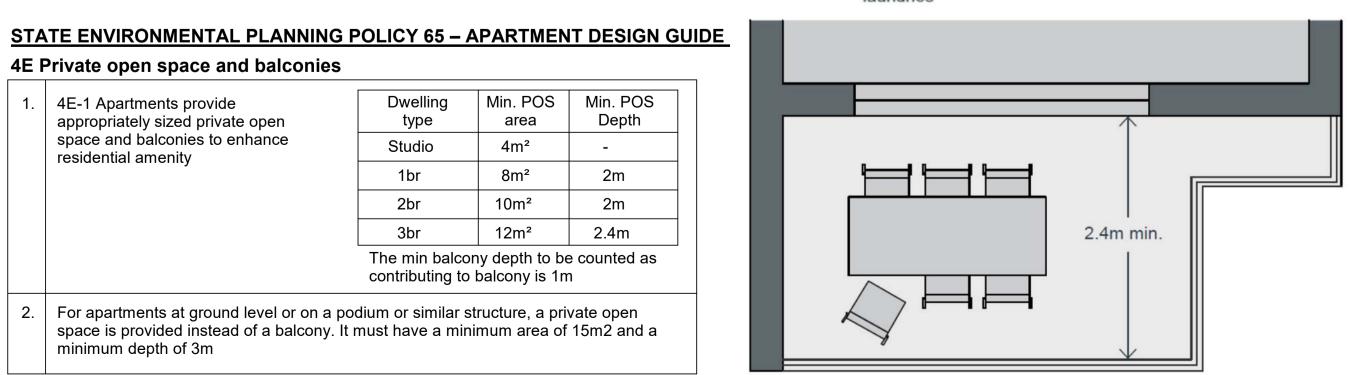


Figure 4E.3 Minimum balcony depths ensure that the balcony area is useable and can be easily accessed



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RESIDENTIAL DEVELOPMENT 36 LONSDALE STREET

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PRIVATE OPEN SPACE

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