
HANGER WEST

INNER WEST COUNCIL SLOANE ST & GROSVENOR CR, SUMMER HILL (AT SLOANE ST & GROSVENOR CR INTERSECTION) PROPOSED RAISED PEDESTRIAN CROSSINGS

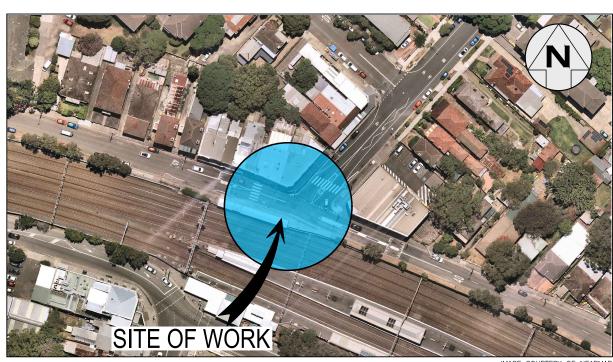

LOCALITY SKETCH N.T.S.

PROJECT #: 303082

& 301485

PLAN #:

10244

FOR CONSTRUCTION



DRAWING INDEX						
SHEET #	SHEET TITLE					
1	COVER SHEET					
2	NOTES & SCHEDULES					
3	DEMOLITION PLAN					
4	GENERAL ARRANGEMENT PLAN					
5	STORMWATER MANAGEMENT PLAN					
6	SIGNS & LINEMARKING PLAN					
7	DETAILS-PED CROSSINGS & KERB BLISTERS (1 of 5)					
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9	DETAILS-MISCELLANEOUS (3 of 5)					
10	DETAILS-RAISED PEDESTRIAN CROSSINGS (4 of 5)					
11	DETAILS-STORMWATER (5 of 5)					
12	LINEMARKING GENERAL SPECIFICATION					
13	UNDERGROUND UTILITIES PLAN					



ADAM DILLON 08-11-21 DESIGNED BY JALAL UDDIN 10-07-23

TELSTRA / OPTUS AUSGRID

SCALES (ORIGINAL A1) N.A.

SLOANE ST & GROSVENOR CR, SUMMER HILL (AT SLOANE ST & GROSVENOR CR INTERSECTION) PROPOSED RAISED PEDESTRIAN CROSSINGS COVER SHEET

PROJECT NO. 303082 & 301485

10244

GENERAL NOTES

- REQUIREMENTS OF AS1742.2-2009 AND AS1742.3-2009 "TRAFFIC CONTROL DEVICES FOR WORKS ON ROADS".
- ALL WORK IS TO BE CARRIED OUT IN ACCORDANCE WITH COUNCIL'S TECHNICAL SPECIFICATION (AUS-SPEC) AND TO BEST PRACTICE STANDARDS AND TO THE SATISFACTION OF COUNCIL'S
- (AUS-SPEC) AND TO BEST PRACTICE STANDARDS AND TO THE SATISFACTION OF COUNCIL'S MANAGER, CAPITAL PROGRAM.

 OVERLAY TO CONSIST OF 40mm THICK AC10 . REFER TO RELEVANT SECTION FOR DETAILS.

 ALL RESIDENTS AFFECTED BY THE PROPOSED WORKS SHOULD BE NOTIFIED AT LEAST 3 WORKING DAYS BEFORE THE COMMENCEMENT OF ROADWORKS.

 EXISTING SURFACE FITTINGS OF THE SERVICES SHALL BE ADJUSTED AS NECESSARY TO THE REQUIREMENTS OF THE RELEVANT AUTHORITY.

 SUITABLE VEHICULAR ACCESS SHALL BE MAINTAINED TO EACH LOT OR ALTERNATIVE ARRANGEMENTS MADE WITH THE OWNERS.

 WORK ONLY PERMITTED TO BE CARRIED OUT BETWEEN THE HOURS OF 7am AND 5pm FROM MONDAY TO SATILIPDAY NO WORK PERMITTED AN SLINDAYS.

- MONDAY TO SATURDAY, NO WORK PERMITTED ON SUNDAYS.
- ALL SERVICES TO BE CHECKED FOR LEVEL AND LOCATION PRIOR TO COMMENCEMENT OF
- 9. ALL SERVICES AFFECTED BY NEW WORK TO BE ADJUSTED AS REQUIRED TO SUIT. NO SERVICE SURFACE FITTINGS ARE TO BE COVERED.

 10. PROJECT MANAGER TO INSPECT FOR ALL UNSOUND AREAS BEFORE PROFILING AC PAVEMENT AND AFFER PROOF ROLLING. WEAK SECTIONS ARE TO BE IDENTIFIED AND HEAVY—PATCHED TO A NOMINAL THICKNESS OF 150mm WITH AC28 BEFORE RESEALING IN ACCORDANCE TO
- 11. THE LOCATION OF UNDERGROUND SERVICES AND HOUSE CONNECTIONS HAVE NOT BEEN SHOWN ON THIS PLAN AND MUST BE VERIFIED ON-SITE BY THE CONTRACTOR WITH REPRESENTATIVES FROM EACH OF THE UTILITY AUTHORITIES. CONTACT DIAL BEFORE YOU DIG
- EXISTING SIGNS TO REMAIN UNLESS OTHER WISE NOTED.
- 13. ALL LINEMARKING AND RRPM'S REMOVED OR AFFECTED DURING THE COURSE OF THE WORKS IS TO BE REINSTATED UNLESS NOTED OTHERWISE. ALL LINEMARKING IS TO COMPLY WITH RMS IS TO BE REINSTATED UNLESS NOTED OTHERWISE. ALL LINEMARKING IS TO COMPLY WITH RMS
 SPECIFICATION R141 — "PAYMENT MARKING" AND TO BE THERMOPLASTIC TYPE AND INCLUDE
 PLASTIC BEADS IN ACCORDANCE WITH RMS SPECIFICATIONS 3357 AND 3353 RESPECTIVELY.
 ALL RRPM'S TO COMPLY WITH RMS SPECIFICATION R142. ALL ROAD COLOURED PAINT
 MARKINGS TO COMPLY WITH RMS SPECIFICATION R110

 14. AREAS OF HEAVY PATCHING ARE TO BE MARKED OUT ON SITE PRIOR TO COMMENCEMENT OF
 WORK BY PROJECT MANAGER AND CIVIL DESIGN ENGINEER. REFER TO NOTE 10.

 15. THE CONTRACTOR SHALL ENSURE THAT ALL EXISTING SURROUNDING AREAS NOT REQUIRED TO
 BE REPLACED OR RESET AS PART OF THE WORKS SHALL NOT BE DAMAGED DURING THE
 COURSE OF THE WORKS.

- COURSE OF THE WORKS.

 16. ASPHALTIC CONCRETE SHALL CONFORM TO RMS SPECIFICATIONS R116 "ASPHALT (DENSE
- GRADED AND OPEN GRADED)' 17 INSPECTIONS ARE REQUIRED AT THE FOLLOWING STAGES AND AS OTHERWISE DIRECTED BY THE MANAGER, CAPITAL PROGRAM.
- ROAD PAVEMENT

 A. SUBGRADE TRIMMED AND CONSOLIDATED PRIOR TO FIRST PAVEMENT COURSE. (NOTE:
 - SINGLE AXLE TRUCK WITH 8t LOAD TO BE AVAILABLE FOR PAVEMENT TEST.) B. EACH PAVEMENT LAYER SPREAD AND COMPACTED. (NOTE: SINGLE AXLE TRUCK WITH 8t LOAD TO BE AVAILABLE FOR PAVEMENT TEST.)
 - PAVEMENT COMPLETED PRIOR TO SEALING CONCRETE WORKS
 - (I) EXCAVATION COMPLETED
- FORMWORK AND REINFORCEMENT SET

- (III) CONCRETE FORMED AND CURED

 18. LINEMARKING AND SIGNPOSTING TO BE INSTALLED AS SOON AS PRACTICABLE.

 19. KERB FACES OF ALL ISLANDS TO BE PAINTED WHITE AND TO INCLUDE GLASS BEADS IN ACCORDANCE WITH RMS SPECIFICATION No. 3353.

 20. KERB RAMPS TO BE PROVIDED WHERE SHOWN TO INNER WEST COUNCIL STANDARD BY MAINTAINING WITH MAXIMUM GRADIENT 1 IN 8.

 21. USE CAUTION TO PRESERVE HERITAGE LISTED STREET NAME PLAQUES EMBEDDED IN FOOTPATH WHEN CONSTRUCTION FOOTPATHS AND KERB RAMPS (IF SHOWN) NO STATE SURVEY MARKS WHEN CONSTRUCTION FOOTPATHS AND KERB RAMPS (IF SHOWN). NO STATE SURVEY MARKS
- ARE TO BE REMOVED PRIOR TO CONSULTING WITH COUNCIL'S SURVEYOR.

 22. INSTALL "CHANGED TRAFFIC CONDITIONS AHEAD" SIGNS ON ALL APPROACHES 75-100m IN ADVANCE OF THE INTERSECTION AND MAINTAIN FOR 3 MONTHS.

 23. ALL TRAFFIC SIGNS TO COMPLY WITH RMS QA SPECIFICATION R143 AND TO BE OF HIGH
- 24. ALL PATHWAYS WHERE AFFECTED BY CONSTRUCTION WORKS SHALL BE RECONSTRUCTED TO
- COUNCIL'S STANDARD SPECIFICATION.

 25. EXISTING LINEMARKING IS TO BE REMOVED BY GRINDING WHERE NEW LINEMARKING IS REQUIRED OR PROVIDED.

 26. ALL SIGNPOSTING ON SPLITTER, KERB OR PEDESTRIAN REFUGE ISLANDS TO BE ERECTED
- USING V-NOTCH INSERTS EMBEDDED INTO CONCRETE (OR SIMILAR AS APPROVED BY
- 27. ALL CONCRETE ELEMENTS TO BE OF 25MPa UNLESS OTHERWISE STATED.

JNLESS DETAILED ON THIS DRAWING ALL WORK SHALL CONFORM TO

IMPORTANT

IN CASE OF EMERGENCY, CONTACT THE FOLLOWING SERVICE AUTHORITIES; IF THEIR SERVICES ARE INVOLVED/AFFECTED

AUTHORITY

AARNET PTY LTD 02 4951 0899 LOW VOLTAGE LINE AUSGRID UZ 4931 0036 JEMENA GAS SOUTH 1300 880 905 NBN CO. 1800 626 329 NEXTGEN 1800 505 777 0710 1800 505 777 LOW VOLLAGE LINE
PRIMARY & DISTRIBUTION
BURIED FIBRE OPTIC CABLES
BURIED FIBRE OPTIC CABLES
BURIED FIBRE OPTIC CABLES
WATER & SEWER LINES
BURIED CABLES
BURIED CABLES SYDNEYWATER TELSTRA VERIZON 1800 505 777 13 20 92 1800 653 935 02 9434 5000 BURIED CABLES BURIED CABLES



UTILITIES, IF SHOWN, ARE DIAGRAMMATIC ONLY. CONTRACTORS ARE RESPONSIBLE TO LOCATE AND AVOID DAMAGE TO THEM AS SPECIFIED BY EACH UTILITIES EXCAVATION GUIDELINES.

! WARNING !!

BEWARE OF UNDERGROUND SERVICES
THE LOCATION OF UNDERGROUND SERVICES HAVE BEEN
INTERPOLATED FROM AERIAL PHOTOGRAMMETRIC DATA OR
KNOWN POSITIONS OF VALVES, MANHOLES ETC. OR
INFORMATION SUPPLIED BY SERVICE AUTHORITIES. NO
RESPONSIBILITY IS TAKEN FOR THE ACCURACY OF THE
INTERPOLATED INFORMATION SUPPLIED. ENSURE ALL
SERVICES ARE ACCURATELY LOCATED PRIOR TO
COMMENCEMENT OF WORK.

EROSION AND SEDIMENT CONTROL

GENERAL MEASURES

- STOCKPILES SHALL BE CONFINED TO ONE CENTRAL AREA WHERE POSSIBLE.
 EROSION CONTROL MEASURES TO BE IN PLACE PRIOR TO COMMENCEMENT OF ANY
 CONSTRUCTION WORK. MEASURES ARE APPLIED TO PROTECT ADJOINING PROPERTIES FROM EROSION AND SILT DAMAGE.
- EROSION CONTROL MEASURES NOT TO BE REMOVED UNTIL CONSTRUCTION IS COMPLETED
- ERUSION COMMINCE MEASURES NOT 10 BE REMOVED STILL CONSTRUCTION TO SOME EXAMPLE AND SITE HAS BEEN REHABILITATED.

 REHABILITATION INCLUDES COMPLETION OF ALL CONSTRUCTION WORK AND LANDSCAPING,

 SEEDING OF TURFING OF ALL BATTERS AND FILL AREAS.

 PIPED DRAINAGE NETWORKS SHOULD BE INSTALLED AND CONNECTED AS EARLY AS
- POSSIBLE.

 ALL AREAS NOT SUBJECT TO CONSTRUCTION WORKS SHALL BE RETAINED FREE FROM DISTURBANCE OR DAMAGE DURING THE CURRENCY OF THE CONTRACT. SHOULD THESE AREAS BECOME DISTURBED OR DAMAGED, THEY SHALL BE RE-INSTATED BY THE ALL AREAS NOT SUBJECT TO CONSTRUCTION WORKS SHALL BE RETAINED FREE FROM DISTURBANCE OR DAMAGE DURING THE CURRENCY OF THE CONTRACT. SHOULD THESE AREAS BECOME DISTURBED OR DAMAGED, THEY SHALL BE RE-INSTATED BY CONTRACTOR AT NO COST TO THE PRINCIPAL.

2. STABILISATION OF DISTURBED AREAS.

- STABILISATION OF DISTURBED AREAS SHALL BE IN ACCORDANCE WITH COUNCIL'S SPECIFICATION FOR GRASSING AND/OR SPECIFICATION FOR LANDSCAPE WORKS. THE FOLLOWING SHALL BE APPLIED FOR THE CONTROL OF EROSION AND SEDIMENTATION:—
 (a) STABILISATION OF DENUDED AREAS SHALL COMMENCE AS SOON AS POSSIBLE AFTER THE AREAS HAVE BEEN DISTURBED.
- (b) ALL STABILISATION MEASURES SHALL BE UNDERTAKEN PRIOR TO THE END OF THE

3 MAINTENANCE

-). IMMAIN LEINANCE.

 ALL SEDIMENT AND EROSION CONTROL DEVICES SHALL BE MAINTAINED IN A SATISFACTORY WORKING ORDER THROUGHOUT THE CONTRACT, MAINTENANCE AND DEFECTS LIABILITY PERIODS OR UNTIL SUCH EARLIER TIME AS THE AREA HAS BEEN STABILISED AND THE SUPERINTENDENT DIRECTS THAT THE DEVICE BE REMOVED.

 THE CONTRACTOR SHALL INSPECT ALL DEVICES AFTER EACH STORM FOR STRUCTURAL
- DAMAGE OR CLOGGING BY SILT AND OTHER DEBRIS AND MAKE PROMPT REPAIRS OR

4. SEDIMENT CONTROL DEVICES (S.C.D.) - THESE SHALL BE CONSTRUCTED AT INLETS TO STORMWATER SYSTEMS TO TRAP THE

SEDIMENT IN RUNOFF. SECTIONS 11.3.02/03/04/06 OF THE N.S.W. DEPARTMENT OF HOUSING CONSTRUCTION SPECIFICATION, 1989 EDITION, SHALL APPLY.

PLANTING NOTES

- SUBGRADE TO BE CULTIVATED TO A MINIMUM DEPTH OF 100mm.
- SUBGRADE TO BE CULTIVATED TO A MINIMUM DEPTH OF 100mm
 PLANTING AREAS TO BE EXCAVATED TO A MINIMUM DEPTH OF
 SOMM AND FILLED WITH PREMIUM GRADE GARDEN SOIL.
 INORGANIC MULCH LAVER MINIMUM 75mm DEPTH IS TO BE
 SPREAD THROUGHOUT ALL PLANTING AREA.
 GARDEN AREA TO BE WATERED TWICE A WEEK FOR 3 MONTHS,
 OR AS REQUIRED TO MAINTAIN HEALTHY GARDEN.
 QUANTITIES OR SIZE OF PLANTS SPECIFIED ARE NOT TO BE
 DECREASED TO ENSURE ADEQUATE ESTABLISHMENT.

UNDERGROUND UTILITY SERVICES

- THE LOCATION OF UNDERGROUND UTILITY SERVICES SHOWN ON THIS PLAN ARE INDICATIVE ONLY. COUNCIL CANNOT GUARAUNTEE THEIR ACCURACY.
 PRIOR TO CONSTRUCTION, IT IS THE RESPONSIBILTY OF THE CONTRACTOR TO CARRY.
- OUT THEIR OWN SERVICES SEARCH BY CONTACTING 'DIAL BEFORE YOU DIG' (PH: 1100 OR WWW.1100.COM.AU). THE CONTRACTOR MUST CHECK THE LOCATION AND DEPTH OF ALL SERVICES PRIOR TO THE COMMENCEMENT OF WORKS.

 3. ALL SERVICES AFFECTED BY NEW WORK TO BE ADJUSTED AS REQUIRED TO SUIT NEW
- ALL SERVICES AFFECTED BY NEW WORN TO BE ADJUSTED AS REQUIRED TO SUIT NEW SURFACE LEVELS. (TO THE REQUIREMENTS OF THE RELEVANT SERVICE AUTHORITY). NO SERVICE SURFACE FITTINGS ARE TO BE COVERED. ALL PERMITS REQUIRED MUST BE OBTAINED FROM THE RELEVENT SERVICE AUTHORITY PRIOR TO COMMENCEMENT OF WORKS.

 ANY DAMAGE TO SERVICES SHALL BE RECTIFIED BY THE CONTRACTOR OR THE RELEVANT AUTHORITY AT NO COST TO COUNCIL.

PROTECTING SURVEY INFRASTRUCTURE

SURVEY MARKS SHALL BE PRESERVED AT ALL TIMES. WHERE PRESERVATION IS NOT POSSIBLE, THE PROJECT MANAGER SHALL BE NOTIFIED & CONSENT RECEIVED PRIOR TO THEIR REMOVAL. THE CONTRACTOR SHALL BE RESPONSIBLE FOR COMPLIANCE WITH THE SURVEYOR GENERALS DIRECTION NO.11 'PRESERVATION OF SURVEY INFRASTRUCTURE' AVAILABLE FROM LAND REGISTRY SERVICES NSW WEBSITE.

NOTE
ALL DIMENSIONS ARE IN
MILLIMETERS UNLESS
OTHERWISE SHOWN

NOTE ALL SIGNS AND LINES TO REMAIN UNLESS OTHERWISE NOTED.

<u>IMPORTANT</u> REMAIN UNLESS STATED THERWISE

NOTE
CONTRACTOR TO LOCATE ALL HOUSE
SERVICES, SUCH AS STORMWATER
OUTLET, GAS, WATER, TELEPHONE, ETC.
PRIOR TO CONSTRUCTION AND SERVICES

R. SEWER. TELSTRA & ELECTRICIT WATER, SEWER, TELSTRA & ELECTRICIT SERVICES IN THE VICINITY OF WORKS, CONTRACTOR TO CONTACT SYDNEY WATER, TELSTRA & ENERGY AUSTRALIA PRIOR TO EXCAVATION

NOTE
CONTRACTOR TO REINSTATE ALL KERB & GUTTER,
ROAD PAVEMENT AND FOOTPATHS AFFECTED BY
WORKS TO INNER WEST COUNCIL STANDARD AND
TO THE SATISFACTION OF THE PROJECT MANAGER

SURV. GEN.

SYDNEY WATER

TELSTRA / OPTUS

A.G.L. / SHELL PIPELINES

NOTE SURFACE FITTINGS OF SURFACE FITTINGS OF UNDERGROUND SERVICES ARE TO FINISH FLUSH WITH THE NEW SURFACES

CONCRETE

- C1. ALL WORKMANSHIP AND MATERIALS SHALL BE IN ACCORDANCE WITH AS 3600 CURRENT EDITION WITH AMENDMENTS EXCEPT WHERE VARIED BY THE CONTRACT DOCUMENTS.

 C2. CONCRETE QUALITY.

ELEMENT	SLUMP	MAX AGGREGATE SIZE	CEMENT TYPE	CEMENT GRADE				
ALL	80mm	20mm	GP	25MPa				
NO ADMIXTURES SHALL BE USED WITHOUT THE APPROVAL								

OF THE ENGINEER.

C3. CLEAR CONCRETE COVER TO REINFORCEMENT SHALL BE AS FOLLOWS UNLESS OTHERWISE SHOWN—

ELEMENT	SURFACE OF MEMBER IN INTERIOR ENVIRONMENT	SURFACE OF MEMBER IN ABOVE GROUND EXTERIOR ENVIRONMENT	SURFACE OF MEMBER IN CONTACT WITH GROUND (1)	SURFACE OF MEMBER II WATER	
ALL	35	45	55	75	
NOTE:					_

- NOTE: NOTE:
- C4. SIZES OF CONCRETE ELEMENTS DO NOT INCLUDE THICKNESS

LANDSCAPED PLANTING

EDGE)

EDGE)

SCHEDULE

SPACING QUANTITY POT SIZE COMMENTS

MATERIAL SCHEDULE

DESCRIPTION OF MATERIAL

300 120 140mm DIA REFER SHEET 8

300 300 140mm DIA REFER SHEET 8

CONCRETE PAVERS CODE PPX61: 400X400X60-35D AS

SUPPLIED BY PEBBLECRETE (WITH HONED FINISH BEVELLED

CONCRETE PAVERS CODE PPX61: 400X400X60-35D-SB AS

SUPPLIED BY PEBBLECRETE (WITH HONED FINISH BEVELLED

RMS TYPE 1 PEDESTRIAN FENCE, COLOUR: BLACK, FENCH

HEIGHT 700MM (840 FROM GROUND), POST SIZE: 90X110

MICROMESH HEELSAFE GRATE (WELDLOCK CODE: F30MAI OR

- OF APPLIED FINISHES.

 C5. CONSTRUCTION JOINTS WHERE NOT SHOWN SHALL BE LOCATED TO THE APPROVAL OF THE ENGINEER.

 C6. BEAM DEPTHS ARE WRITTEN FIRST AND INCLUDE SLAB

TULBAGHIA VARIEGATED

TYPE/NAME

BORDER/INFILL PAVER FOR

EXISTING PAVED FOOTPATH

BORDER/INFILL PAVER FOR NEW PAVED FOOTPATH

PEDESTRIAN FENCE

MICROMESH GRATE

- C7. NO HOLES OR CHASES OTHER THAN THOSE SHOWN ON THE STRUCTURAL DRAWINGS SHALL BE MADE IN CONCRETE MEMBERS WITHOUT THE PRIOR APPROVAL OF THE ENGINEER.

 C8. REINFORCEMENT IS REPRESENTED DIAGRAMATICALLY. IT IS NOT NECESSARILY SHOWN IN TRUE PROJECTION.

 C9. SPLICES IN REINFORCEMENT SHALL BE MADE ONLY IN THE POSITIONS SHOWN THE WRITTEN APPROVAL OF THE ENGINEER SHALL BE OBTAINED FOR ANY OTHER SPLICES WHERE THE LAP LENGTH IS NOT SHOWN IT SHALL BE SUFFICIENT TO DEVELOP THE FULL STRENGTH OF THE REINFORCEMENT.

 C10. WELDING OF REINFORCEMENT WILL NOT BE PERMITTED UNLESS SHOWN ON THE STRUCTURAL DRAWINGS.

 C11. PIPES OR CONDUITS SHALL NOT BE PLACED WITHIN THE CONCRETE COVER TO REINFORCEMENT WITHOUT THE APPROVAL OF THE ENGINEER. THE CONCRETE COVER TO EMBEDDED PIPES OR CONDUITS SHALL BE A MINIMUM OF 20mm.
- C12. REINFORCEMENT SYMBOLS: S-DENOTES GRADE 230S HOT ROLLED DEFORMED BARS TO AS
 - 1302.
 Y-DENOTES GRADE 410Y TEMPCORE DEFORMED BAR TO AS 1302.
 R-DENOTES GRADE 230R HOT ROLLED PLAIN BARS TO AS

 - F-DENOTES HARD-DRAWN WIRE REINFORCING FABRIC TO AS
- W-DENOTES HARD-DRAWN PLAIN WIRE TO AS 1303.
- W-DENOTES HARD-DRAWN PLAIN WIRE TO AS 1303.

 C13. ALL REINFORCEMENT FABRIC SHALL COMPLY WITH AS 1303 AND AS 1304 AND SHALL BE SUPPLIED AS FLAT SHEETS.

 C14. ALL THE REQUIREMENTS OF THE ACSE CONCRETE SPECIFICATION DOCUMENT 1 SHALL APPLY TO THE FORMWORK, REINFORCEMENT AND CONCRETE.

 C15. ALL CONCRETE TO BE MECHANICALLY VIBRATED IN FORM TO GIVE MAXIMUM COMPACTION WITHOUT SEGREGATION OF CONCRETE
- C16. PROVIDE 20mm CHAMFER TO ALL EXPOSED EDGES U.N.O.

QUANTITY

37m²

110m

12.6m

TRAFFIC LIGHTS

EXISTING SERVICES L PIPELINE O'HD ELECT & TEL ____ ET ___ ET ___ ET ___
UNKNOWN ____ ? ___ ? ____ ?

SURVEY LEGEND

SURVEY STATION

DRILLED HOLE SURVEY NAIL

COLUMN

BOLLARD

LIGHT POLE

PHONE BOOTH

RUBBISH BIN

WATER METER

PARKING METER

UNKNOWN SERVICE COVER SEWER LAMP HOLE TRAFFIC LIGHT BOX

WATER STOP VALVE

MAIL BOX TELECOMM. SERVICE COVER

ELECTRICITY & LIGHT POLE

TELECOMMUNICATION PILLAR

MANHOLE (STORMWATER/SEWER)


PERMANENT SURVEY MARK

SYMBOLS

 $\stackrel{\circ}{\boxtimes}$

⊠ ∏€

SURVEY STATION COORDINATES							
STATION	EASTING	NORTHING	ELEVATION				
STN1	327939.521	6248465.840	26.104				
STN2	327933.589	6248482.851	26.479				
STN3	327944.508	6248498.455	26.204				
STN4	327939.457	6248512.465	26.080				
STN5	327923.949	6248494.909	26.424				
STN6	327892.898	6248484.026	26.326				

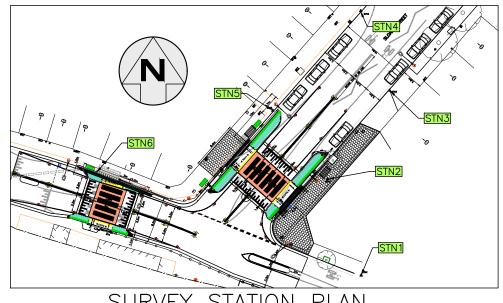

SURVEY STATION PLAN

FOR CONSTRUCTION

SLOANE ST & GROSVENOR CR, SUMMER HILL

303082 & 2 of 13 301485

10244

SHFFT REV #

HECKED & APPROVED

Odin 2/8/23

08-11-21 DESIGNED BY JALAL UDDIN 10-07-23 PROVED FOR CONSTRUCTION DRAWN BY

2-14 FISHER STREET, PETERSHAM NSW 2049 02) 9392 5000 PO Box 14 PETERSHAM

AUSGRID NOTICE OF ENTRY

N.A.

SCALES (ORIGINAL A1)

OORDINATE SYSTEM


GDA2020

NOTES & SCHEDULES

(AT SLOANE ST & GROSVENOR CR INTERSECTION)

PROPOSED RAISED PEDESTRIAN CROSSINGS

LAN NO.

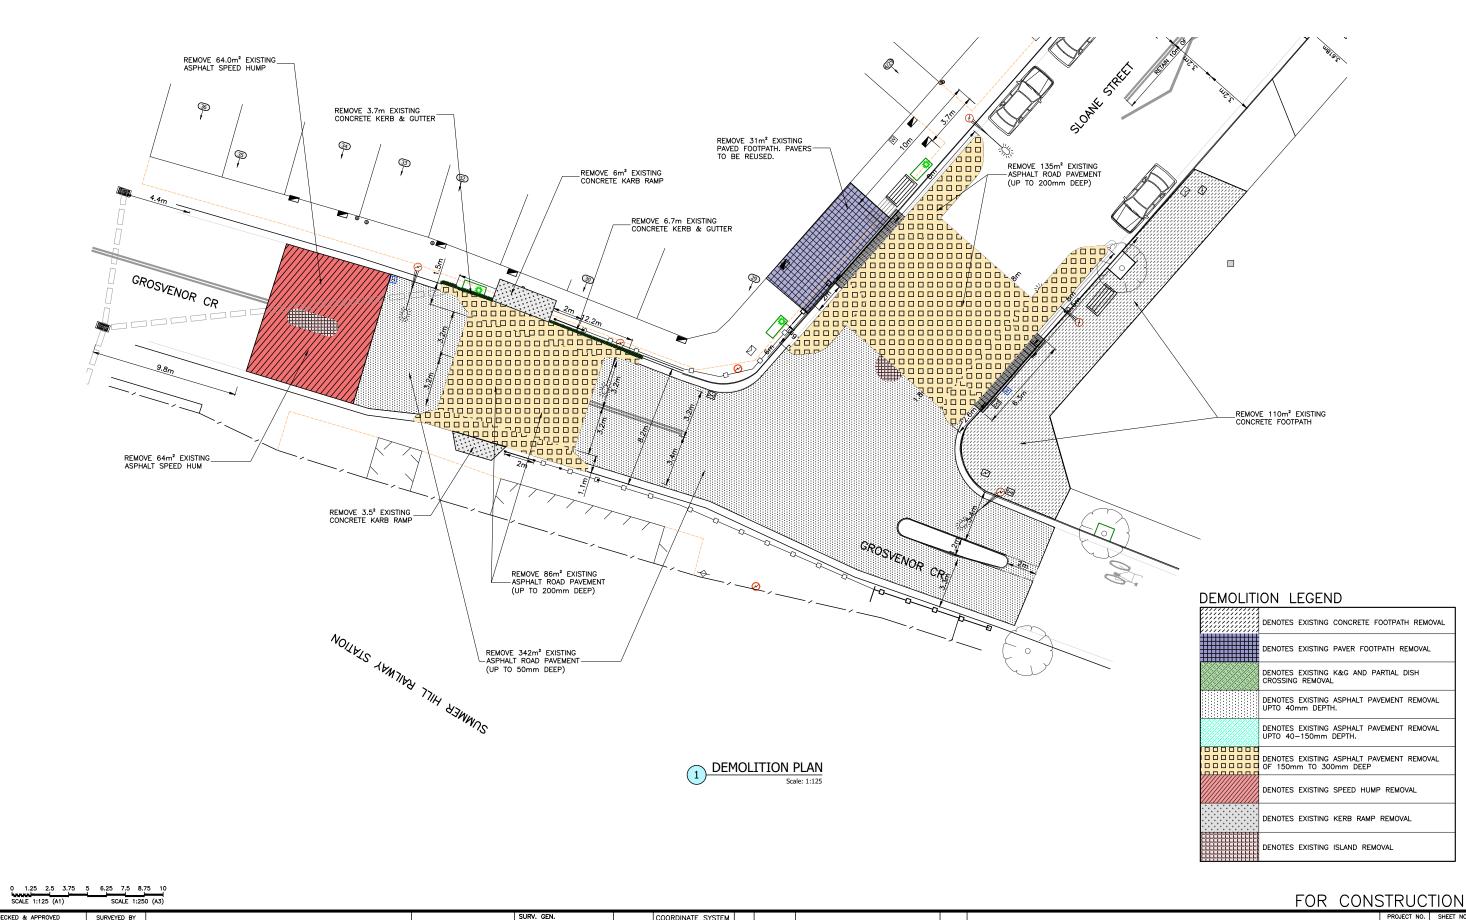

APPROVED FOR CONSTRUCTION

08-11-21


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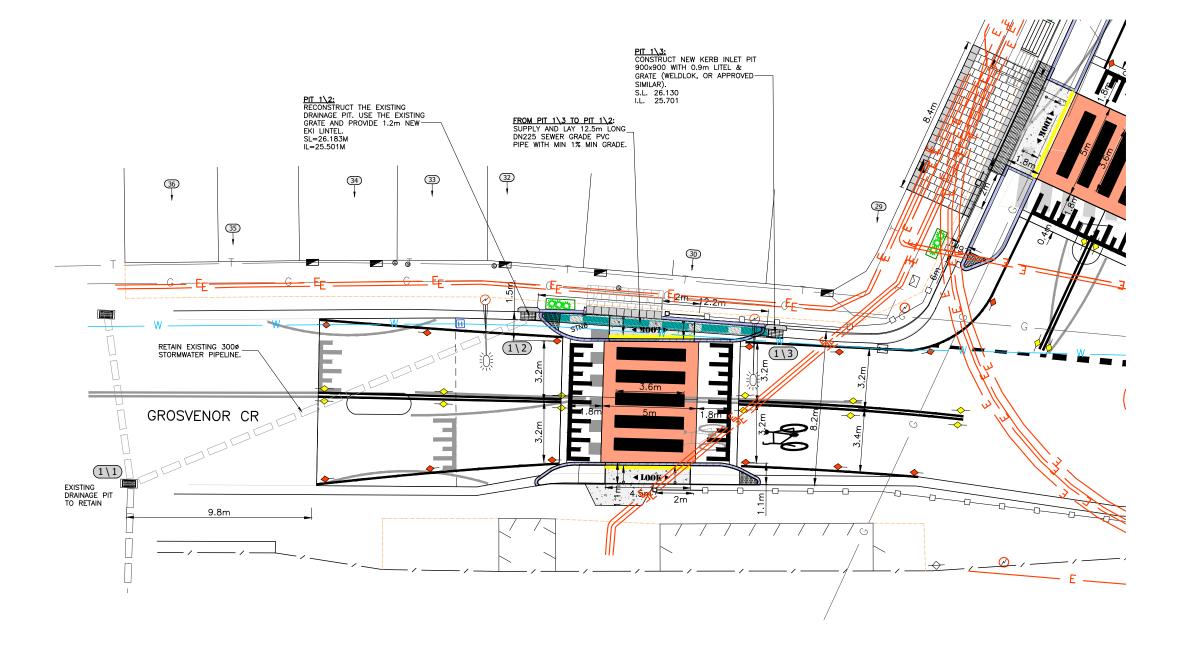
DRAWN BY JALAL UDDIN 02-06-23 inder west

2-14 FISHER STREET, PETERSHAM NSW 2049
Ph. 02) 9392 5000
Post: PO Box 14 PETERSHAM
e) council@innerwest.nsw.gov.au
Web: https://www.innerwest.nsw.gov.au



R.M.S.		OCCUPATION OF THE PROPERTY OF						SLOANE ST & GROSVENOR CR, SUMMER HILL	303082 &	3 of 13
A.G.L. / SHELL PIPELINES		GDA2020						SLOANE ST & GROSVENOR CR, SOMMER THEE	301485	J of 1 J
SYDNEY WATER		SCALES (ORIGINAL A1)						(AT SLOANE ST & GROSVENOR CR INTERSECTION)	PLAN NO.	
TELSTRA / OPTUS								(AT SLOANE ST & GROSVENOR CR INTERSECTION)	100	4.4
AUSGRID		1:125						PROPOSED RAISED PEDESTRIAN CROSSINGS	1024	44
NOTICE OF ENTRY		1.120						PROPOSED RAISED PEDESTRIAN CROSSINGS		
KERB & GUTTER								DEMOLITION PLAN	SHEET REV #	
NOTICES	DATE		REV.	DATE	DESCRIPTION	AF	PPROV.	DEMOLITION FLAN		
		•		•	•	•				



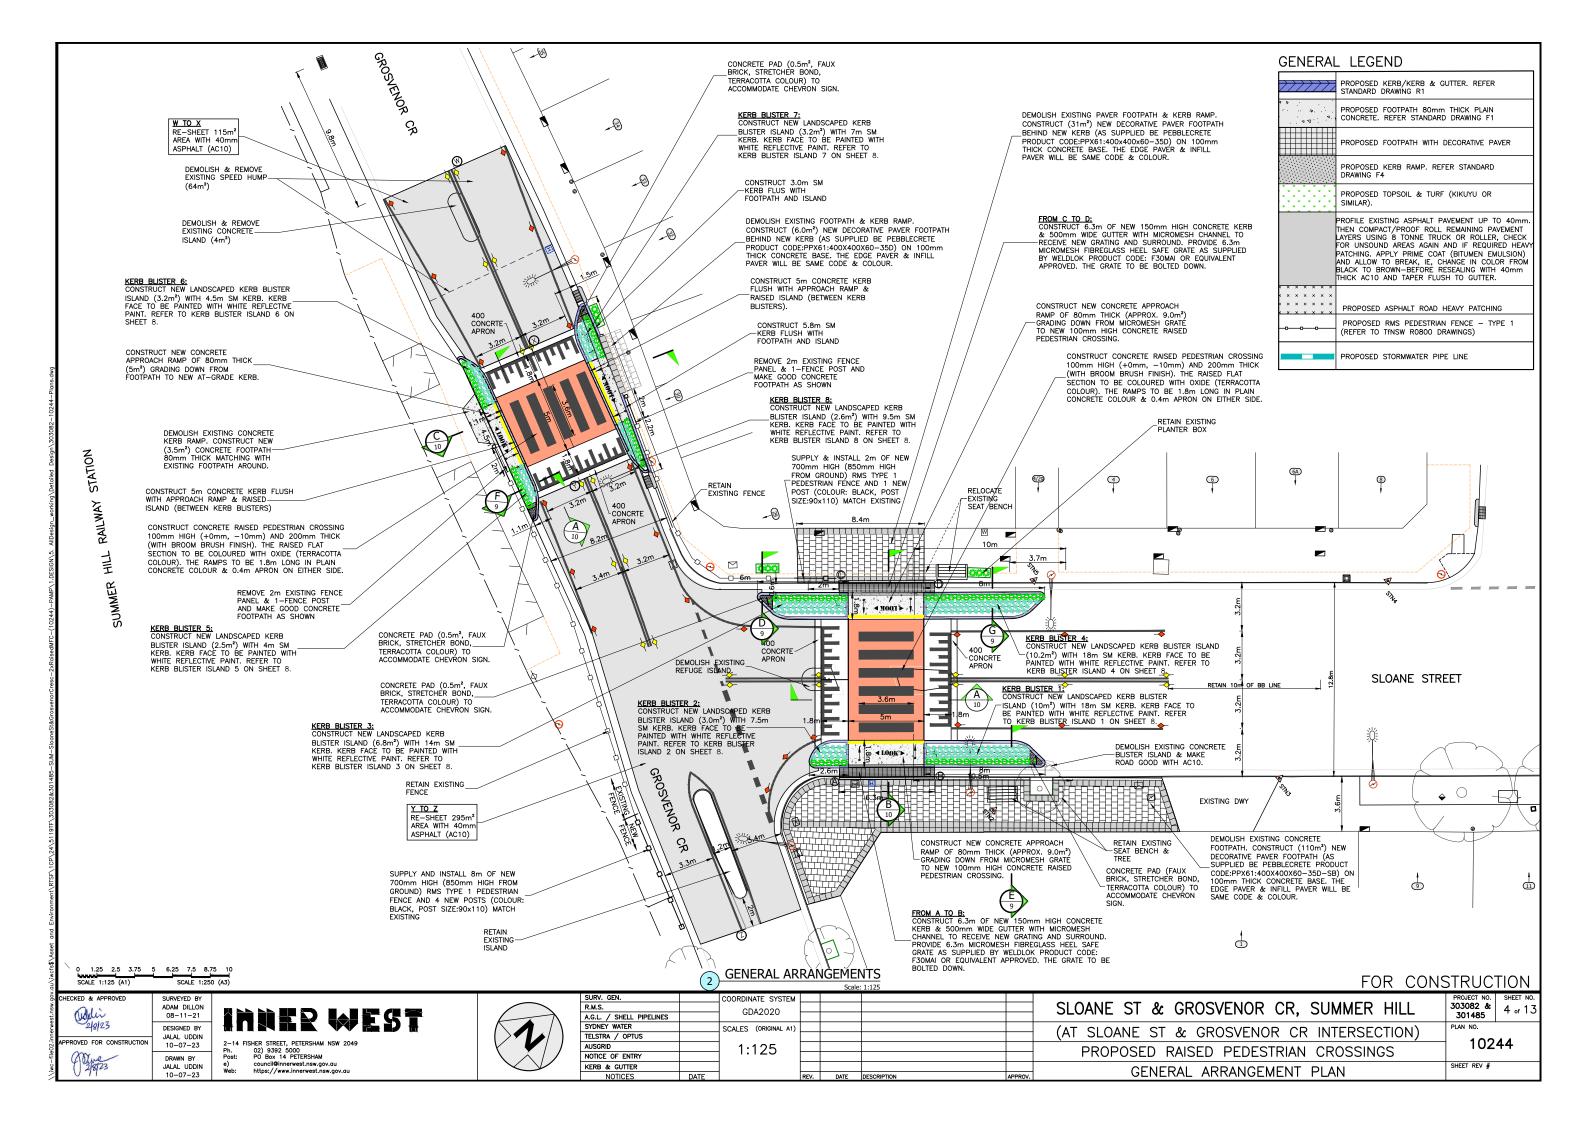

3 STORMWATER MANAGEMNT PLAN

SCALE 1:100 (A1) SCALE 1:200 (A3)

DRAWN BY JALAL UDDIN 10-07-23

ADAM DILLON 08-11-21 DESIGNED BY JALAL UDDIN 10-07-23

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Web: https://www.innerwest.nsw.gov.au



SURV. GEN.		COORDINATE SYSTEM					
R.M.S.		GDA2020					SLOANE ST & GROSVENOR CR, SUM
A.G.L. / SHELL PIPELINES		GDAZUZU					SEOTHE ST & STOSTERON SIN, SOM
SYDNEY WATER		SCALES (ORIGINAL A1)					(AT CLOANE OF & CDOCVENOD OD INTE
TELSTRA / OPTUS							\mid (AT SLOANE ST & GROSVENOR CR INTE
AUSGRID		1:100					PROPOSED RAISED PEDESTRIAN CRO
NOTICE OF ENTRY		1.100					PROPOSED RAISED PEDESTRIAIN CRO
KERB & GUTTER							CTODAWATED MANACEMENT DIV
NOTICES	DATE	1	REV.	DATE	DESCRIPTION	APPROV.	STORMWATER MANAGEMENT PLA


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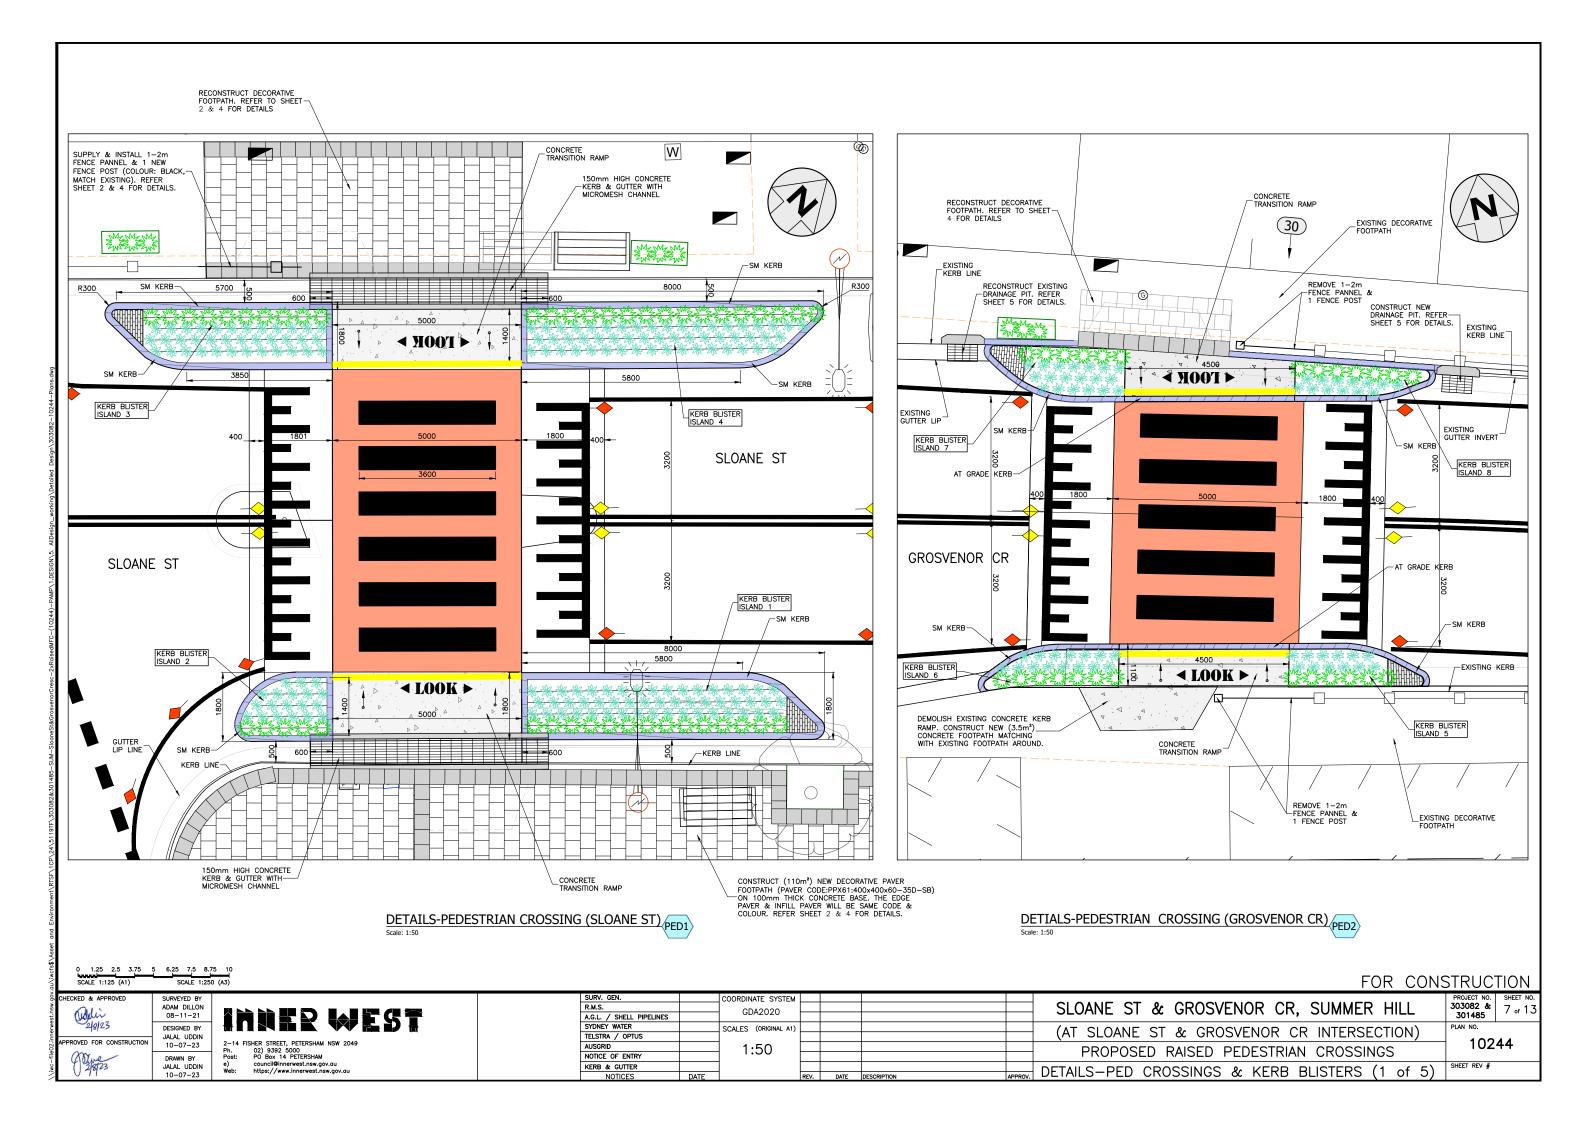
MMER HILL	PROJECT NO. 303082 & 301485	SHEET NO. 5 of 13		
TERSECTION)	PLAN NO. 10244			
ROSSINGS	102	44		


AT SLOANE ST & GROSVENOR CR INT PROPOSED RAISED PEDESTRIAN CR SHEET REV # STORMWATER MANAGEMENT PLAN


adir 2/8/23


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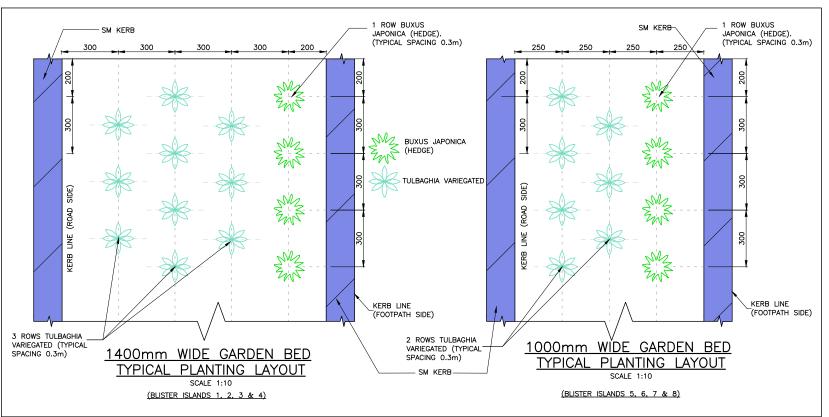




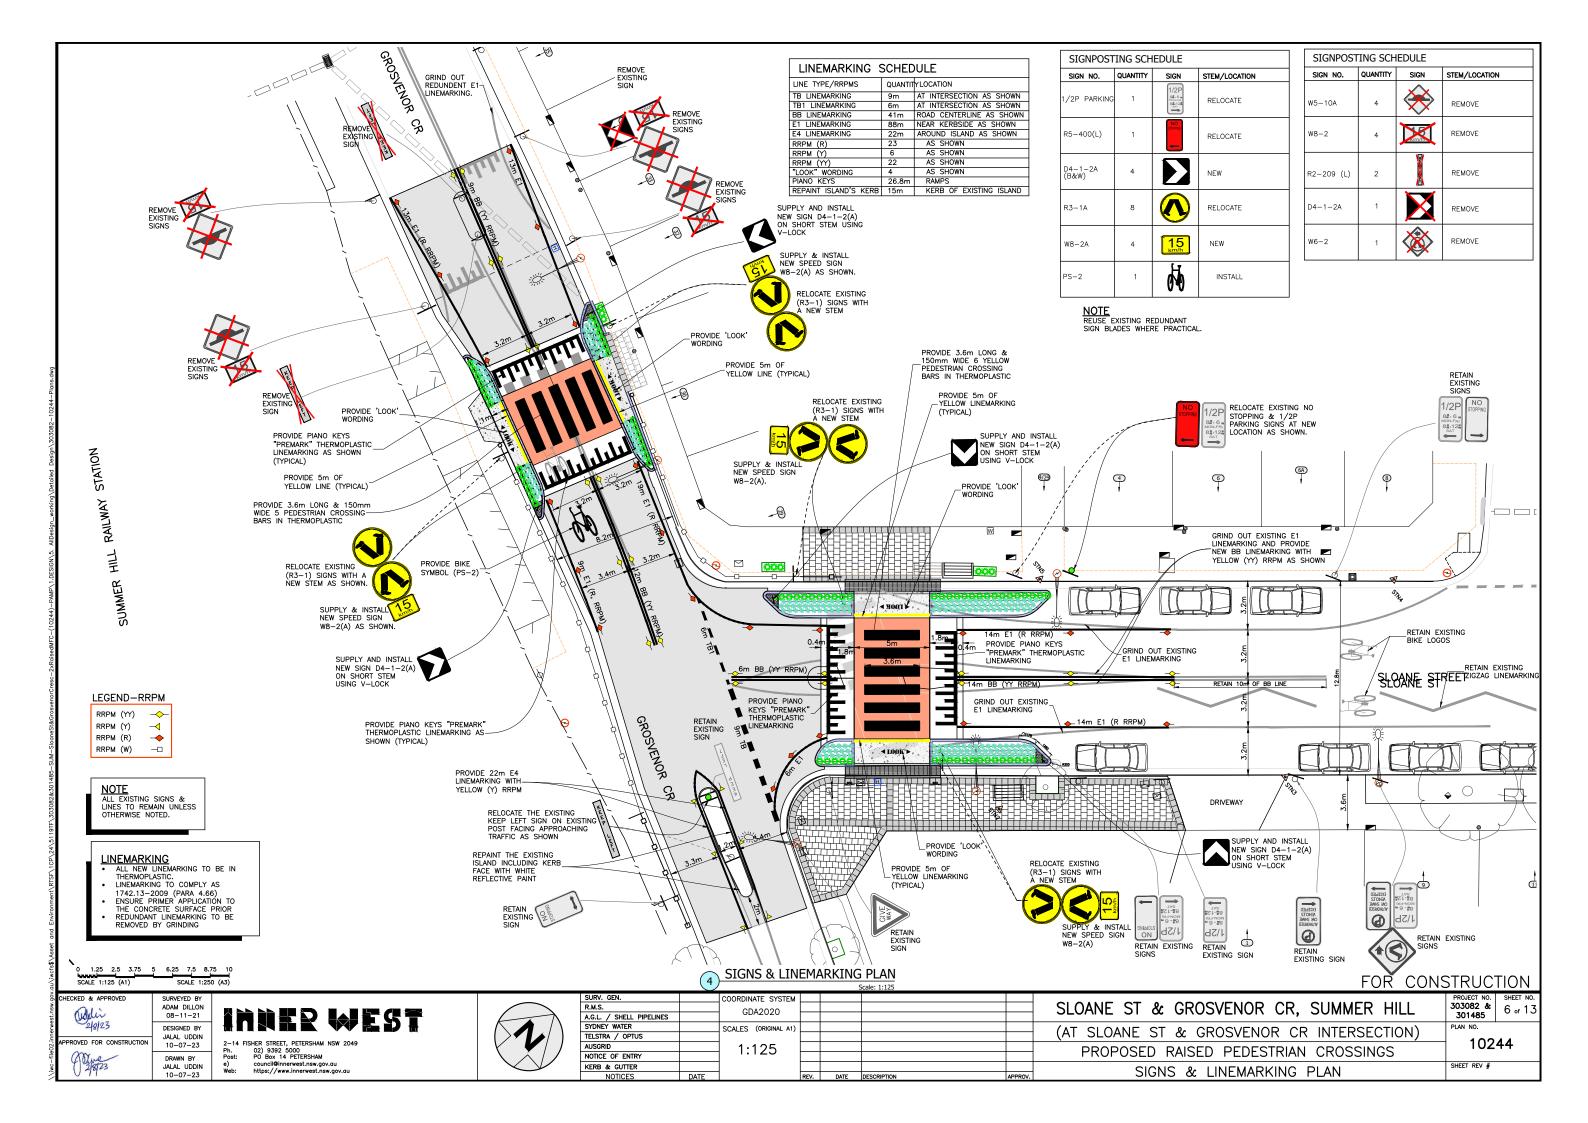

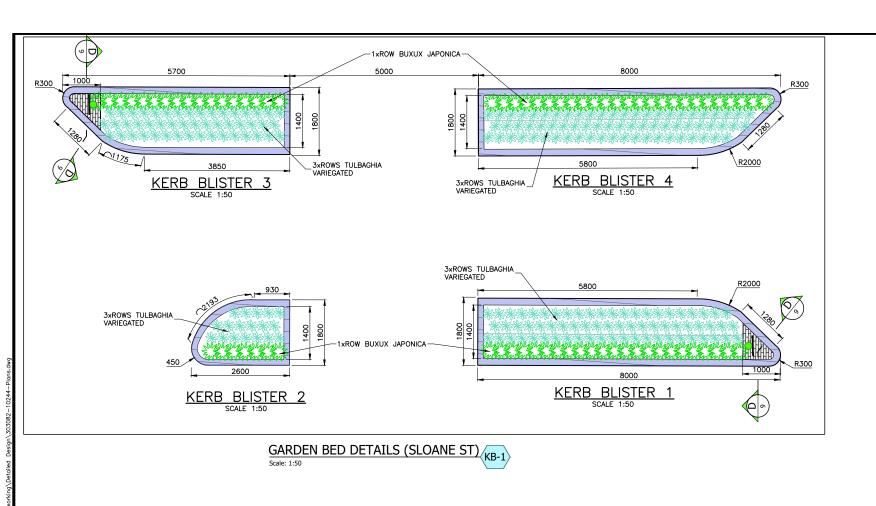

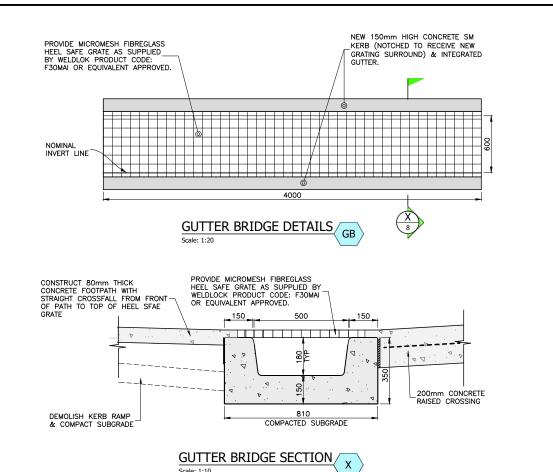GARDEN BED DETAILS (GROSVENOR CR) (KB-2)

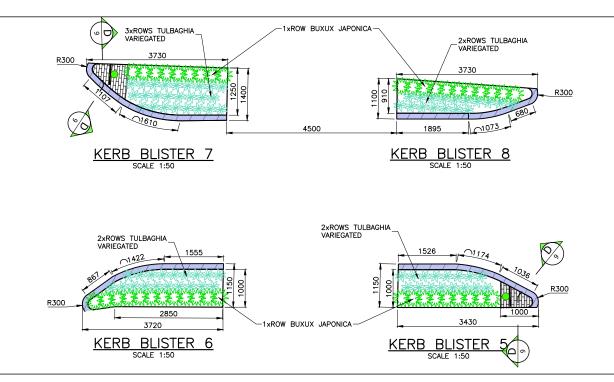

GENERAL PLANTING LAYOUT PL

FOR CONSTRUCTION

HECKED & APPROVED ADAM DILLON 08-11-21 Oddin 2/8/23 DESIGNED BY JALAL UDDIN 10-07-23 PROVED FOR CONSTRUCTION DRAWN BY JALAL UDDIN 10-07-23

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R.M.S.		GDA2020	
A.G.L. / SHELL PIPELINES		GDAZUZU	
SYDNEY WATER		SCALES (ORIGINAL A1)	
TELSTRA / OPTUS			
AUSGRID		AS SHOWN	
NOTICE OF ENTRY		73 31101111	
KERB & GUTTER			
NOTICES	DATE		RE


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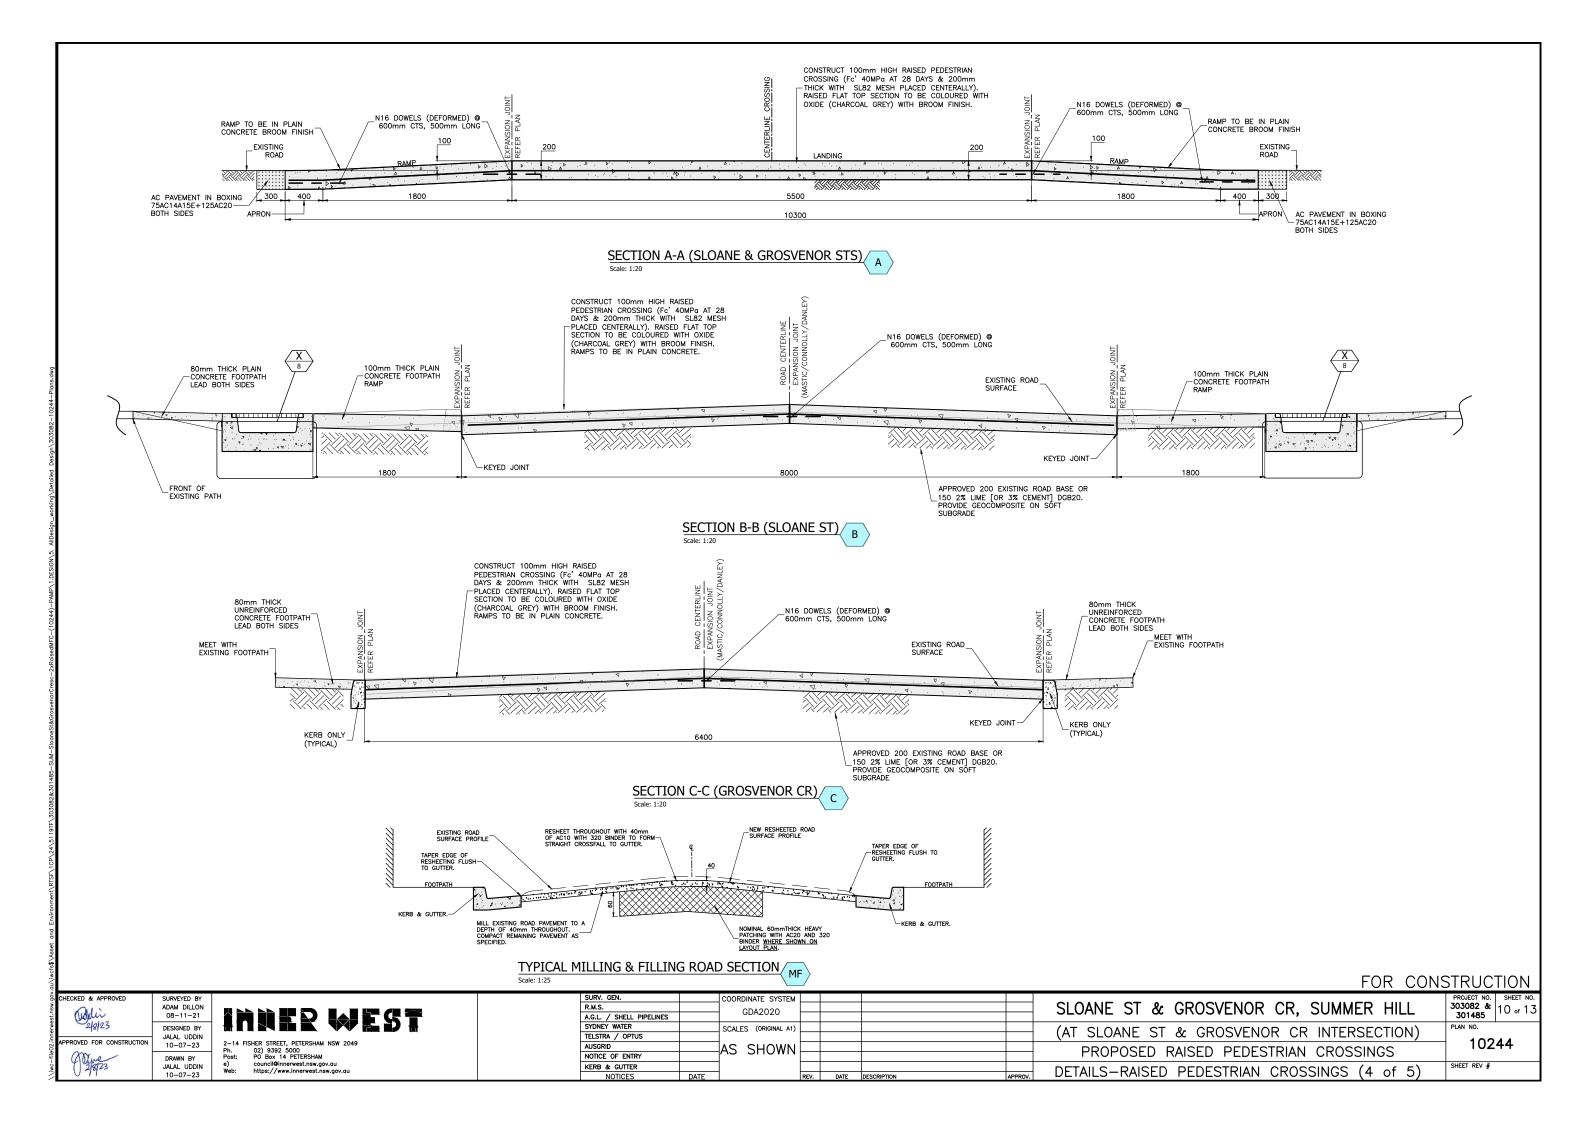
PLAN NO. 10244


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DRAINAGE NOTES 1: 1. CONCRETE STRENGTH

- KERB, KERB & GUTTER, FOOTPATH, CYCLEWAY, VEHICLE CROSSING, PRAM RAMP, EDGE STRIP: 25MPA @ 28 DAYS
- DAYS

 B) DISH CROSSING, ROAD PLATFORM/HUMP, ROAD SLAB: 40MPA @ 28 DAYS
 C) PIT: 25MPA @ 28 DAYS
- FII. ZOMPA W ZO UATS
 FOR TRAFFICKED AREAS WHERE FACILITY MUST BE OPEN TO TRAFFIC WITHIN 12 HOURS (EG VEHICLE CROSSING, ROAD SLAB, DISH CROSSING, ROAD PLATFORM/HUMP: 40 MPA WITH ACCELERATOR SUCH AS 2% CACL (REFER TO SP40HC).

- TO SP40HC).

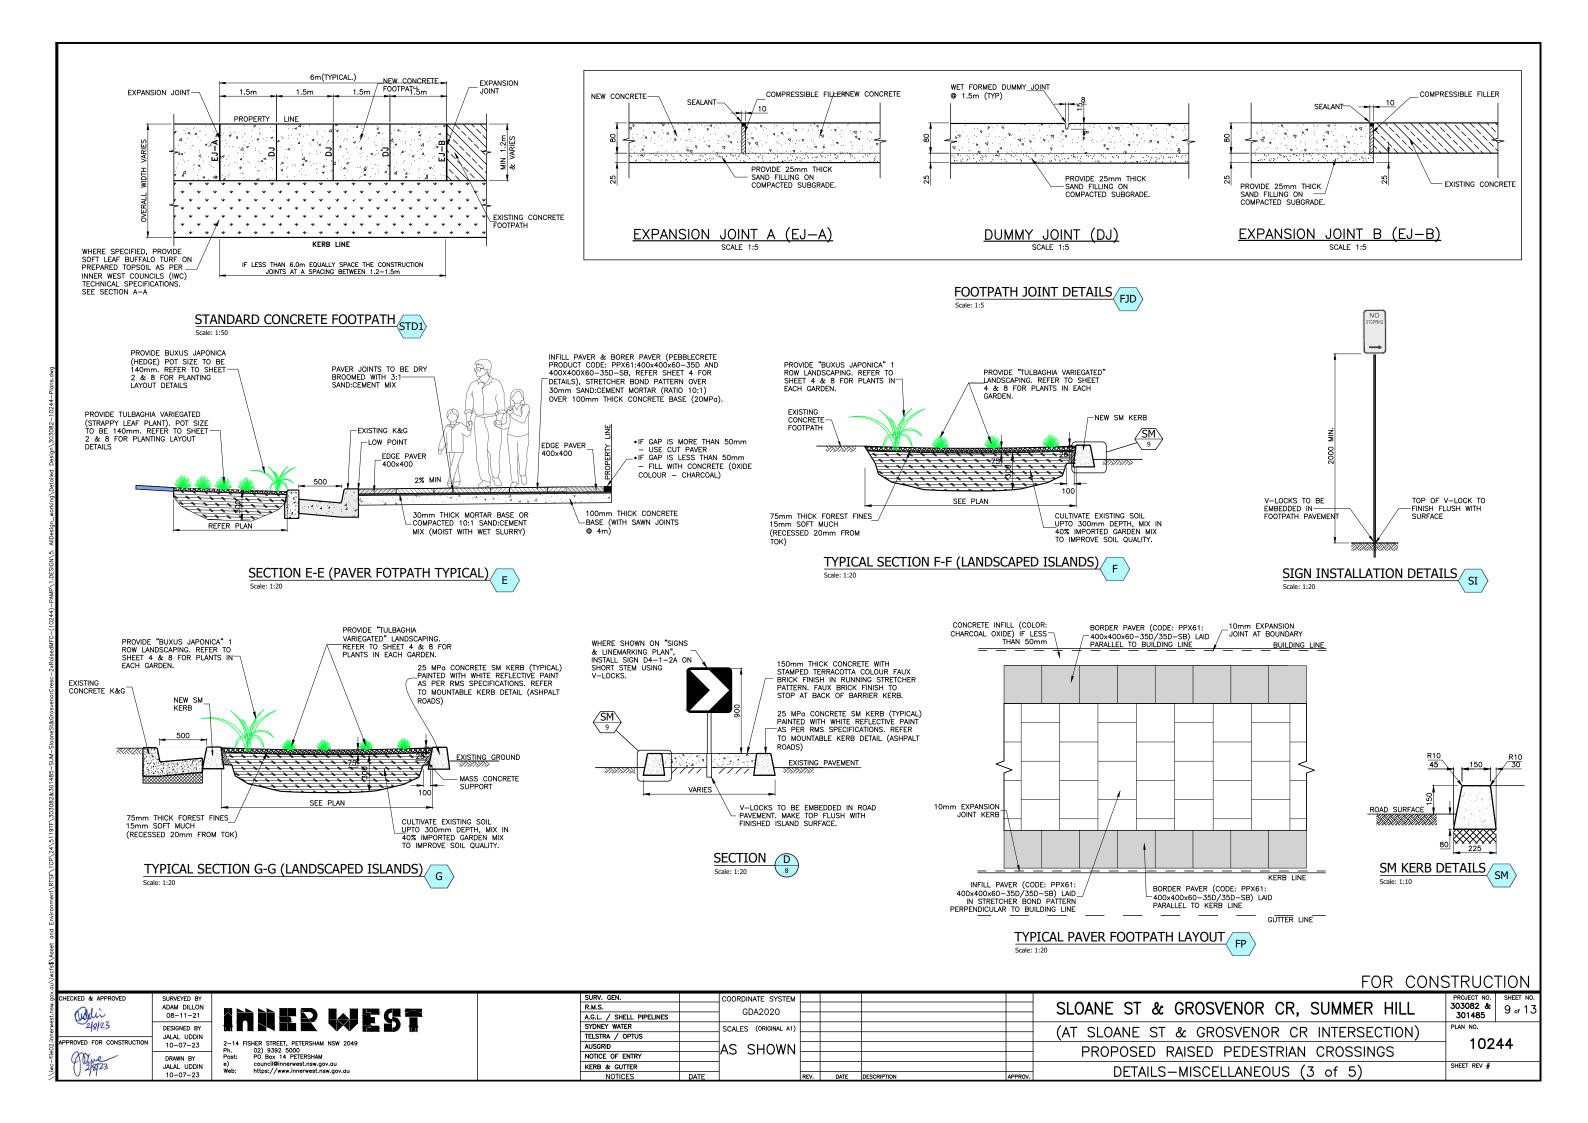 10 SP40HC).

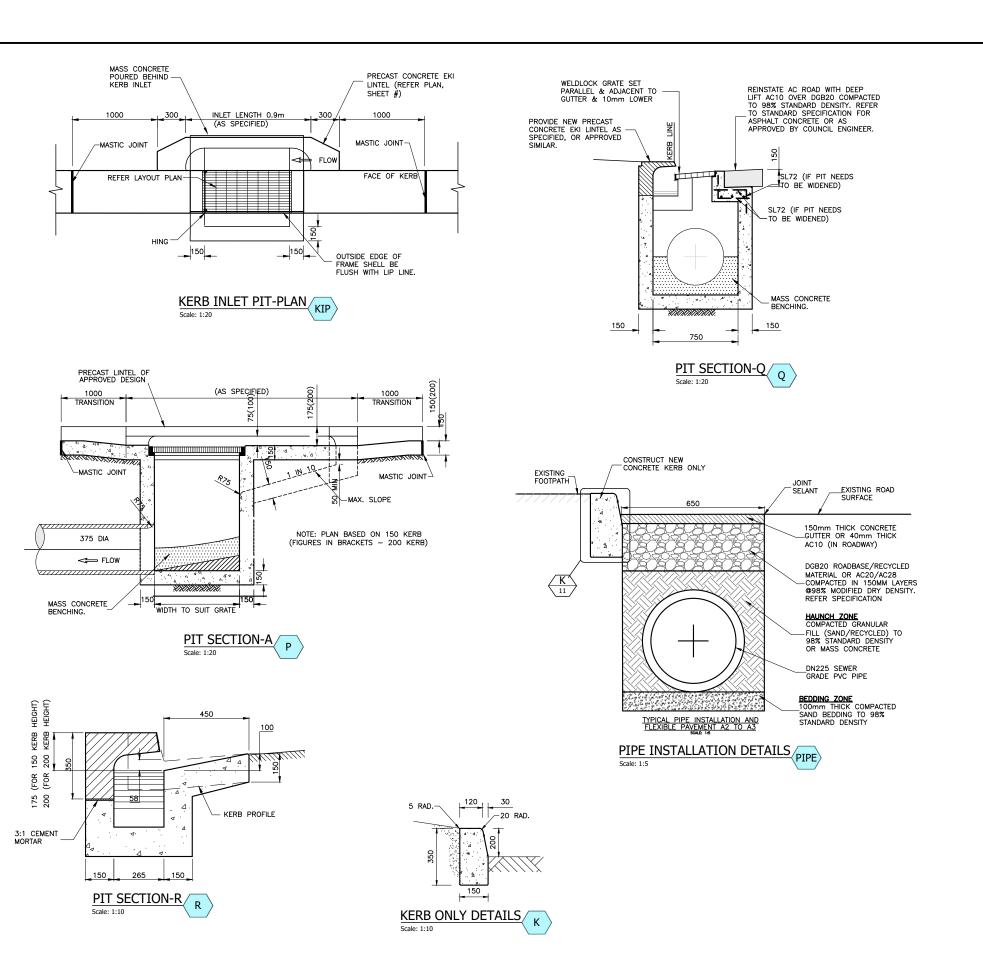 10 SP40HC).

 A) KERB, GUTTER, LAYBACK, DISH CROSSING, PIT (OUTER EXPOSED) STEEL TROWEL

 B) VEHICLE CROSSINGS, FOOTPATH, CYCLEWAY, ROAD SLABS, PRAM RAMP, ROAD HUMPS/RAMPS BROOM/BRUSH.

 C) PIT (INTERNAL): WOOD FLOAT.

 D) ALL GAPS AND SPACES IN THE CONCRETE SHELL BE RENDERED SMOOTH. A.G. GAPS AROUND ALL PIPES, UNDER GRATES/LIDS AND LINTELS AND BETWEEN CONCRETE POURS.

 3. REINFORCEMENT

 A) TO 45 4671

- MINIMUM COVER: 50MM
- A) AT ALL JOINS TO EXISTING CONCRETE/ASPHALT THE JOIN SHALL BE SAW CUT BEFORE EXCAVATION.

 B) ALL EXCAVATED MATERIAL SHALL BE REMOVED FROM THE SITE AND DISPOSED OF AT A LICENSED WASTE DISPOSAL FACILITY.

- DISPOSAL FACILITY.

 5. ROAD BASE

 A) COMPACTION: 95% STANDARD.

 B) RECYCLED DGB SPECIFICATION: FOR SUPPLY OF RECYCLED MATERIAL FOR PAVEMENTS, EARTHWORKS, AND DRAINAGE REFER TO SPECIFICATION FOR SUPPLY OF RECYCLED MATERIAL FOR PAVEMENTS, EARTHWORKS AND DRAINAGE BY INWEA (NSW) (LATEST EDITION).

 PAYFMENT AND EXCAVATION BACKFILL

- A) SEE STANDARD PLAN DY.

 TILITIES. SERVICES & SURVEY MARKS

 A) ALL UNDERGROUND UTILITY SERVICES SHALL BE CHECKED FOR LEVEL AND LOCATION PRIOR TO COMMENCEMENT OF WORKS, BY THE CONTRACTOR.
- B) ALL SERVICE COVERS AFFECTED BY THE WORKS SHALL BE ADJUSTED AS REQUIRED AND TO SUIT THE LEVELS OF THE NEW WORK. NO SERVICE FITTINGS SHALL BE COVERED.
- C) PROPERTY STORMMATER PIPES: WHERE AFFECTED, SHALL BE REPLACED WITH 90MM UPVC OR TO SUIT EXISTING AND INVERT SHALL MATCH THE GUTTER LEVEL.
- D) STATE SURVEY MARKS (SSM'S) SHALL NOT BE DISTURBED UNLESS APPROVED BY THE COUNCIL ENGINEER.

 E) AT ALL LIGHT/POWER POLES, THE CONCRETE SHALL BE ENDED 150MM CLEAR OF THE POLE AND THE GAP FILLED WITH 30MM OF 10MM COLDMIX/ASPHALTIC CONCRETE.

 NATI USE CTDID DESCENDATION.

- FILLED WITH 30MM OF 10MM COLDMIX/ASPHALTIC CONCRETE.

 8. NATURE STRIP RESTORATION

 A) MATCH EXISTING TURF.

 B) IF NEW TURF IS SPECIFIED USE SOFT LEAF BUFFALO 'SHADEMASTER', LAID ON 100MM THICK PREPARED TOPSOIL, AS SPECIFIED BY THE COUNCIL ENGINEER.

 9. EXISTING SIGNAGE

 A) SUCH SIGNAGE SHALL BE REINSTATED UNLESS THE COUNCIL ENGINEER ADVISES OTHERWISE.

 B) SIGNS REPLACED OR NEW, WITHIN THE NEW CONCRETE SHALL BE INSTALLED WITH A V-LOK.

 C) HERITAGE STREET NAME SIGNS EMBEDDED IN FOOTPATH PAVING AND KERBS CAUTION SHALL BE EXERCISED TO NOT DAMAGE THESE SIGNS AND THE CONTRACTOR SHALL LIASE WITH THE COUNCIL ENGINEER TO DETERMINE WHAT ACTION TO IMPLEMENT WHERE DISTURBANCE OF THE SIGN IS ESSENTIAL.

 10. ASPHALTIC CONCRETE

10. ASPHALTIC CONCRETE

- RMS SPECIFICATION R116 'ASPHALT (DENSE AND OPEN GRADED)'.
- A) SHALL CONFORM TO RMS SPECT 11. RESIDENT NOTIFICATION
- ALL RESIDENTS AFFECTED BY THE WORKS SHALL BE NOTIFIED AT LEAST 2 WORKING DAYS BEFORE THE RELEVANT WORK COMMENCES AND ANY REASONABLE REQUESTS ACCOMMODATED.

- SAFETY/SIGNAGE/ACCESS
 DURING CONSTRUCTION, ADEQUATE WARNING SIGNS AND BARRICADING SHALL BE PROVIDED TO ENSURE THAT THE WORK SITE MEETS THE REQUIREMENTS OF AS 1742.2 & 1743.3, AND TO PROVIDE ADEQUATE PROTECTION TO PEDESTRIANS & MOTORISTS.
- PEDESTRIAMS & MOTORISTS.

 ADEQUATE AND SAFE ACCESS FOR PEDESTRIAMS SHALL BE PROVIDED AT ALL TIMES.

 AT DRIVEWAYS PREVENTION OF ACCESS SHALL BE KEPT TO AN ABSOLUTE MINIMUM AND ARRANGEMENTS SHALL

 BE MADE WITH THE RESIDENT/BUSINESS, BY THE CONTRACTOR, FOR A SUITABLE DAY/TIME FOR THIS WORK. USE

 OF HIGHER STRENGTH CONCRETE, WITH SHORTER CURING TIME MAY BE NECESSARY.

 DIT DETAILS

- OF HIGHER STRENGTH CONCRETE, WITH SHORTER CURING TIME MAY BE NECESSARY.

 13. PIT DETAILS

 A) PROVIDE STEP IRONS WHERE PIT IS DEEPER THAN 1.0M REFER TO STANDARD PLAN D6.

 B) TOP OF BENCHING SHALL BE HALF OF OUTLET PIPE DIAMETER.

 C) 100MM DIA CORRUGATED SUBSOIL PIPE, 3M LONG, WRAPPED IN FILTER FABRIC, SHALL BE PROVIDED AT THE INVERT LEVEL ON BOTH SIDES OF EVERY INLET PIPE.

 D) WHERE POSSIBLE, LOCATE LINTELS CENTRALLY IN SAG POINTS.

 E) APPROVED PRECAST CONCRETE PITS (PART OR TOTAL) MAY BE USED IN ACCORDANCE WITH THE MANUFACTURERS INSTRUCTIONS.
- INSTRUCTIONS.

 F) WHERE THE EXTENDED CHAMBER WIDTH EXCEEDS 1.2M, PIT REINFORCEMENT SHALL BE DESIGNED BY A PROFESSIONAL ENGINEER.

 G) FOR PIT DEPTHS LESS THAN 1.5M, NO REINFORCEMENT IS REQUIRED. FOR PIT DEPTHS BETWEEN 1.5M AND 3.0M, PROVIDE SL72 AT 50MM COVER TO INSIDE FACE WALLS AND BASE. PROVIDE 400MM LAP AT CORNERS. FOR PIT DEPTHS GREATER THAN 3.0, DESIGN IS REQUIRED BY A PROFESSIONAL ENGINEER.

 H) FOR JUNCTION AND SURCHARGE PITS, THE MINIMOM INTERNAL DIMENSIONS SHALL BE:

 (I) DEPTH GREATER THAN 1800MM 900X990MM UNLESS OTHERWISE APPROVED BY COUNCIL.

 (II) DEPTH GREATER THAN 1800MM REFER TO STANDARD PLAN D3.

 14. STORMWATER PIT GRATES

 A SMALL BE WELLOW LINKED HOT DIRPED CAN MANISTIC CC78—50 (OP A BAPPOVED EQUIRALENT) SET PAPALLET TO

- STALL BE WELDLOK HINGED HOT DIPPED GALVANISED GG78—50 (OR APPROVED EQUIVALENT), SET PARALLEL TO GUTTER, AND WITH LOCKING CLIP. FOR INDUSTRIAL ROADS AND WHERE DIRECTED BY THE COUNCIL ENGINEER, USE WELDLOK HINGED HOT DIPPED GALVANISED GG78—42A (OR APPROVED EQUIVALENT).

 THE GRATE WHEN OPEN SHALL CLEAR THE LINTEL/KERB.

- B) THE GRATE WHEN OPEN SHALL CLEAR THE LINIEL/KERB.

 15. <u>DIMENSIONS</u>

 A) ALL DIMENSIONS ARE IN MILLIMETERS UNLESS SHOWN OTHERWISE.

 16. <u>GENERAL</u>

 A) ALL WORKS SHALL BE CARRIED OUT TO COUNCIL'S SPECIFICATION, TO BEST PRACTICE STANDARDS, AND TO THE
- SATISFACTION OF COUNCIL'S SUPERVISING ENGINEER.

 B) THE WORK STIES SHALL BE KEPT IN A CLEAN, TIDY, AND SAFE CONDITION AT ALL TIMES AND TO THE SATISFACTION OF COUNCIL'S ENGINEER.

17. DOCUMENT PRIORITY

A) THIS PLAN SUPERSEDES ANY STATEMENTS ON OTHER DOCUMENTS, EG SPECIFICATIONS, OTHER PLANS, ETC, UNLESS ADVISED BY THE COUNCIL ENGINEER.

- 18. INSPECTIONS
 INSPECTION
 INSPEC

- PITS FORMED

 BASE AND WALLS OF PITS POURED. LINTELS AND GRATES PLACES AND FORMWORK IN PLACE.

FOR CONSTRUCTION

HECKED & APPROVED Odin 2/8/23 PROVED FOR CONSTRUCTION

08-11-21

DESIGNED BY

JALAL UDDIN 10-07-23

DRAWN BY

2-14 FISHER STREET, PETERSHAM NSW 2049 02) 9392 5000 PO Box 14 PETERSHAM

SURV. GEN.		COORDINATE SYSTEM
R.M.S.		GDA2020
A.G.L. / SHELL PIPELINES		GDAZUZU
SYDNEY WATER		SCALES (ORIGINAL A1)
TELSTRA / OPTUS		
AUSGRID		AS SHOWN
NOTICE OF ENTRY		73 31101111
KERB & GUTTER		
NOTICES	DATE	

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_					(AT SI
					(AT SL
					PR
	DD/	DATE	DECODIDATION	ADDDON/	

NE ST & GROSVENOR CR, SUMMER HILL LOANE ST & GROSVENOR CR INTERSECTION) ROPOSED RAISED PEDESTRIAN CROSSINGS DETAILS-STORMWATER (5 of 5)

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