


INNER WEST

INNER WEST COUNCIL SMITH STREET, SUMMER HILL AT LACKEY STREET/MORRIS STREET INTERSECTION PROPOSED STREETScape WORKS

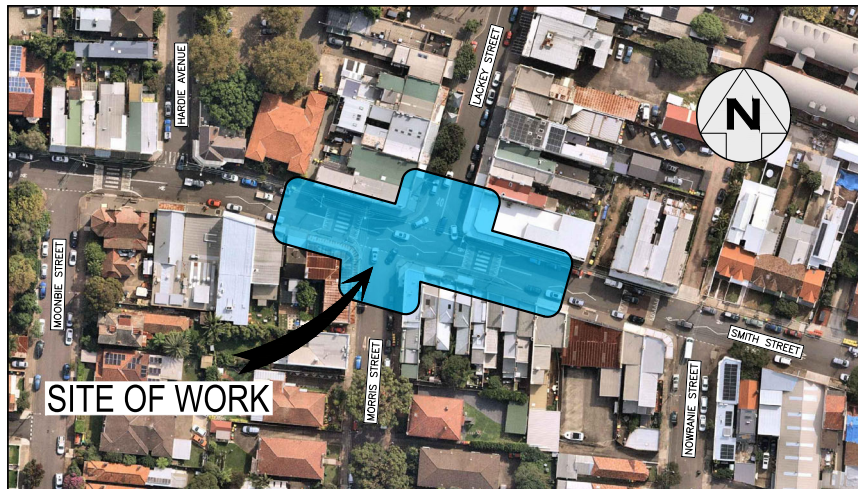

LOCALITY SKETCH
N.T.S.

IMAGE COURTESY OF NEARMAP

PROJECT #: 303083
PLAN #: 10218

**FOR
CONSTRUCTION**



UTILITIES, IF SHOWN, ARE
DIAGRAMMATIC ONLY. CONTRACTORS
ARE RESPONSIBLE TO LOCATE AND
AVOID DAMAGE TO THEM AS
SPECIFIED BY EACH UTILITIES
EXCAVATION GUIDELINES.

DRAWINGS INDEX

SH #	SHEET TITLE
1	COVER SHEET
2	NOTES & SCHEDULES
3	DEMOLITION PLAN
4	GENERAL ARRANGEMENTS – CIVIL WORKS
5	GENERAL ARRANGEMENT – STORMWATER
6	SIGNS & LINEMARKING PLAN
7	LONGSECTION MC01 (GUTTER LIP)
8	LONGSECTION MC02 (GUTTER LIP)
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10	LONGSECTION MC04 (GUTTER LIP)
11	LONGSECTION MC05 (STORMWATER LINE 1&2)
12	DETAILS (1 of 2)
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14	LINEMARKING GENERAL SPECIFICATIONS
15	UNDERGROUND UTILITIES PLAN

UNLESS DETAILED ON THIS DRAWING
ALL WORK SHALL CONFORM TO



CHECKED & APPROVED <i>Asif Ahmad</i> 19/4/23	SURVEYED BY ADAM DILLON 01-07-2022	INNER WEST 2-14 FISHER STREET, PETERSHAM NSW 2049 Ph: (02) 9392 2000 Post: PO Box 14, PETERSHAM Council@innerwest.nsw.gov.au Web: https://www.innerwest.nsw.gov.au	DOCUMENT REFERENCE	SURV. GEN.	COORDINATE SYSTEM	PROJECT NO. 303083	SHEET NO. 1 of 15
			SERVICES AFFECTED	R.M.S. A.G.L. / SHELL PIPELINES SYDNEY WATER TELSTRA / OPTUS AUSGRID NOTICE OF ENTRY KERB & GUTTER NOTICES	MGA2020 SCALES (ORIGINAL A1) N.A.		
APPROVED FOR CONSTRUCTION <i>Asif Ahmad</i> 19/4/23	DESIGNED BY ASHFAQ AHMAD 19-09-2022						SHEET REV # .

GENERAL NOTES

- DURING CONSTRUCTION THE WORK IS TO BE SIGNPOSTED AND MARKED TO THE REQUIREMENTS OF AS1742.2-2009 AND AS1742.3-2009 "TRAFFIC CONTROL DEVICES FOR WORKS ON ROADS".
- ALL WORK IS TO BE CARRIED OUT IN ACCORDANCE WITH COUNCIL'S TECHNICAL SPECIFICATION (AUS-SPEC) AND TO BEST PRACTICE STANDARDS AND TO THE SATISFACTION OF COUNCIL'S MANAGER, CAPITAL PROGRAM.
- OVERLAY TO CONSIST OF 40mm THICK AC10. REFER TO RELEVANT SECTION FOR DETAILS.
- ALL RESIDENTS AFFECTED BY THE PROPOSED WORKS SHOULD BE NOTIFIED AT LEAST 3 WORKING DAYS BEFORE THE COMMENCEMENT OF ROADWORKS.
- EXISTING SURFACE FITTINGS OF THE SERVICES SHALL BE ADJUSTED AS NECESSARY TO THE REQUIREMENTS OF THE RELEVANT AUTHORITY.
- SUITABLE VEHICULAR ACCESS SHALL BE MAINTAINED TO EACH LOT OR ALTERNATIVE ARRANGEMENTS MADE WITH THE OWNERS.
- WORK ONLY PERMITTED TO BE CARRIED OUT BETWEEN THE HOURS OF 7am AND 5pm FROM MONDAY TO SATURDAY, NO WORK PERMITTED ON SUNDAYS.
- ALL SERVICES TO BE CHECKED FOR LEVEL AND LOCATION PRIOR TO COMMENCEMENT OF WORK.
- ALL SERVICES AFFECTED BY NEW WORK TO BE ADJUSTED AS REQUIRED TO SUIT. NO SERVICE SURFACE FITTINGS ARE TO BE COVERED.
- PROJECT MANAGER TO INSPECT FOR ALL UNSOUND AREAS BEFORE PROFILING AC PAVEMENT AND AFTER PROOF ROLLING. WEAK SECTIONS ARE TO BE IDENTIFIED AND HEAVY-PATCHED TO A NOMINAL THICKNESS OF 150mm WITH AC28 BEFORE RESEALING IN ACCORDANCE TO TYPICAL CROSS-SECTION.
- THE LOCATION OF UNDERGROUND SERVICES AND HOUSE CONNECTIONS HAVE NOT BEEN SHOWN ON THIS PLAN. MUST BE VERIFIED ON-SITE BY THE CONTRACTOR WITH REPRESENTATIVES FROM EACH OF THE UTILITY AUTHORITIES. CONTACT DIAL BEFORE YOU DIG PH: 1100
- EXISTING SIGNS TO REMAIN UNLESS OTHERWISE NOTED.
- ALL LINEMARKING AND RPPM'S REMOVED OR AFFECTED DURING THE COURSE OF THE WORKS IS TO BE REINSTATEd UNLESS NOTED OTHERWISE. ALL LINEMARKING IS TO COMPLY WITH RMS SPECIFICATION R141 - "PAVEMENT MARKING" AND TO BE THERMOPLASTIC TYPE AND INCLUDE PLASTIC BEADS IN ACCORDANCE WITH RMS SPECIFICATIONS 3357 AND 3353 RESPECTIVELY. ALL RPPM'S TO COMPLY WITH RMS SPECIFICATION R142. ALL ROAD COLOURED PAINT MARKINGS TO COMPLY WITH RMS SPECIFICATION R110
- AREAS OF HEAVY PATCHING ARE TO BE MARKED OUT ON SITE PRIOR TO COMMENCEMENT OF WORK BY PROJECT MANAGER AND CIVIL DESIGN ENGINEER. REFER TO NOTE 10.
- THE CONTRACTOR SHALL ENSURE THAT ALL EXISTING SURROUNDING AREAS NOT REQUIRED TO BE REPLACED OR RESET AS PART OF THE WORKS SHALL NOT BE DAMAGED DURING THE COURSE OF THE WORKS.
- ASPHALTIC CONCRETE SHALL CONFORM TO RMS SPECIFICATIONS R116 - "ASPHALT (DENSE GRADED AND OPEN GRADED)".
- INSPECTIONS ARE REQUIRED AT THE FOLLOWING STAGES AND AS OTHERWISE DIRECTED BY THE MANAGER, CAPITAL PROGRAM.
 - ROAD PAVEMENT
 - A. SUBGRADE TRIMMED AND CONSOLIDATED PRIOR TO FIRST PAVEMENT COURSE. (NOTE: SINGLE AXLE TRUCK WITH 8t LOAD TO BE AVAILABLE FOR PAVEMENT TEST.)
 - B. EACH PAVEMENT LAYER SPREAD AND COMPACTED. (NOTE: SINGLE AXLE TRUCK WITH 8t LOAD TO BE AVAILABLE FOR PAVEMENT TEST.)
 - C. PAVEMENT COMPLETED PRIOR TO SEALING
 - CONCRETE WORKS
 - (i) EXCAVATION COMPLETED
 - (ii) FORMWORK AND REINFORCEMENT SET
 - (iii) CONCRETE FORMED AND CURED
- LINEMARKING AND SIGNPOSTING TO BE INSTALLED AS SOON AS PRACTICABLE.
- KERB FACES OF ALL ISLANDS TO BE PAINTED WHITE AND TO INCLUDE GLASS BEADS IN ACCORDANCE WITH RMS SPECIFICATION No. 3353.
- KERB RAMPS TO BE PROVIDED WHERE SHOWN TO INNER WEST COUNCIL STANDARD BY MAINTAINING WITH MAXIMUM GRADIENT 1 IN 8.
- USE CAUTION TO PRESERVE HERITAGE LISTED STREET NAME PLAQUES EMBEDDED IN FOOTPATH WHEN CONSTRUCTION FOOTPATHS AND KERB RAMPS (IF SHOWN), NO STATE SURVEY MARKS ARE TO BE REMOVED PRIOR TO CONSULTING WITH COUNCIL'S SURVEYOR.
- INSTALL "CHANGED TRAFFIC CONDITIONS AHEAD" SIGNS ON ALL APPROACHES 75-100m IN ADVANCE OF THE INTERSECTION AND MAINTAIN FOR 3 MONTHS.
- ALL TRAFFIC SIGNS TO COMPLY WITH RMS Q SPECIFICATION R143 AND TO BE OF HIGH INTENSITY CLASS 1.
- ALL PATHWAYS WHERE AFFECTED BY CONSTRUCTION WORKS SHALL BE RECONSTRUCTED TO COUNCIL'S STANDARD SPECIFICATION.
- EXISTING LINEMARKING IS TO BE REMOVED BY GRINDING WHERE NEW LINEMARKING IS REQUIRED OR PROVIDED.
- ALL SIGNPOSTING ON SPLITTER, KERB OR PEDESTRIAN REFUGE ISLANDS TO BE ERRECTED USING V-NOTCH INSERTS EMBEDDED INTO CONCRETE (OR SIMILAR AS APPROVED BY COUNCIL).
- ALL CONCRETE ELEMENTS TO BE OF 25MPa UNLESS OTHERWISE STATED.

IMPORTANT

IN CASE OF EMERGENCY, CONTACT THE FOLLOWING SERVICE AUTHORITIES; IF THEIR SERVICES ARE INVOLVED/AFFECTED

AUTHORITY	CONTACT NO.	SERVICE TYPE
ARNET PTY LTD	1300 275 662	FIBRE OPTIC ASSETS
AUSGRID	02 4951 0899	LOW VOLTAGE LINE
JEMENA GAS SOUTH	1300 880 906	PRIMARY & DISTRIBUTION
NBN CO	1800 825 329	BURIED FIBRE OPTIC CABLES
NEXTELGEN	1800 032 532	BURIED FIBRE OPTIC CABLES
OPTUS	1800 505 777	BURIED FIBRE OPTIC CABLES
SYDNEY WATER	13 20 92	WATER & SEWER LINES
TELSTRA	1800 653 935	BURIED CABLES
VERIZON	02 9434 5000	BURIED CABLES

NOTE

CONTRACTOR TO REINSTATE ALL KERB & GUTTER, ROAD PAVEMENT AND FOOTPATHS AFFECTED BY WORKS TO INNER WEST COUNCIL STANDARD AND TO THE SATISFACTION OF THE PROJECT MANAGER

EROSION AND SEDIMENT CONTROL

- GENERAL MEASURES**
 - STOCKPILES SHALL BE CONFINED TO ONE CENTRAL AREA WHERE POSSIBLE.
 - EROSION CONTROL MEASURES TO BE IN PLACE PRIOR TO COMMENCEMENT OF ANY CONSTRUCTION WORK. MEASURES ARE APPLIED TO PROTECT ADJOINING PROPERTIES FROM EROSION AND SILT DAMAGE.
 - EROSION CONTROL MEASURES NOT TO BE REMOVED UNTIL CONSTRUCTION IS COMPLETED AND SITE HAS BEEN REHABILITATED.
 - REHABILITATION INCLUDES COMPLETION OF ALL CONSTRUCTION WORK AND LANDSCAPING, SEEDING OR TURFING OF ALL BATTERS AND FILL AREAS.
 - PIPED DRAINAGE NETWORKS SHOULD BE INSTALLED AND CONNECTED AS EARLY AS POSSIBLE.
 - ALL AREAS NOT SUBJECT TO CONSTRUCTION WORKS SHALL BE RETAINED FREE FROM DISTURBANCE OR DAMAGE DURING THE CURRENCY OF THE CONTRACT. SHOULD THESE AREAS BECOME DISTURBED OR DAMAGED, THEY SHALL BE RE-INSTATED BY THE CONTRACTOR.
 - ALL AREAS NOT SUBJECT TO CONSTRUCTION WORKS SHALL BE RETAINED FREE FROM DISTURBANCE OR DAMAGE DURING THE CURRENCY OF THE CONTRACT. SHOULD THESE AREAS BECOME DISTURBED OR DAMAGED, THEY SHALL BE RE-INSTATED BY THE CONTRACTOR AT NO COST TO THE PRINCIPAL.
- STABILIZATION OF DISTURBED AREAS.**
 - STABILIZATION OF DISTURBED AREAS SHALL BE IN ACCORDANCE WITH COUNCIL'S SPECIFICATION FOR GRASSING AND/OR SPECIFICATION FOR LANDSCAPE WORKS. THE FOLLOWING SHALL BE APPLIED FOR THE CONTROL OF EROSION AND SEDIMENTATION:
 - (a) STABILIZATION OF DENUDED AREAS SHALL COMMENCE AS SOON AS POSSIBLE AFTER THE AREAS HAVE BEEN DISTURBED.
 - (b) ALL STABILIZATION MEASURES SHALL BE UNDERTAKEN PRIOR TO THE END OF THE MAINTENANCE PERIOD.
- MAINTENANCE**
 - ALL SEDIMENT AND EROSION CONTROL DEVICES SHALL BE MAINTAINED IN A SATISFACTORY WORKING ORDER THROUGHOUT THE CONTRACT, MAINTENANCE AND DEFECTS LIABILITY PERIODS OR UNTIL SUCH EARLIER TIME AS THE AREA HAS BEEN STABILIZED AND THE SUPERINTENDENT DIRECTS THAT THE DEVICE BE REMOVED.
 - THE CONTRACTOR SHALL INSPECT ALL DEVICES AFTER EACH STORM FOR STRUCTURAL DAMAGE OR CLOGGING BY SILT AND OTHER DEBRIS AND MAKE PROMPT REPAIRS OR REPLACEMENT.
- SEDIMENT CONTROL DEVICES (S.C.D.)**
 - THESE SHALL BE CONSTRUCTED AT INLETS TO STORMWATER SYSTEMS TO TRAP THE SEDIMENT IN RIFF OFF SECTION 1102/03/04/06 OF THE N.S.W. DEPARTMENT OF HOUSING CONSTRUCTION SPECIFICATION, 1989 EDITION, SHALL APPLY.

PLANTING NOTES

- SUBGRADE TO BE CULTIVATED TO A MINIMUM DEPTH OF 100mm.
- PLANTING AREAS TO BE EXCAVATED TO A MINIMUM DEPTH OF 500mm AND FILLED WITH PREMIUM GRADE GARDEN SOIL.
- INORGANIC MULCH LAYER MINIMUM 75mm DEPTH IS TO BE SPREAD THROUGHOUT ALL PLANTING AREA.
- GARDEN AREA TO BE WATERED TWICE A WEEK FOR 3 MONTHS, OR AS REQUIRED TO MAINTAIN HEALTHY GARDEN.
- QUANTITIES OR SIZE OF PLANTS SPECIFIED ARE NOT TO BE DECREASED TO ENSURE ADEQUATE ESTABLISHMENT.

UNDERGROUND UTILITY SERVICES

- THE LOCATION OF UNDERGROUND UTILITY SERVICES SHOWN ON THIS PLAN ARE INDICATIVE ONLY. COUNCIL CANNOT GUARANTEE THEIR ACCURACY.
- PRIOR TO CONSTRUCTION, IT IS THE RESPONSIBILITY OF THE CONTRACTOR TO CARRY OUT THEIR OWN SURVEY SEARCH BY CONTACTING "BEFORE YOU DIG AUSTRALIA" (PH: 1100 OR WWW.1100.COM.AU). THE CONTRACTOR MUST CHECK THE LOCATION AND DEPTH OF ALL SERVICES PRIOR TO THE COMMENCEMENT OF WORKS.
- ALL SERVICES AFFECTED BY NEW WORK TO BE ADJUSTED AS REQUIRED TO SUIT NEW SURFACE LEVELS. (TO THE REQUIREMENTS OF THE RELEVANT SERVICE AUTHORITY).
- NO SERVICE SURFACE FITTINGS ARE TO BE COVERED.
- ALL PERMITS REQUIRED MUST BE OBTAINED FROM THE RELEVANT SERVICE AUTHORITY PRIOR TO COMMENCEMENT OF WORK.
- ANY DAMAGE TO SERVICES SHALL BE RECTIFIED BY THE CONTRACTOR OR THE RELEVANT AUTHORITY AT NO COST TO COUNCIL.

PROTECTING SURVEY INFRASTRUCTURE

SURVEY MARKS SHALL BE PRESERVED AT ALL TIMES. WHERE PRESERVATION IS NOT POSSIBLE, THE PROJECT MANAGER SHALL BE NOTIFIED & CONSENT RECEIVED PRIOR TO THEIR REMOVAL. THE CONTRACTOR SHALL BE RESPONSIBLE FOR COMPLIANCE WITH THE SURVEYOR GENERAL'S DIRECTION NO.11 "PRESERVATION OF SURVEY INFRASTRUCTURE" AVAILABLE FROM LAND REGISTRY SERVICES NSW WEBSITE.

PAVER TYPE	SIZE	QUANTITY	COMMENTS
EXISTING PAVERS	400x400x40	388 Sqm	ASSUMED 80% SALVAGE=410
EDGE PAVERS (NEW)	400x400x40	130 Sqm	Code: Pebblecrete PFX61:400D SB
INFILL PAVERS (NEW)	400x400x40	340 Sqm	Code: Pebblecrete PFX61:400D SB

NAME OF PLANT	SPACING	QUANTITY	POT SIZE	COMMENTS
BUXUS JAPONICA (HEDGE)	300mm	428	140mm	REFER SHEET 12
TULBAGHIA VARIEGATED TREES-FRAXINUS	300mm	426	140mm	REFER SHEET 12
PENNSYLVANICA (URBANITE)	-	2	100 LITRE	STREET TREES

CONCRETE

- ALL WORKMANSHIP AND MATERIALS SHALL BE IN ACCORDANCE WITH AS 3600 CURRENT EDITION WITH AMENDMENTS EXCEPT WHERE VARIED BY THE CONTRACT DOCUMENTS.
- CONCRETE QUANTITY

ELEMENT	SLUMP	MAX AGGREGATE SIZE	CEMENT TYPE	CEMENT GRADE
ALL	80mm	20mm	GP	25MPa

- NO ADMIXTURES SHALL BE USED WITHOUT THE APPROVAL OF THE ENGINEER.
- CLEAR CONCRETE COVER TO REINFORCEMENT SHALL BE AS FOLLOWS UNLESS OTHERWISE SHOWN-

ELEMENT	SURFACE OF MEMBER IN INTERIOR ENVIRONMENT	SURFACE OF MEMBER IN ABOVE GROUND EXTERIOR ENVIRONMENT	SURFACE OF MEMBER IN CONTACT WITH GROUND (1)	SURFACE OF MEMBER IN WATER
ALL	35	45	55	75

- NOTE:
- COVER MAY BE REDUCED BY 10mm IF THE SURFACE IS PROTECTED BY A DAMP-PROOF MEMBRANE.
 - SLABS EXPOSED TO CORROSIVE VAPOURS, CORROSIVE GROUND WATER, SEA WATER, OR SPRAY ARE TO HAVE REINFORCEMENT COVER AS NOTED ON THE DRAWINGS.

- SIZES OF CONCRETE ELEMENTS DO NOT INCLUDE THICKNESS OF APPLIED FINISHES.
- CONSTRUCTION JOINTS WHERE NOT SHOWN SHALL BE LOCATED TO THE APPROVAL OF THE ENGINEER.
- BEAM DEPTHS ARE WRITTEN FIRST AND INCLUDE SLAB THICKNESS IF ANY.

NOTE

ALL DIMENSIONS ARE IN METERS UNLESS OTHERWISE SHOWN

NOTE


SURFACE FITTINGS OF UNDERGROUND SERVICES ARE TO FINISH FLUSH WITH THE NEW SURFACES

SURVEY STATION COORDINATES

STATION	EASTING	NORTHING	ELEVATION
STN1	327810.053	6248285.329	17.989
STN2	327843.914	6248275.496	16.933
STN3	327831.675	6248279.987	17.205
STN4	327835.387	6248283.315	17.199

NOTE

WATER, SEWER, TELSTRA & ELECTRICITY SERVICES IN THE VICINITY OF WORKS, CONTRACTOR TO CONTACT SYDNEY WATER, TELSTRA & ENERGY AUSTRALIA PRIOR TO EXCAVATION

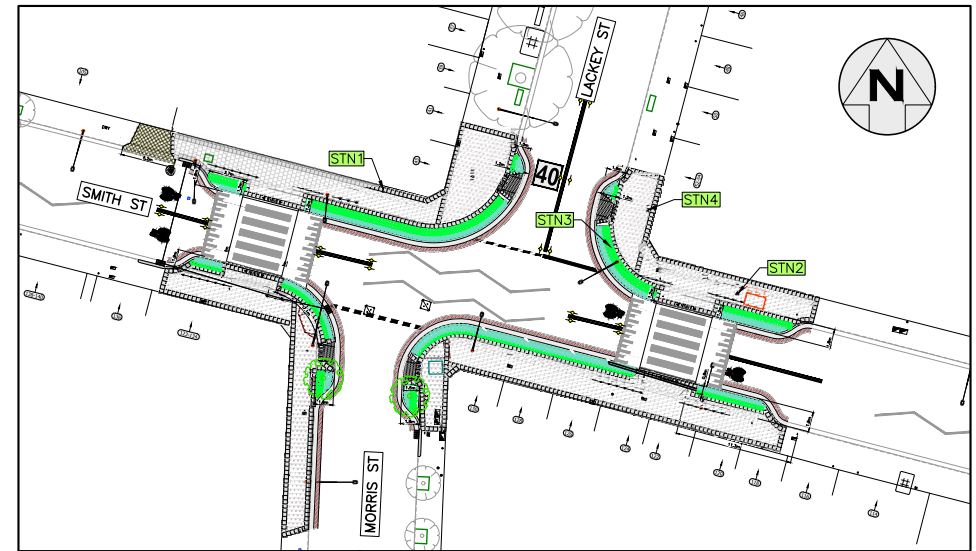

SURVEY STATION PLAN

NOT TO SCALE

FOR CONSTRUCTION

SURVEY LEGEND

SYMBOLS

- STATE SURVEY MARK
- PERMANENT SURVEY MARK
- SURVEY STATION
- DRILL HOLE & BING
- DRILLED HOLE
- SURVEY NAIP
- SKIN
- POSSIBLY SHOWN IN TRUE PROJECTION
- COLUMN
- BOLLARD
- HORIZONTAL
- POWER POLE
- LIGHT POLE
- ELECTRICITY & LIGHT POLE
- PHONE BOOTH
- MAIL BOX
- TELECOMMUNICATION PILLAR
- TELECOMMUNICATION PILLAR
- TUBESIDE BIN
- MANHOLE (STORMWATER/SEWER)
- MANHOLE (STORMWATER/SQUARE)
- WATER STOP VALVE
- WATER METER
- GAS VALVE
- OPTUS PIT / RMS PIT
- PARKING METER
- UNDERGROUND SERVICE COVER
- SEWER LAMP HOLE
- TRAFFIC LIGHT BOX
- TRAFFIC LIGHTS
- TREES / SHRUB

EXISTING SERVICES

- DRAINAGE LINE
- ELECTRICITY
- GAS
- OIL PIPELINE
- SEWER
- TELECOM
- WATER
- OPTIC FIBER
- SUBSOIL
- NBN
- OPTUS
- OVERHEAD ELECT.
- VHD ELECT & TEL UNDERGROUND

CHECKED & APPROVED
19/11/23

APPROVED FOR CONSTRUCTION
19/11/23

SURVEYED BY
ADAM DILLON
01-07-2022

DESIGNED BY
ASHFAQ AHMAD
19-09-2022

DRAWN BY
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19-09-2022



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COORDINATE SYSTEM	SCALES (ORIGINAL A1)	DATE	DESCRIPTION	APPROVAL
MGA2020	N.A.			

SMITH STREET, SUMMER HILL

AT LACKEY STREET/MORRIS STREET INTERSECTION

PROPOSED STREETScape WORKS


NOTES & SCHEDULES

PROJECT NO. 303083

SHEET NO. 2 of 15

PLAN NO. 10218

SHEET REF #

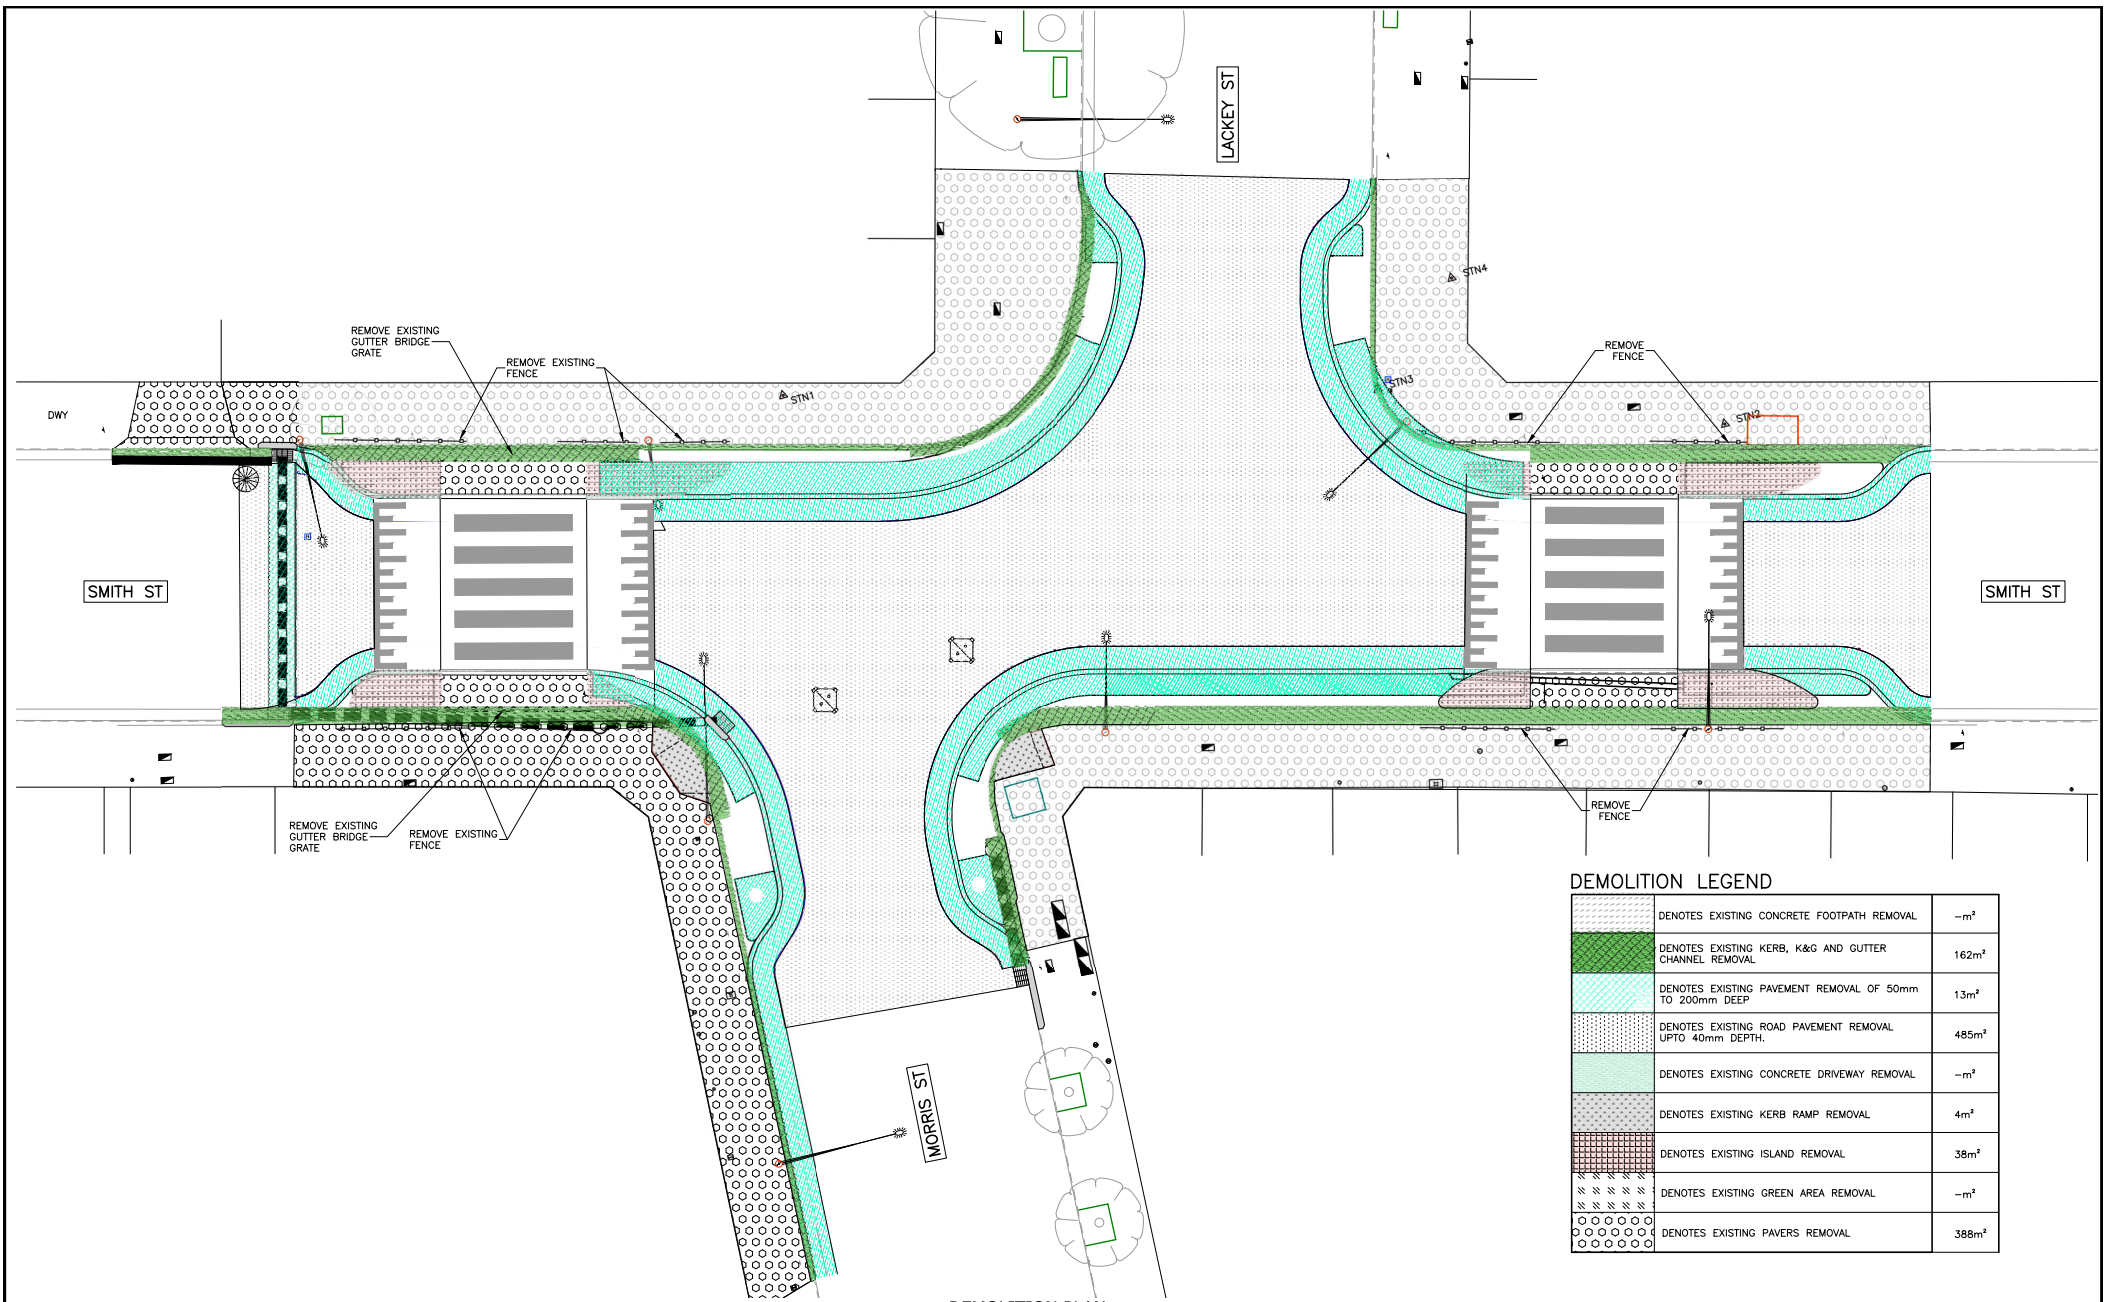

DEMOLITION LEGEND

	DENOTES EXISTING CONCRETE FOOTPATH REMOVAL	-m ²
	DENOTES EXISTING KERB, K&G AND GUTTER CHANNEL REMOVAL	162m ²
	DENOTES EXISTING PAVEMENT REMOVAL OF 50mm TO 200mm DEEP	13m ²
	DENOTES EXISTING ROAD PAVEMENT REMOVAL UP TO 40mm DEPTH	485m ²
	DENOTES EXISTING CONCRETE DRIVEWAY REMOVAL	-m ²
	DENOTES EXISTING KERB RAMP REMOVAL	4m ²
	DENOTES EXISTING ISLAND REMOVAL	38m ²
	DENOTES EXISTING GREEN AREA REMOVAL	-m ²
	DENOTES EXISTING PAVERS REMOVAL	388m ²

1 DEMOLITION PLAN
Scale: 1:100

0 1 2 3 4 5 6 7 8
SCALE 1:100 (A1) SCALE 1:200 (A2)

FOR CONSTRUCTION

CHECKED & APPROVED
Ashfaq Ahmad
19/4/23

APPROVED FOR CONSTRUCTION
Adam Dillon
19/4/23

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SURV. GEN.	
R.M.S.	
A.G.L. / SHELL PIPELINES	
SYDNEY WATER	
TELSTRA / OPTUS	
AUSGRID	
NOTICE OF ENTRY	
KERB & GUTTER	
NOTICES	
DATE	

COORDINATE SYSTEM
MGA2020

SCALES (ORIGINAL A1)
1:100


REV.	DATE	DESCRIPTION	APPROV.

SMITH STREET, SUMMER HILL
AT LACKEY STREET/MORRIS STREET INTERSECTION
PROPOSED STREETSCAPE WORKS
DEMOLITION PLAN

PROJECT NO.	303083	SHEET NO.	3 of 15
PLAN NO.	10218		
SHEET REV #			

KERB / GUTTER / K&G RECONSTRUCTION SCHEDULE	LENGTH (m)
1 TO 2 CONCRETE K&G 150mm HIGH	3.5
2 TO 3 CONCRETE KERB 150mm HIGH (WITH TRANSITION)	2.5
3 TO 4 KEEP EXISTING KERB	5.5
4 TO 5 CONCRETE KERB 150mm HIGH (WITH TRANSITION)	2.5
5 TO 6 CONCRETE K&G 150mm HIGH	27.0

KERB / GUTTER / K&G RECONSTRUCTION SCHEDULE	LENGTH (m)
7 TO 8 CONCRETE K&G 150mm HIGH	15.4
8 TO 9 CONCRETE KERB 150mm HIGH (WITH TRANSITION)	2.5
9 TO 10 KEEP EXISTING KERB	5.5
10 TO 11 CONCRETE KERB 150mm HIGH (WITH TRANSITION)	2.4
11 TO 12 CONCRETE K&G 150mm HIGH	7.6

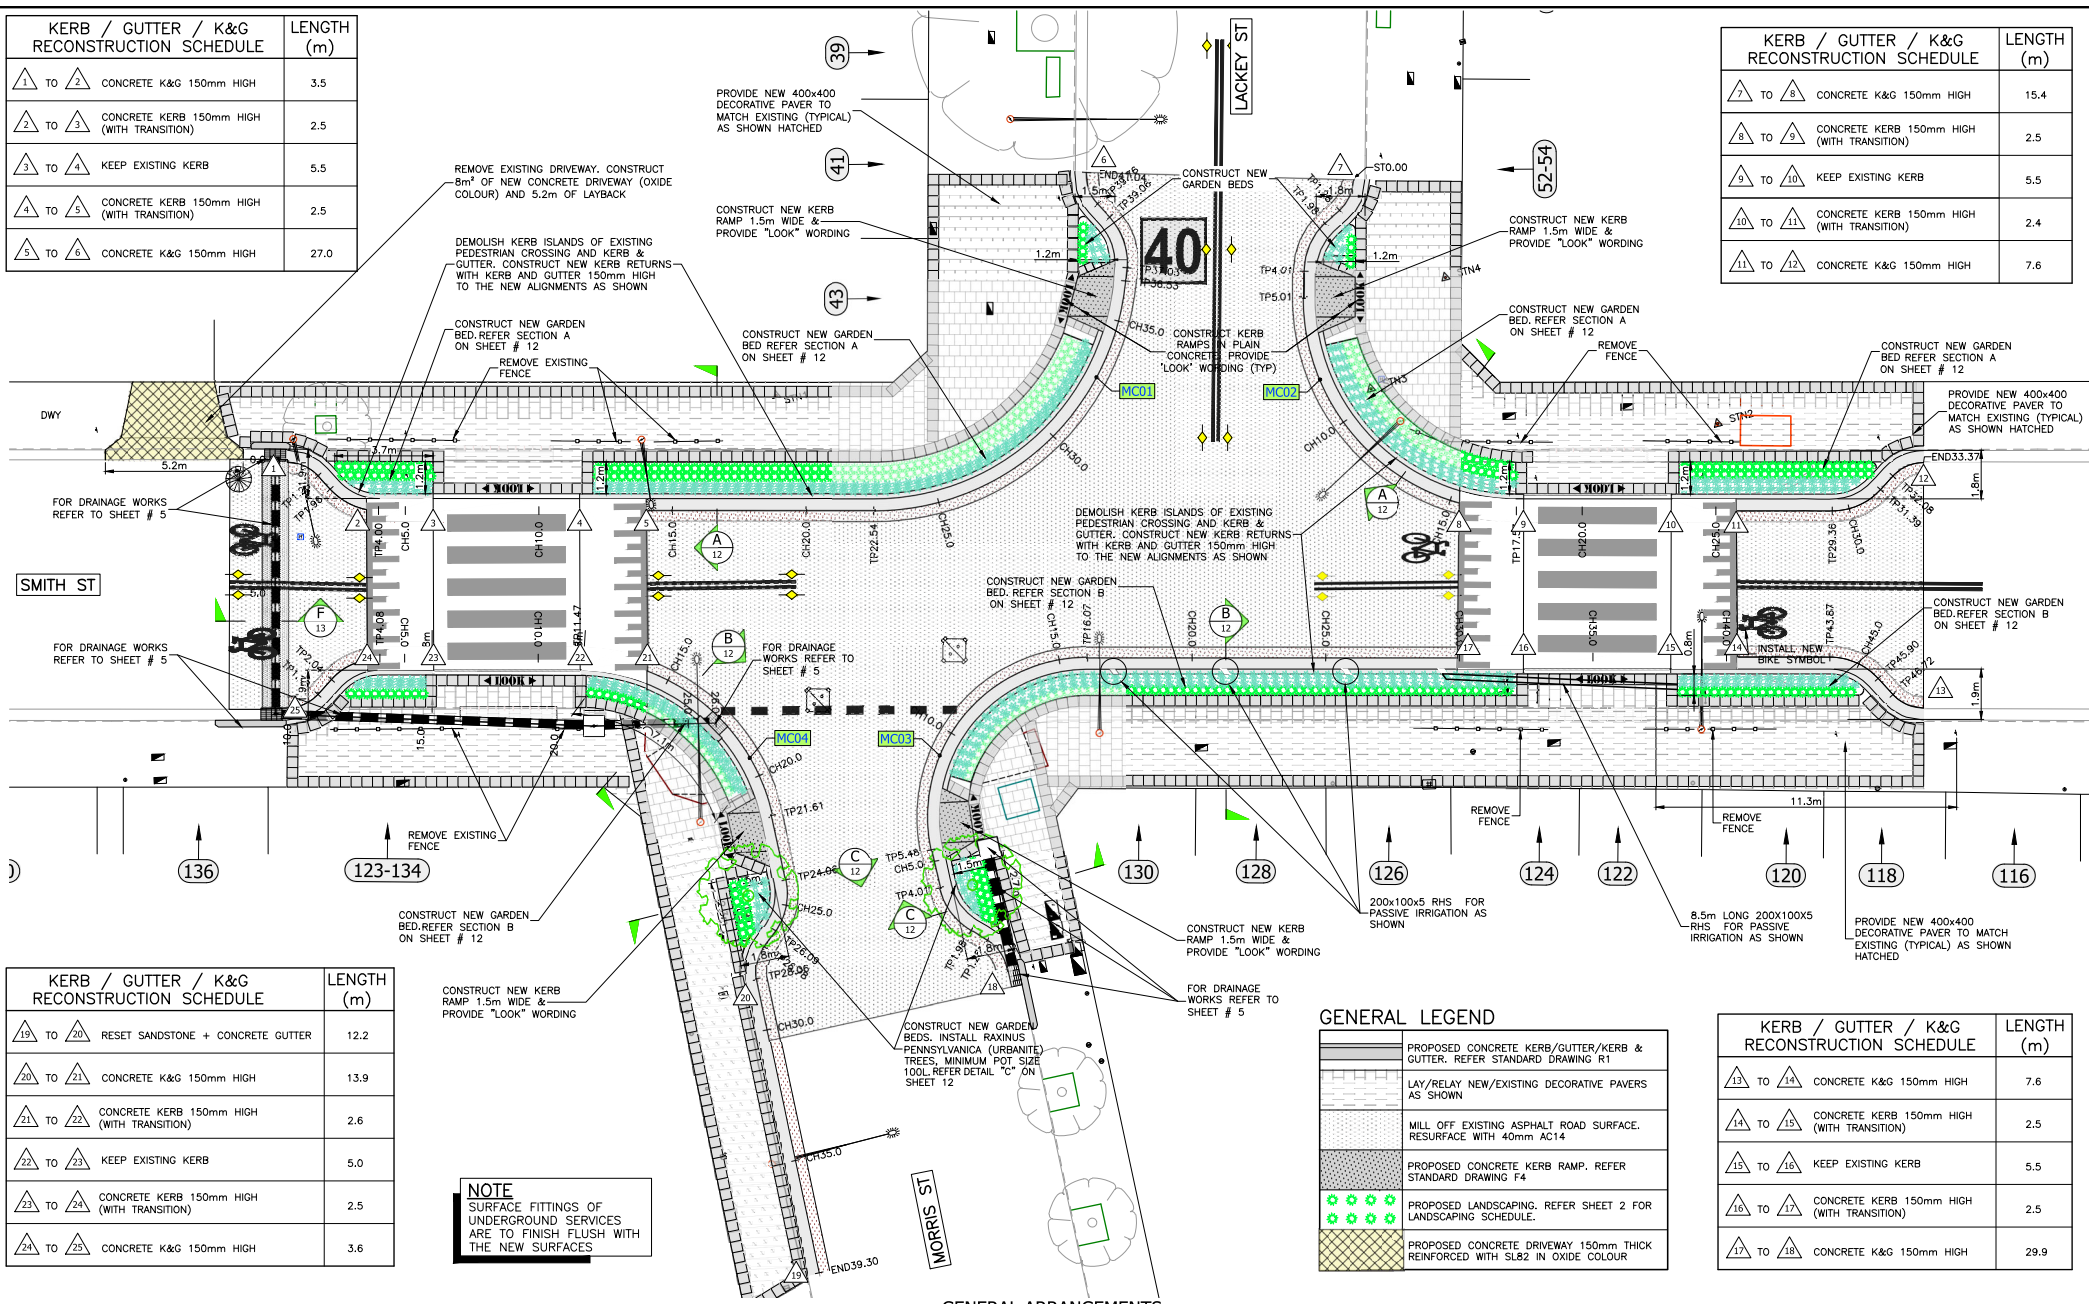

KERB / GUTTER / K&G RECONSTRUCTION SCHEDULE	LENGTH (m)
19 TO 20 RESET SANDSTONE + CONCRETE GUTTER	12.2
20 TO 21 CONCRETE K&G 150mm HIGH	13.9
21 TO 22 CONCRETE KERB 150mm HIGH (WITH TRANSITION)	2.6
22 TO 23 KEEP EXISTING KERB	5.0
23 TO 24 CONCRETE KERB 150mm HIGH (WITH TRANSITION)	2.5
24 TO 25 CONCRETE K&G 150mm HIGH	3.6

KERB / GUTTER / K&G RECONSTRUCTION SCHEDULE	LENGTH (m)
13 TO 14 CONCRETE K&G 150mm HIGH	7.6
14 TO 15 CONCRETE KERB 150mm HIGH (WITH TRANSITION)	2.5
15 TO 16 KEEP EXISTING KERB	5.5
16 TO 17 CONCRETE KERB 150mm HIGH (WITH TRANSITION)	2.5
17 TO 18 CONCRETE K&G 150mm HIGH	29.9

GENERAL LEGEND

[Pattern]	PROPOSED CONCRETE KERB/GUTTER/K&G & GUTTER. REFER STANDARD DRAWING R1
[Pattern]	LAY/RELAY NEW/EXISTING DECORATIVE PAVERS AS SHOWN
[Pattern]	MILL OFF EXISTING ASPHALT ROAD SURFACE. RESURFACE WITH 40mm AC14
[Pattern]	PROPOSED CONCRETE KERB RAMP. REFER STANDARD DRAWING F4
[Pattern]	PROPOSED LANDSCAPING. REFER SHEET 2 FOR LANDSCAPING SCHEDULE.
[Pattern]	PROPOSED CONCRETE DRIVEWAY 150mm THICK REINFORCED WITH SL82 IN OXIDE COLOUR

NOTE
SURFACE FITTINGS OF UNDERGROUND SERVICES ARE TO FINISH FLUSH WITH THE NEW SURFACES

2 GENERAL ARRANGEMENTS
Scale: 1:100

FOR CONSTRUCTION

CHECKED & APPROVED
Asyfaq Ahmad
19/09/2022

DESIGNED BY
ASHFAQ AHMAD
19-09-2022

APPROVED FOR CONSTRUCTION
Asyfaq Ahmad
19/09/2022

DRAWN BY
ASHFAQ AHMAD
19-09-2022




SURV. GEN.	COORDINATE SYSTEM
R.M.S.	MGA2020
A.G.L. / SHELL PIPELINES	SCALES (ORIGINAL A1)
SYDNEY WATER	1:100
TELSTRA / OPTUS	
AUSGRID	
NOTICE OF ENTRY	
KERB & GUTTER	
NOTICES	

REV.	DATE	DESCRIPTION	APPROV.


SMITH STREET, SUMMER HILL
AT LACKEY STREET/MORRIS STREET INTERSECTION
PROPOSED STREETScape WORKS
GENERAL ARRANGEMENTS - CIVIL WORKS

PROJECT NO.	SHEET NO.
303083	4 of 15
PLAN NO.	10218
SHEET REV #	

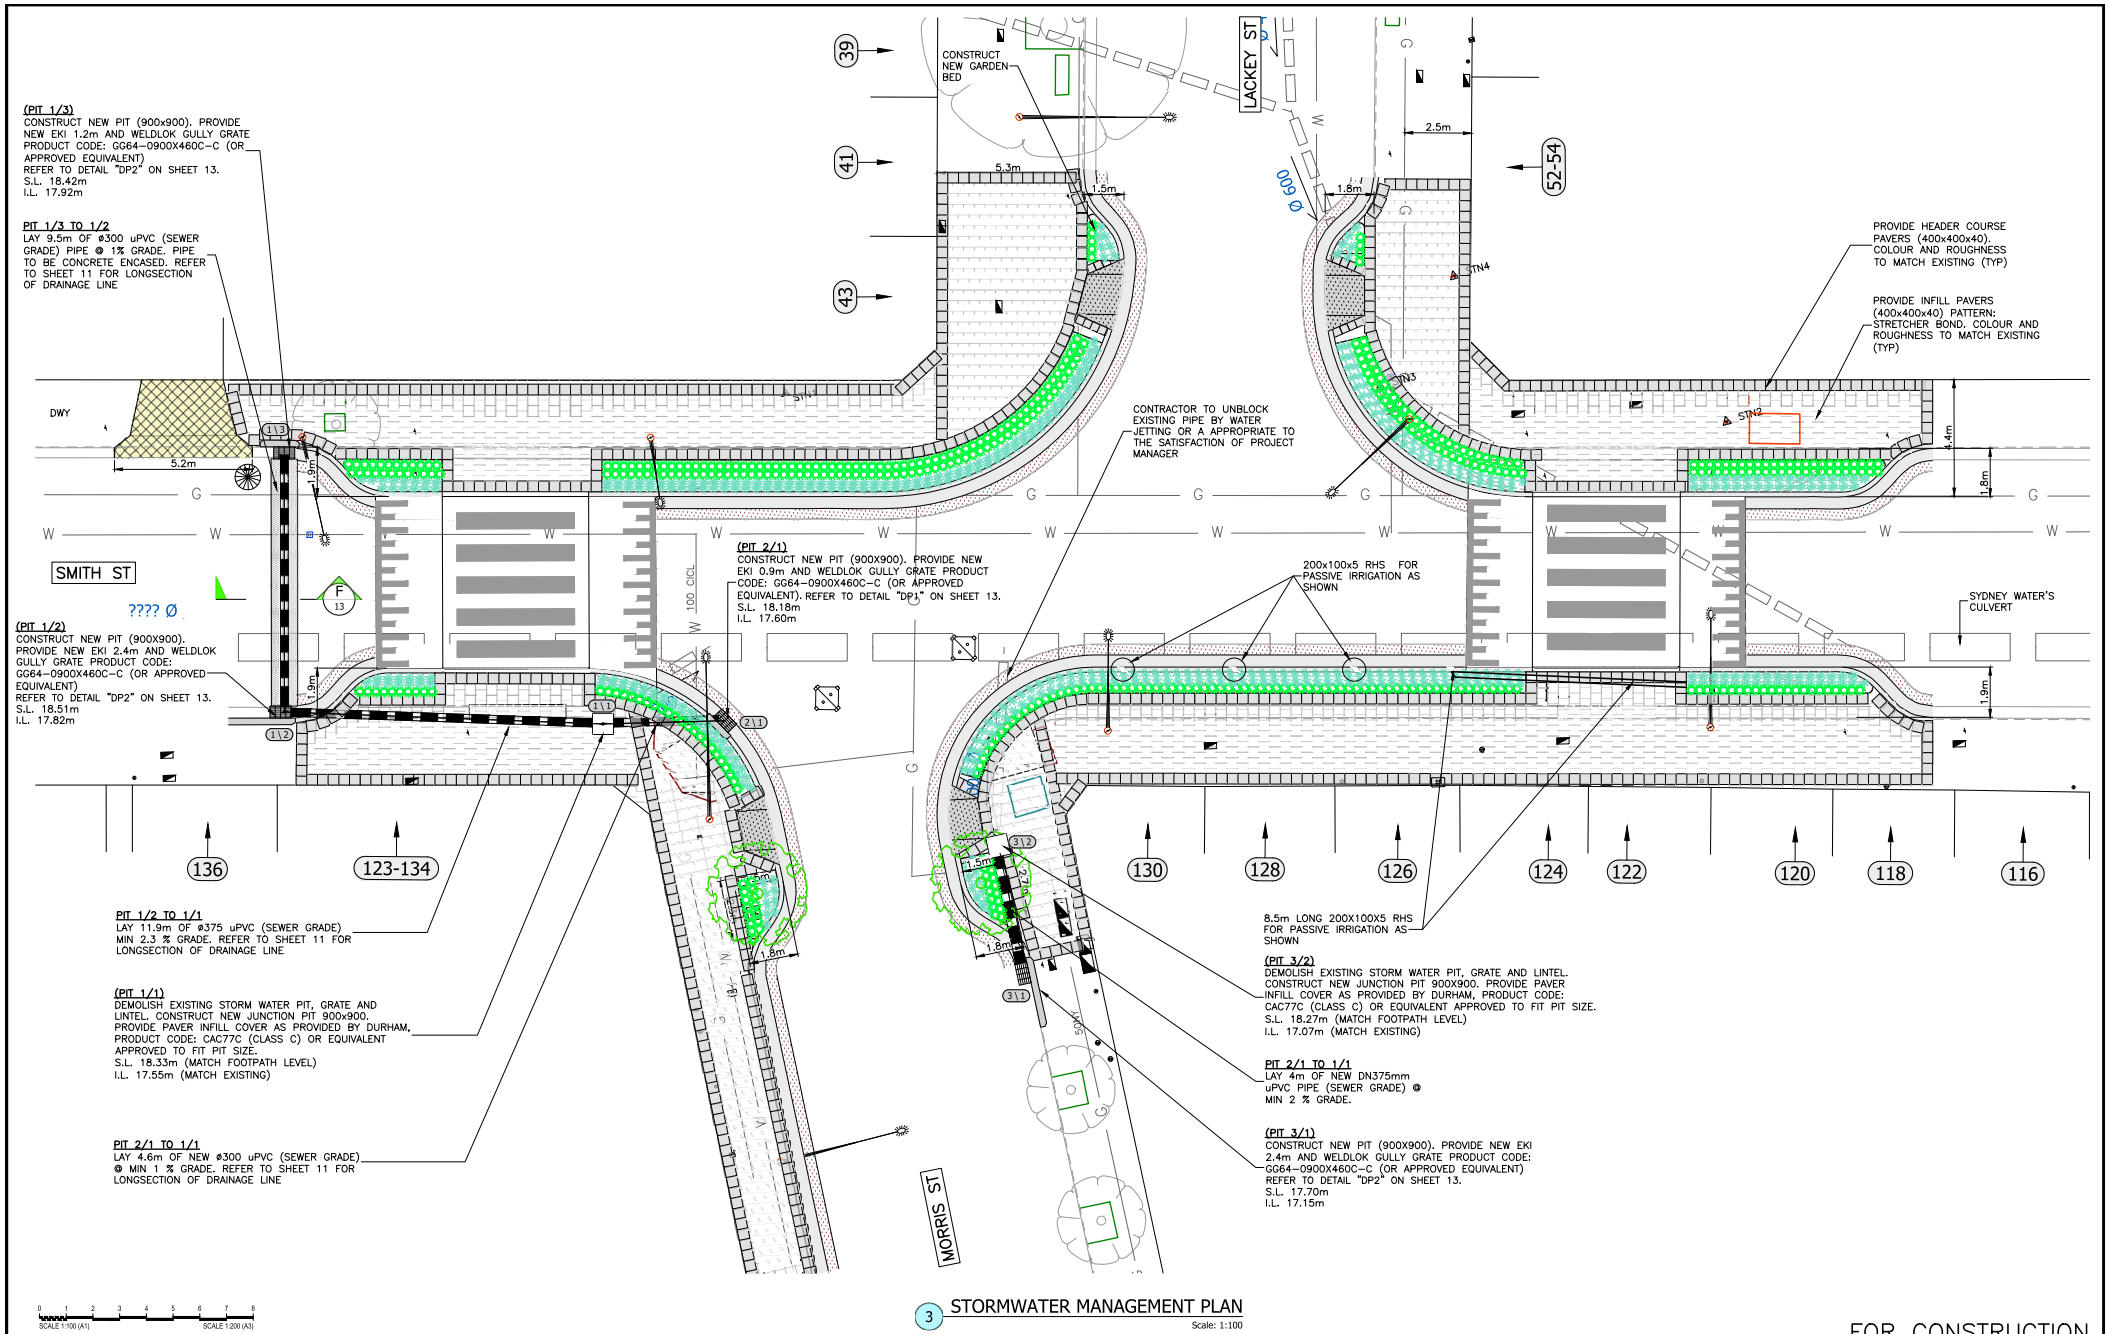

3 STORMWATER MANAGEMENT PLAN

Scale: 1:100

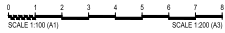

FOR CONSTRUCTION

CHECKED & APPROVED
Adam Dillon
 19/04/23

DESIGNED BY
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 19-09-2022

APPROVED FOR CONSTRUCTION
Ashfaq Ahmad
 19/04/23

DRAWN BY
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 19-09-2022

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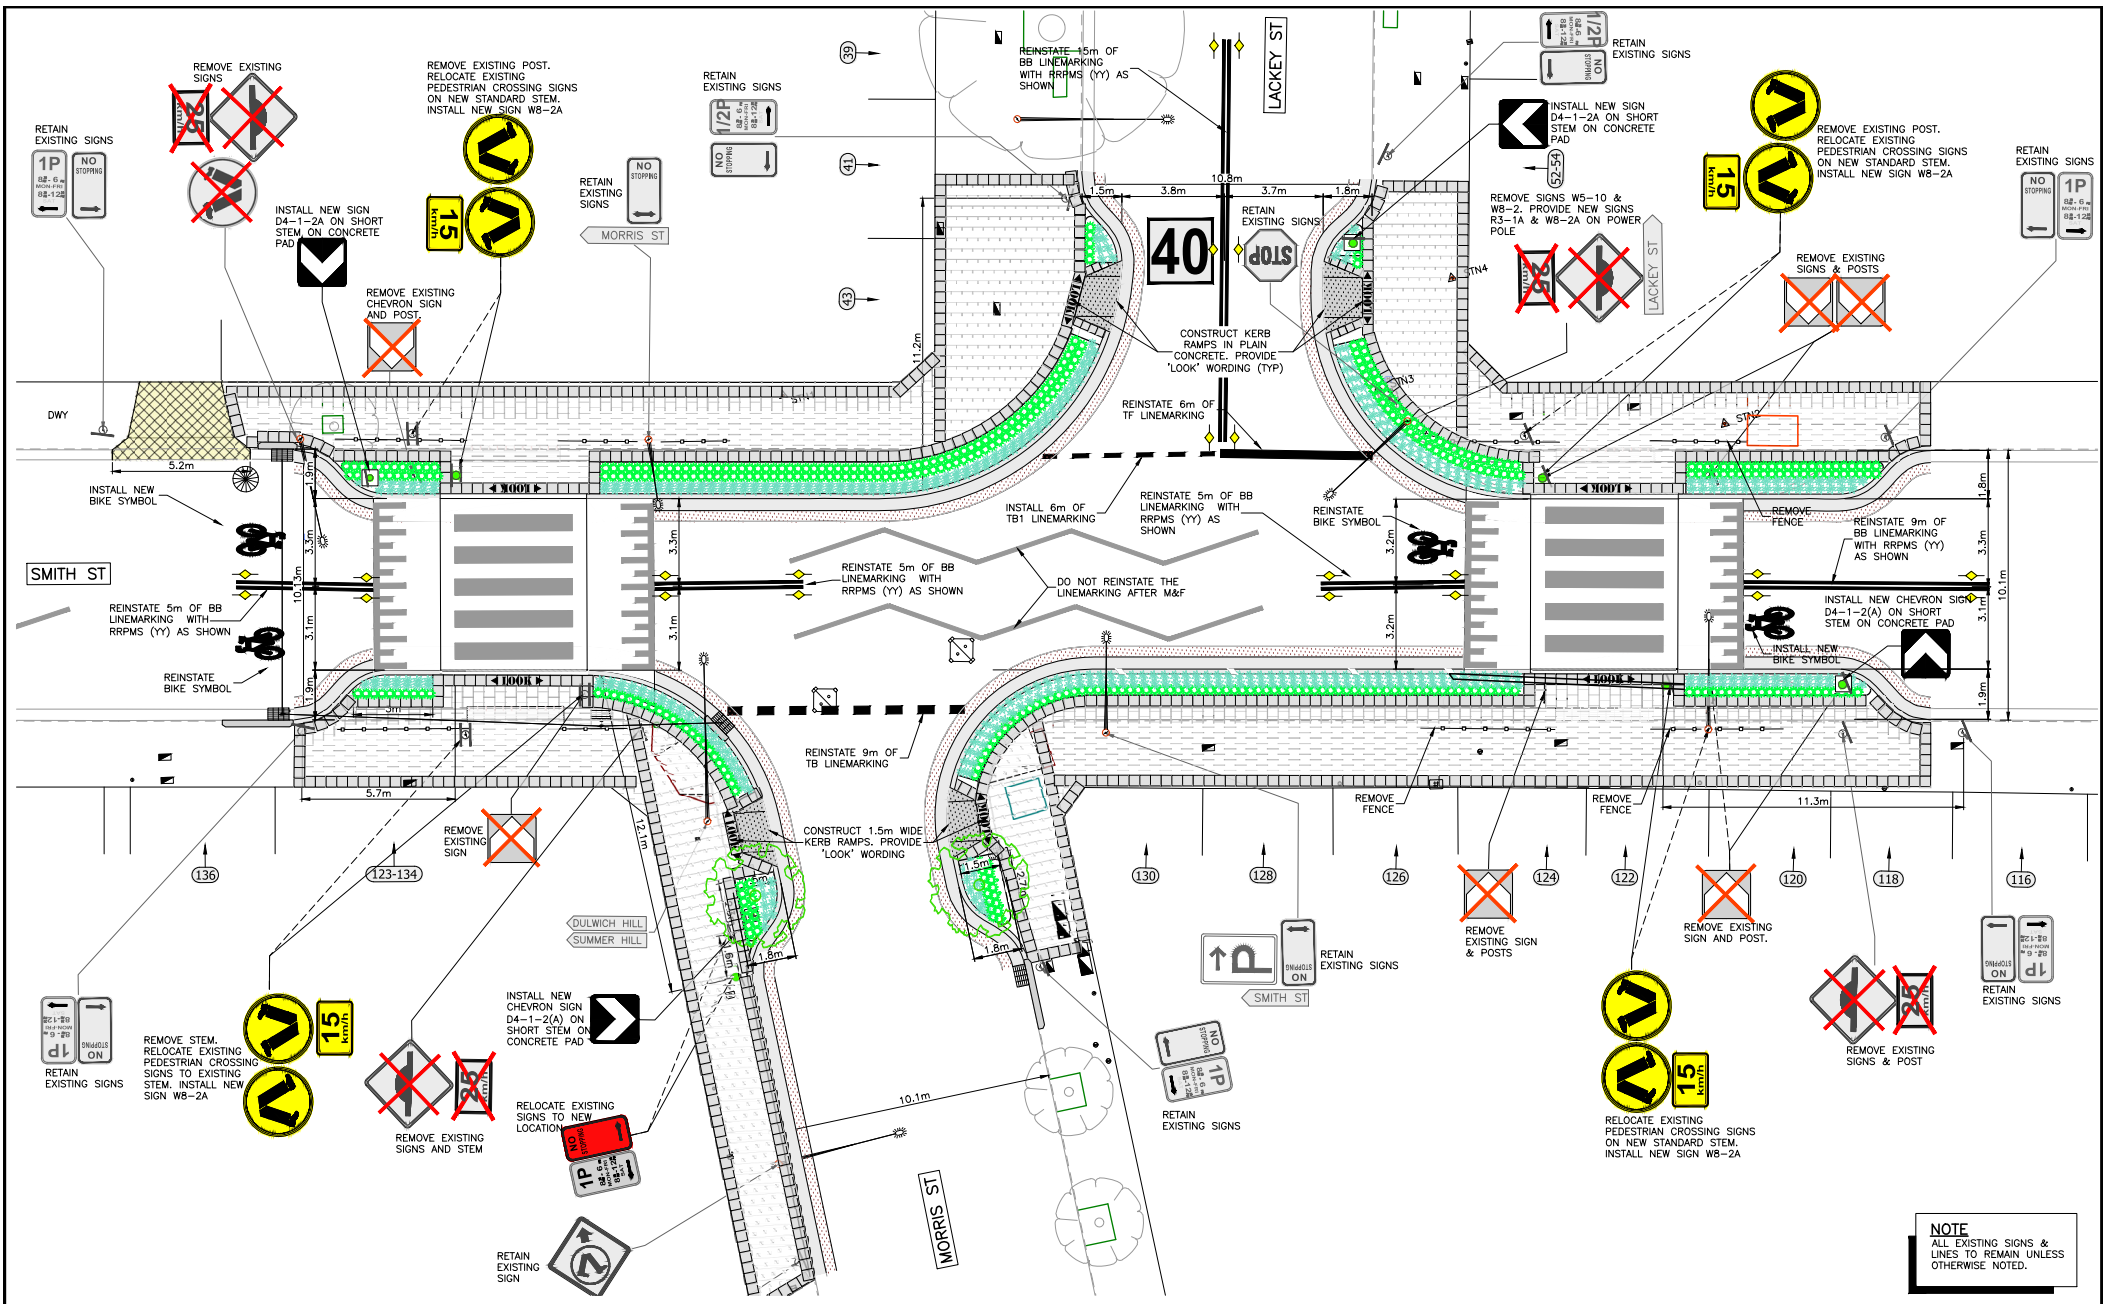
SURV. GEN.	
R.M.S.	
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SYDNEY WATER	
TELSTRA / OPTUS	
AUSGRID	
NOTICE OF ENTRY	
KERB & GUTTER	
NOTICES	

COORDINATE SYSTEM	MG2020
SCALES (ORIGINAL A1)	
1:100	


REV.	DATE	DESCRIPTION	APPROV.

SMITH STREET, SUMMER HILL
 AT LACKY STREET/MORRIS STREET INTERSECTION
 PROPOSED STREETSCAPE WORKS
 GENERAL ARRANGEMENT - STORMWATER

PROJECT NO.	303083	SHEET NO.	5 of 15
PLAN NO.	10218		
SHEET REV #			



NOTE
ALL EXISTING SIGNS & LINES TO REMAIN UNLESS OTHERWISE NOTED.

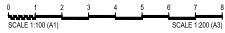

CHECKED & APPROVED
Asghaq Ahmad
19/11/23

DESIGNED BY
ASHFAQ AHMAD
19-09-2022

APPROVED FOR CONSTRUCTION
Asghaq Ahmad
19/11/23

DRAWN BY
ASHFAQ AHMAD
19-09-2022



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council@innerwest.nsw.gov.au
Web: https://www.innerwest.nsw.gov.au



SURV. GEN.
R.M.S.
A.G.L. / SHELL PIPELINES
SYDNEY WATER
TELSTRA / OPTUS
AUSGRID
NOTICE OF ENTRY
KERB & GUTTER
NOTICES

COORDINATE SYSTEM
MGA2020
SCALES (ORIGINAL A1)
1:100

REV.	DATE	DESCRIPTION	APPROV.



SMITH STREET, SUMMER HILL
AT LACKEY STREET/MORRIS STREET INTERSECTION
PROPOSED STREETSCAPE WORKS
SIGNS & LINEMARKING PLAN

FOR CONSTRUCTION

PROJECT NO. 303083 SHEET NO. 6 of 15

PLAN NO. 10218

SHEET REV #

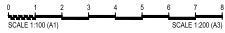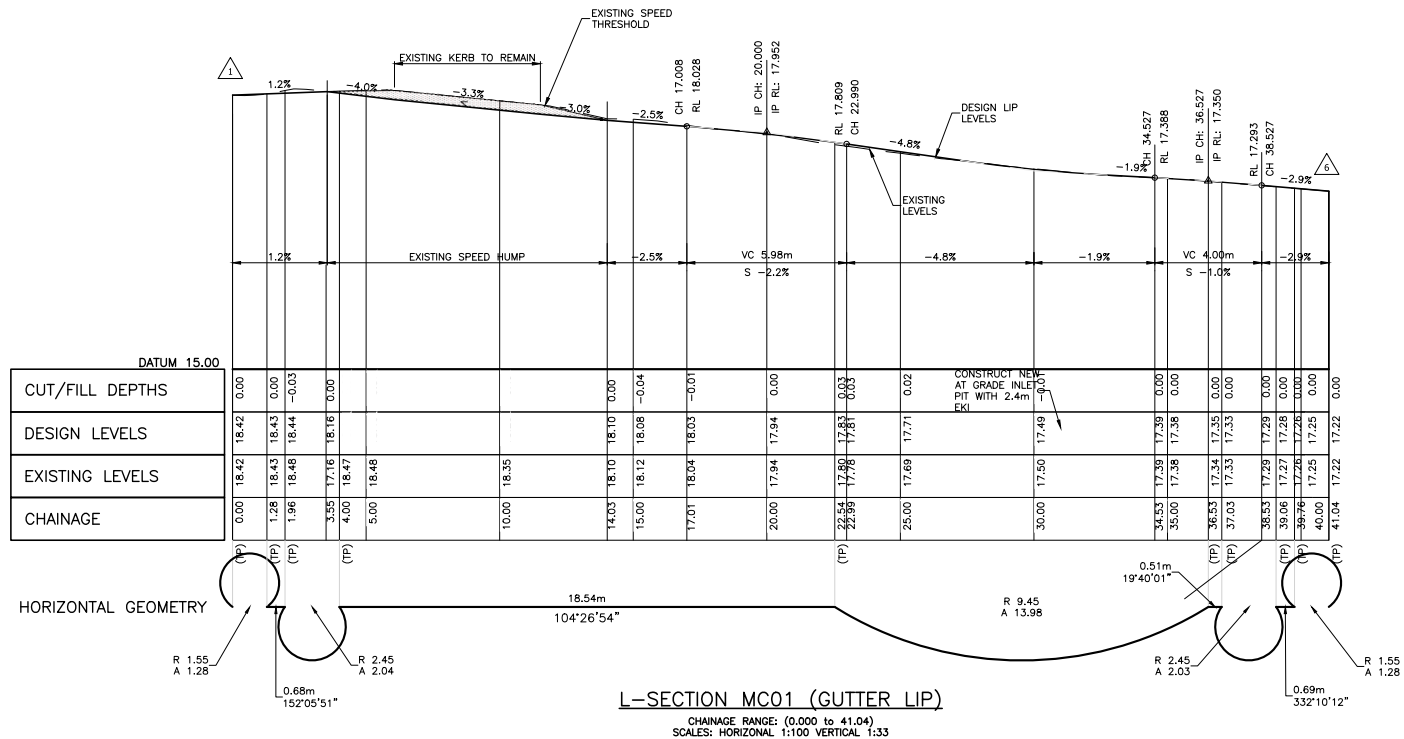

CHECKED & APPROVED
Asif Ahmad
 19/4/23

DESIGNED BY
 ASHFAQ AHMAD
 19-09-2022

APPROVED FOR CONSTRUCTION
John
 19/4/23

DRAWN BY
 ASHFAQ AHMAD
 19-09-2022




SURV. GEN.	COORDINATE SYSTEM	REV.	DATE	DESCRIPTION	APPROV.
R.M.S.	MGA2020				
A.G.L. / SHELL PIPELINES	SCALES (ORIGINAL A1)				
SYDNEY WATER	(H) 1:100				
TELSTRA / OPTUS	(V) 1:33				
AUSGRID					
NOTICE OF ENTRY					
KERB & GUTTER					
NOTICES					


SMITH STREET, SUMMER HILL
 AT LACKEY STREET/MORRIS STREET INTERSECTION
 PROPOSED STREETScape WORKS
 LONGSECTION MC01 (GUTTER LIP)

PROJECT NO.	SHEET NO.
303083	7 of 15
PLAN NO.	
10218	
SHEET REV #	

FOR CONSTRUCTION

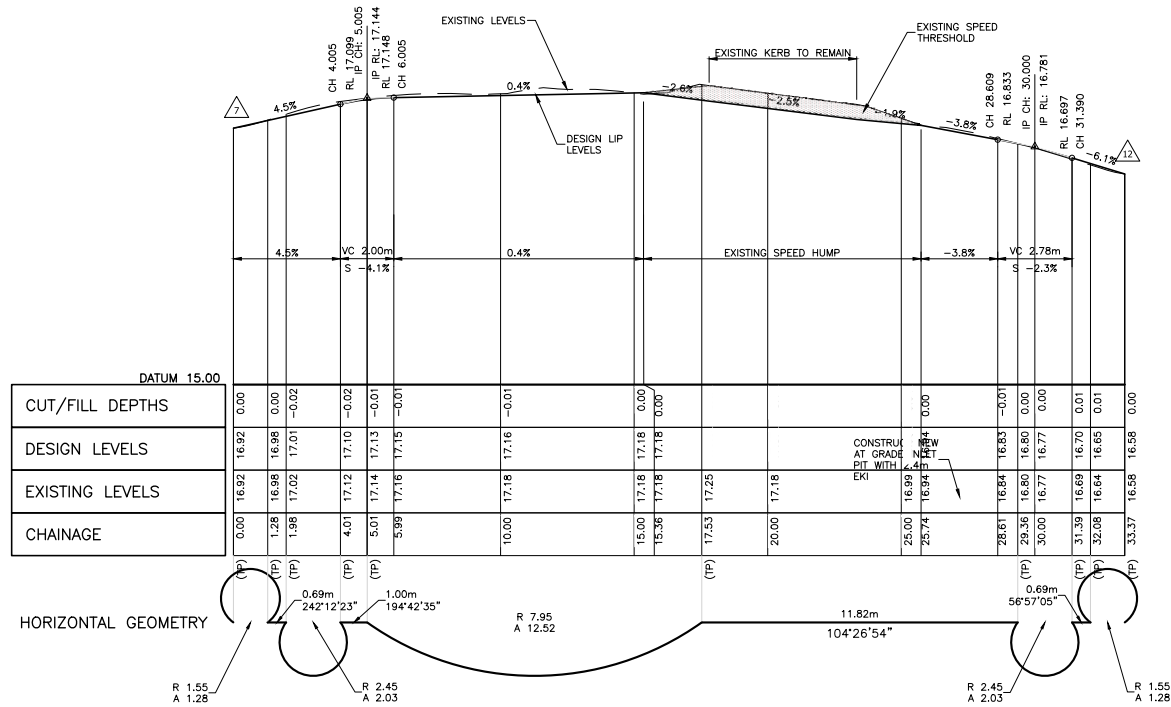


L-SECTION MC02 (GUTTER LIP)
CHAINAGE RANGE: (0.000 to 33.37)
SCALES: HORIZONTAL 1:100 VERTICAL 1:20

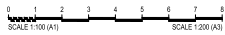


FOR CONSTRUCTION

CHECKED & APPROVED <i>Asghar Ahmad</i> 19/4/22	SURVEYED BY ADAM DILLON 01-07-2022		2-14 FISHER STREET, PETERSHAM NSW 2049 Ph: (02) 9392 5006 Post: PO Box 14 PETERSHAM e: council@innerwest.nsw.gov.au Web: https://www.innerwest.nsw.gov.au	SURV. GEN. R.M.S. A.G.L. / SHELL PIPELINES SYDNEY WATER TELSTRA / OPTUS AUSGRID NOTICE OF ENTRY KERB & GUTTER NOTICES	COORDINATE SYSTEM MGA2020 SCALES (ORIGINAL A1) (H)1:100 (V)1:33	PROJECT NO. 303083	SHEET NO. 8 of 15
				APPROVED FOR CONSTRUCTION <i>Asghar Ahmad</i> 19/4/22	DESIGNED BY ASHFAQ AHMAD 19-09-2022	DRAWN BY ASHFAQ AHMAD 19-09-2022	SMITH STREET, SUMMER HILL AT LACKEY STREET/MORRIS STREET INTERSECTION PROPOSED STREETScape WORKS LONGSECTION MC02 (GUTTER LIP)

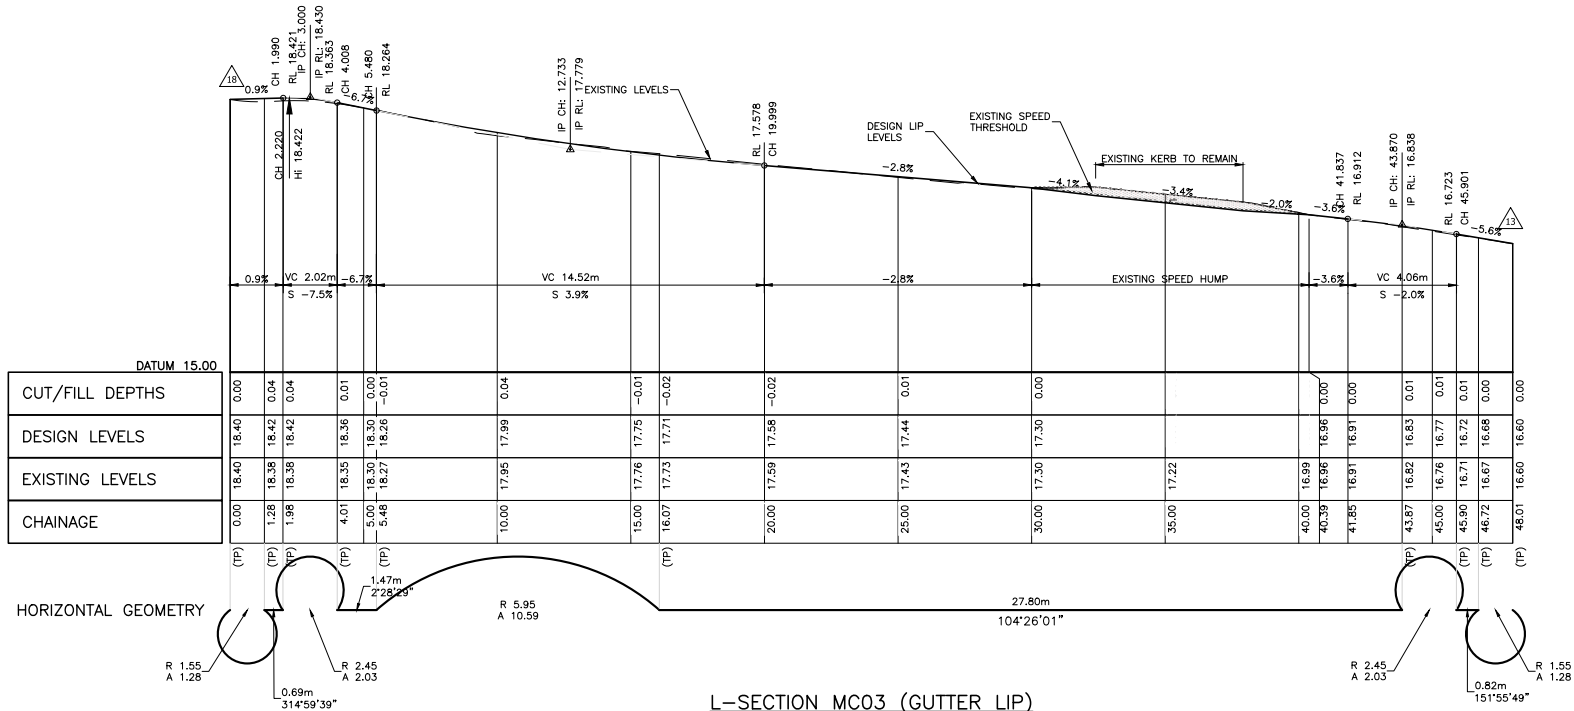

L-SECTION MC03 (GUTTER LIP)
 CHAINAGE RANGE: (0.000 to 48.01)
 SCALES: HORIZONTAL 1:100 VERTICAL 1:33

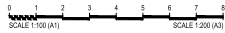

CHECKED & APPROVED
Asghar Ahmad
 19/11/23

DESIGNED BY
 ASHFAQ AHMAD
 19-09-2022

APPROVED FOR CONSTRUCTION
John
 19/11/23

DRAWN BY
 ASHFAQ AHMAD
 19-09-2022




SURV. GEN.	COORDINATE SYSTEM	REV.	DATE	DESCRIPTION	APPROV.
R.M.S.	MGA2020				
A.G.L. / SHELL PIPELINES					
SYDNEY WATER	SCALES (ORIGINAL A1)				
TELSTRA / OPTUS	(H)1:100				
AUSGRID	(V)1:33				
NOTICE OF ENTRY					
KERB & GUTTER					
NOTICES					

SMITH STREET, SUMMER HILL
 AT LACKEY STREET/MORRIS STREET INTERSECTION
 PROPOSED STREETScape WORKS
 LONGSECTION MC03 (GUTTER LIP)


PROJECT NO.	SHEET NO.
303083	9 of 15
PLAN NO.	
10218	
SHEET REV #	

FOR CONSTRUCTION

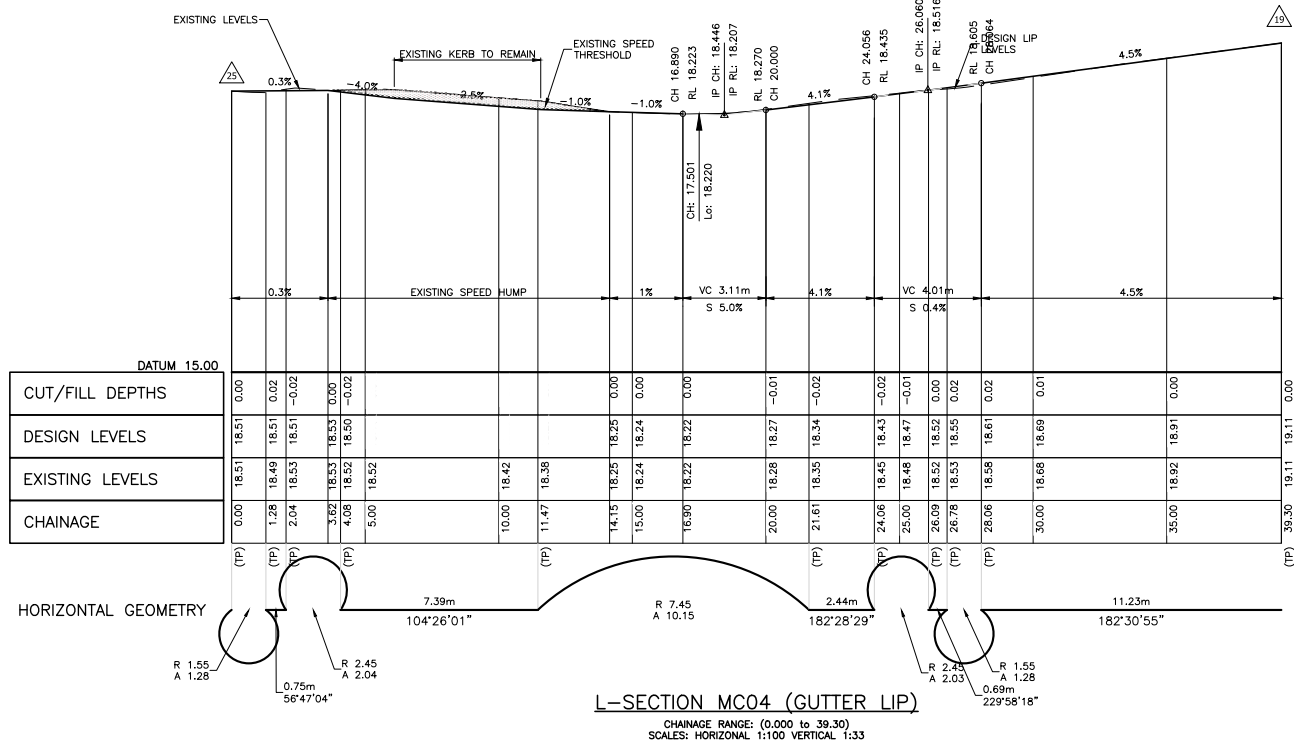


L-SECTION MC04 (GUTTER LIP)

CHAINAGE RANGE: (0.000 to 39.30)
 SCALES: HORIZONTAL 1:100 VERTICAL 1:33

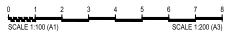

FOR CONSTRUCTION


CHECKED & APPROVED <i>Asif Ahmad</i> 19/11/23	SURVEYED BY ADAM DILLON 01-07-2022		2-14 FISHER STREET, PETERSHAM NSW 2049 Ph: (02) 9392 5506 Post: PO Box 14 PETERSHAM council@innerwest.nsw.gov.au Web: https://www.innerwest.nsw.gov.au	SURV. GEN. R.M.S. A.G.L. / SHELL PIPELINES SYDNEY WATER TELSTRA / OPTUS AUSGRID NOTICE OF ENTRY KERB & GUTTER NOTICES	COORDINATE SYSTEM MGA2020 SCALES (ORIGINAL A1) (H)1:100 (V)1:33	REV. DATE DESCRIPTION APPROV.	PROJECT NO. 303083	SHEET NO. 10 of 15
							DESIGNED BY ASHFAQ AHMAD 19-09-2022	APPROVED FOR CONSTRUCTION <i>Asif Ahmad</i> 19/11/23

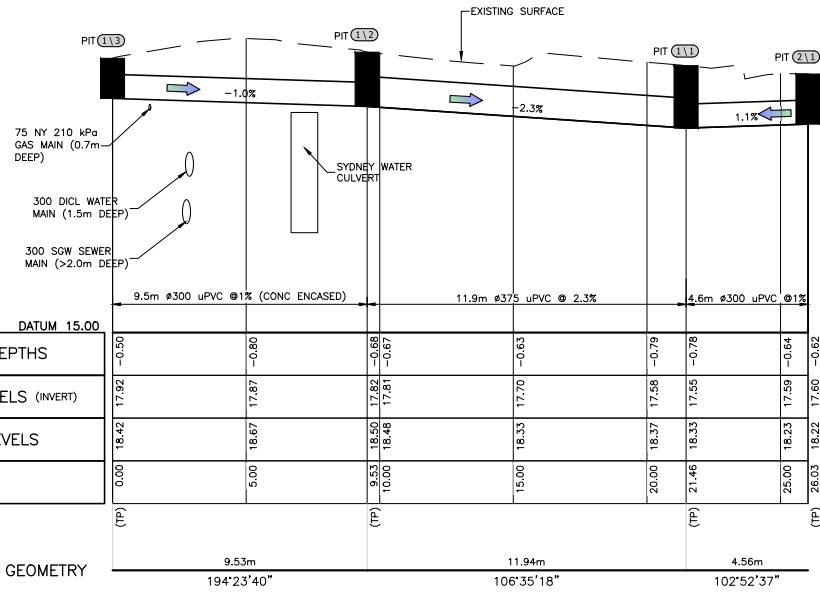

HORIZONTAL GEOMETRY


L-SECTION MC05-STORMWATER LINE (1&2)

CHAINAGE RANGE: (0.00 to 26.03)
 SCALES: HORIZONTAL 1:100 VERTICAL 1:33

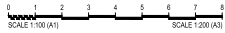


FOR CONSTRUCTION


CHECKED & APPROVED <i>Asif Ahmad</i> 19/4/23	SURVEYED BY ADAM DILLON 01-07-2022		2-14 FISHER STREET, PETERSHAM NSW 2049 Ph: (02) 9392 5506 Post: PO Box 14 PETERSHAM e: council@innerwest.nsw.gov.au Web: https://www.innerwest.nsw.gov.au	SURV. GEN. R.M.S. A.G.L. / SHELL PIPELINES SYDNEY WATER TELSTRA / OPTUS AUSGRID NOTICE OF ENTRY KERB & GUTTER NOTICES	COORDINATE SYSTEM MGA2020 SCALES (ORIGINAL A1) (H)1:100 V(1:33)	REV. DATE DESCRIPTION APPROV.	SMITH STREET, SUMMER HILL AT LACKEY STREET/MORRIS STREET INTERSECTION PROPOSED STREETSCAPE WORKS LONGSECTION MC05 (STORMWATER LINE 1&2)	PROJECT NO. 303083	SHEET NO. 11 of 15
				DESIGNED BY ASHFAQ AHMAD 19-09-2022	DRAWN BY ASHFAQ AHMAD 19-09-2022	PLAN NO. 10218	SHEET REV #		

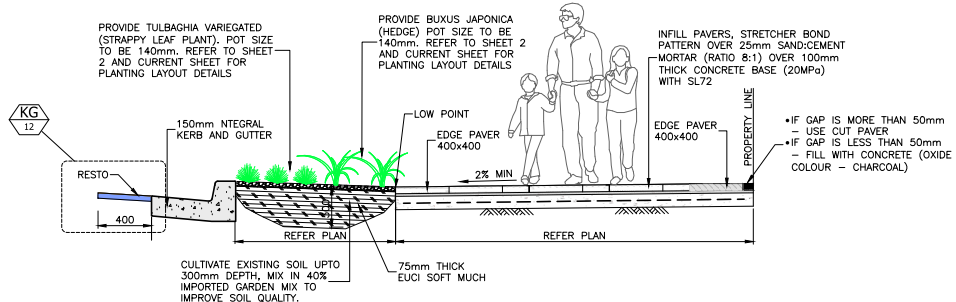






SECTION A
Scale: 1:20

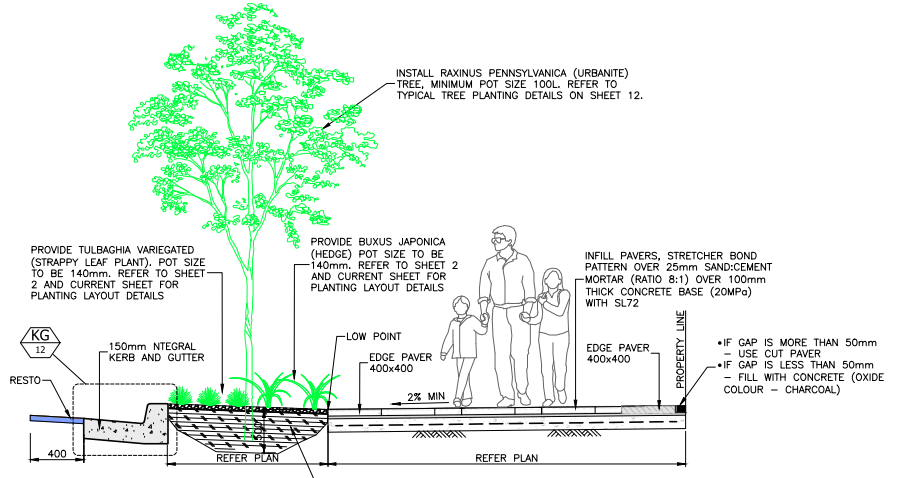

SECTION C
Scale: 1:20

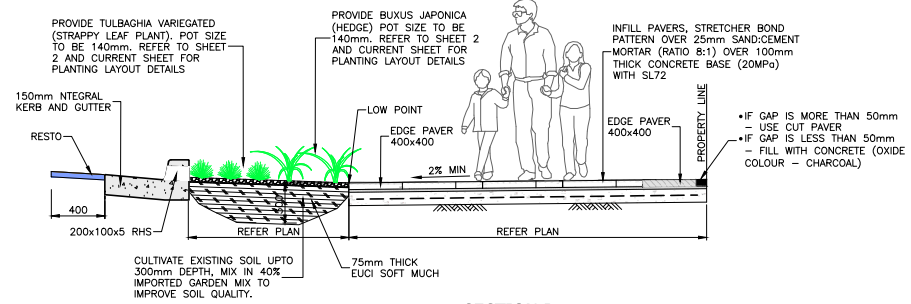

SECTION B
Scale: 1:20

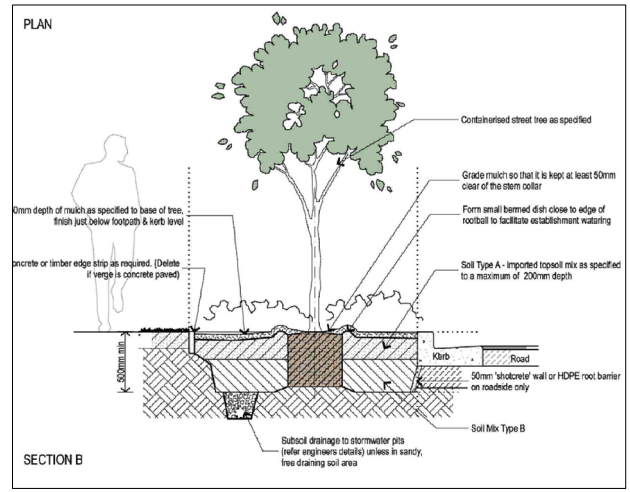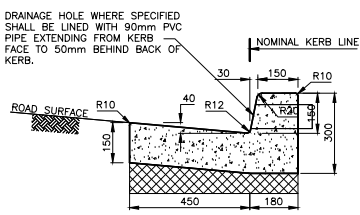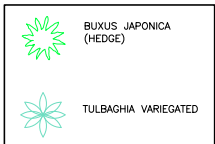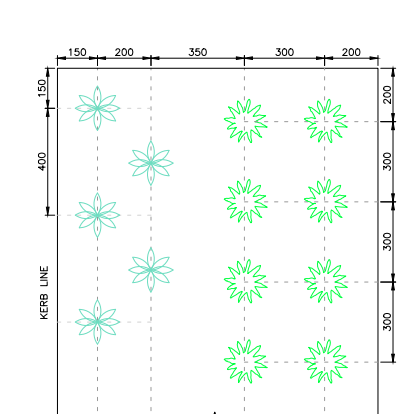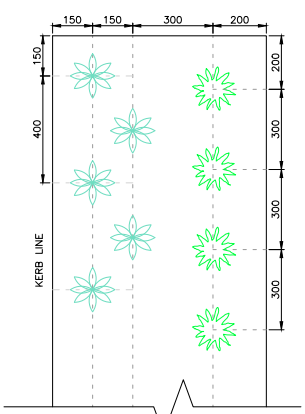

CHECKED & APPROVED
Ashfaq Ahmad
19/1/23

APPROVED FOR CONSTRUCTION
Ashfaq Ahmad
19/09/2022


INNER WEST

2-14 FISHER STREET, PETERSHAM NSW 2049
Ph: 02) 9392 5000
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Web: council@innerwest.nsw.gov.au
https://www.innerwest.nsw.gov.au


SURV. GEN.	COORDINATE SYSTEM		
R.M.S.	MG2020		
A.G.L. / SHELL PIPELINES	SCALES (ORIGINAL A1)		
SYDNEY WATER	AS SHOWN		
TELSTRA / OPTUS			
AUSGRID			
NOTICE OF ENTRY			
KERB & GUTTER			
NOTICES	DATE	REV.	DATE DESCRIPTION APPROV.

SMITH STREET, SUMMER HILL		PROJECT NO.	SHEET NO.
AT LACKEY STREET/MORRIS STREET INTERSECTION		303083	12 of 15
PROPOSED STREETScape WORKS		PLAN NO.	10218
DETAILS (1 of 2)		SHEET REV #	


FOR CONSTRUCTION

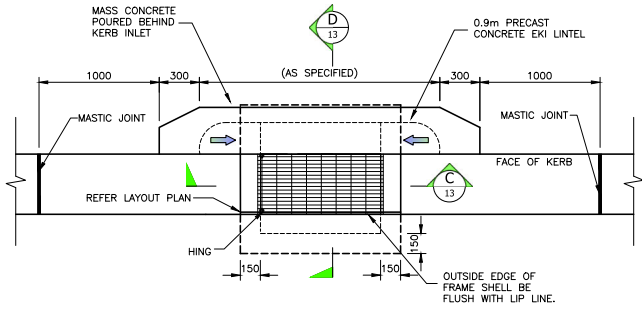


DRAINAGE PIT PLAN (SAG TYP) DP1
Scale: 1:20

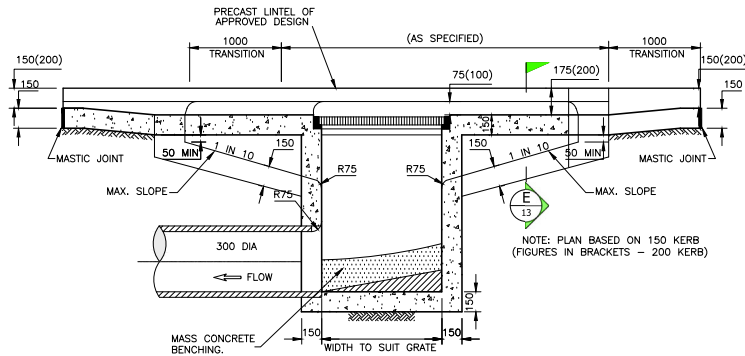


DRAINAGE PIT SECTION C-C C
Scale: 1:20

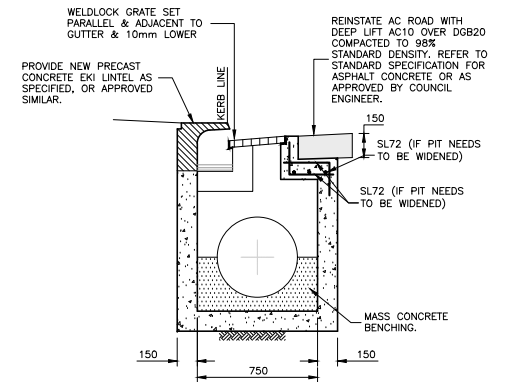


DRAINAGE PIT SECTION D-D D
Scale: 1:20

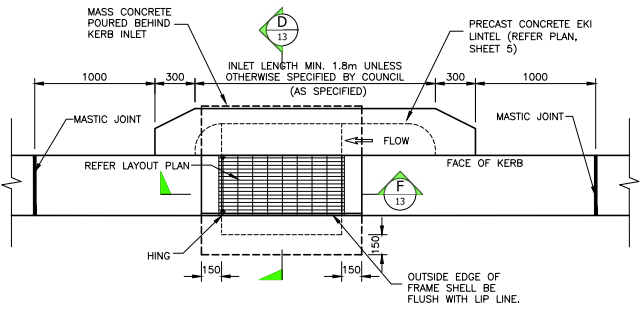


DRAINAGE PIT PLAN (ON GRADE TYP) DP2
Scale: 1:20

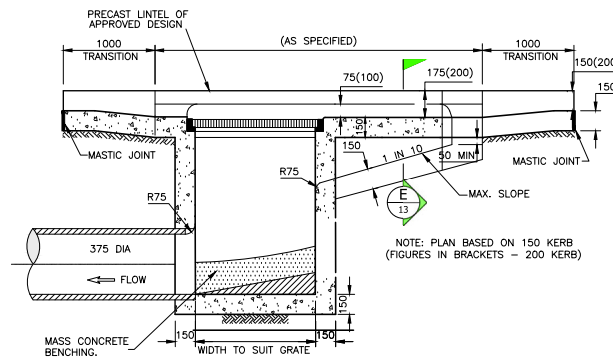

DRAINAGE PIT SECTION F-F F
Scale: 1:20

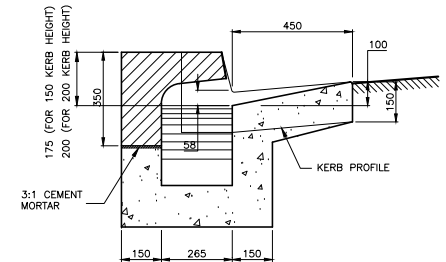


DRAINAGE PIT SECTION E-E E
Scale: 1:10

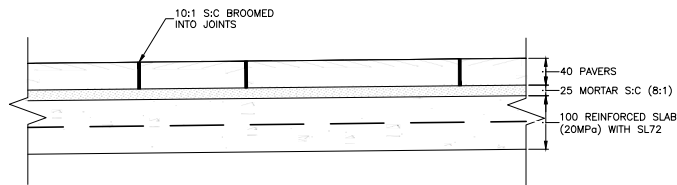


TYPICAL SECTION ON-PAVED FOOTPATH PP
Scale: 1:5



SANDSTONE KERB RESETTING DETAIL SK
Scale: 1:10

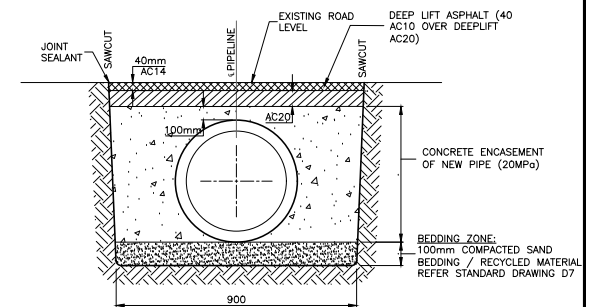

SECTION F-F (CONCRETE ENCASING) F
Scale: 1:10

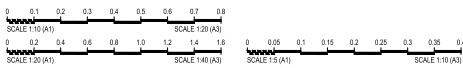

CHECKED & APPROVED
Ashfaq Ahmad
19/1/23
APPROVED FOR CONSTRUCTION
Ashfaq Ahmad
19/09/2022

INNER WEST
2-14 FISHER STREET, PETERSHAM NSW 2049
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SURV. GEN.	
R.M.S.	
A.G.L. / SHELL PIPELINES	
SYDNEY WATER	
TELSTRA / OPTUS	
AUSGRID	
NOTICE OF ENTRY	
KERB & GUTTER	
NOTICES	
DATE	
















COORDINATE SYSTEM	MG2020		
SCALES (ORIGINAL A1)			
AS SHOWN			
REV.	DATE	DESCRIPTION	APPROV.

SMITH STREET, SUMMER HILL
AT LACKEY STREET/MORRIS STREET INTERSECTION
PROPOSED STREETScape WORKS
DETAILS (2 of 2)

PROJECT NO.	303083	SHEET NO.	13 of 15
PLAN NO.			
		10218	
SHEET REF #			

FOR CONSTRUCTION

LINEMARKING SPECIFICATIONS

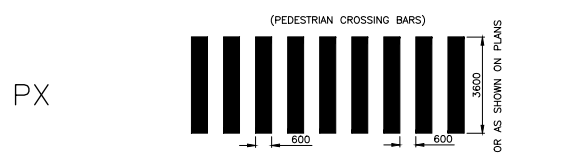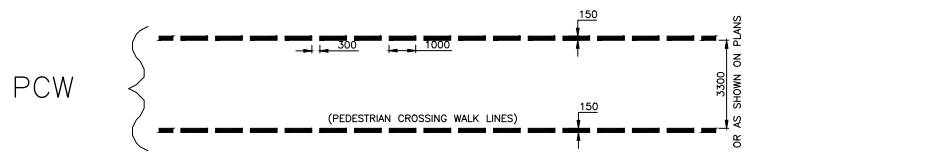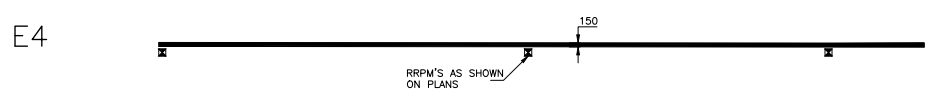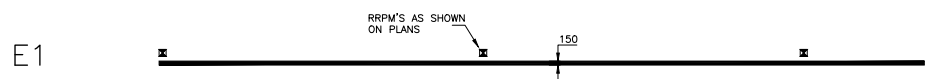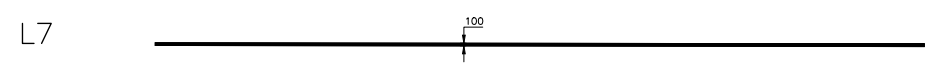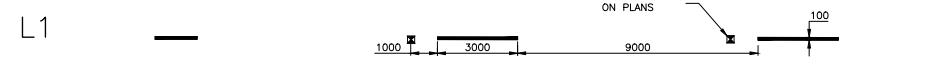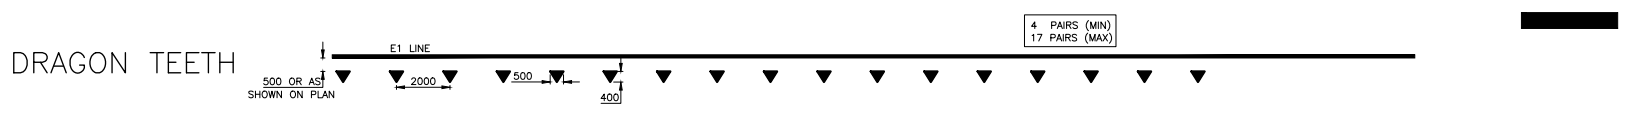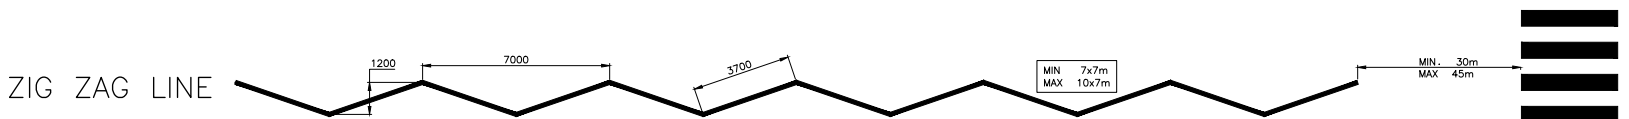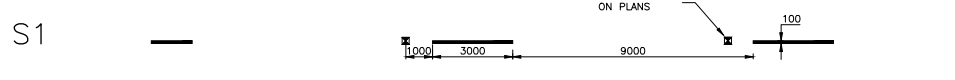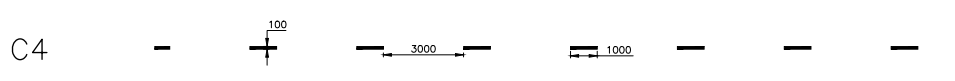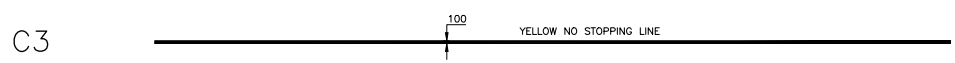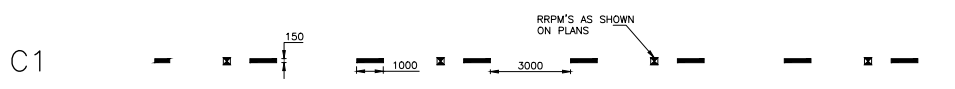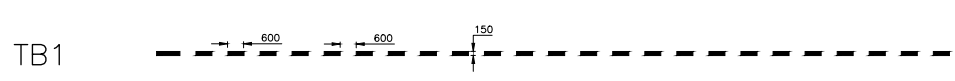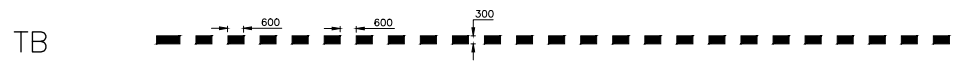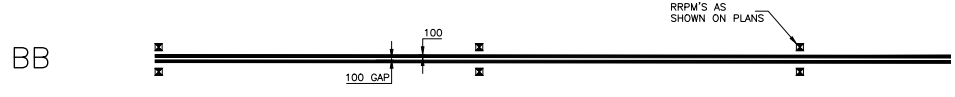


LINEMARKING

- ALL NEW LINEMARKING TO BE IN THERMOPLASTIC.
- LINEMARKING TO COMPLY AS 1742.13-2009 (PARA 4.66)
- ENSURE PRIMER APPLICATION TO THE CONCRETE SURFACE PRIOR

FOR CONSTRUCTION

CHECKED & APPROVED	SURVEYED BY ADAM DILLON 01-07-2022	INNER WEST	SURY. GEN. R.M.S. A.G.L. / SHELL PIPELINES SYDNEY WATER TELSTRA / OPTUS AUSGRID	COORDINATE SYSTEM ##### N.A.	PROJECT NO. 303083	SHEET NO. 14 of 15
	DESIGNED BY ASHFAQ AHMAD 19-09-2022					
APPROVED FOR CONSTRUCTION	DRAWN BY ASHFAQ AHMAD 19-09-2022	2-14 FISHER STREET, PETERSHAM NSW 2049 Ph. 02 9392 5000 P.O. Box 14 PETERSHAM council@innerwest.nsw.gov.au https://www.innerwest.nsw.gov.au	DATE	SCALE (ORIGINAL A1)	PLAN NO. 10218	SHEET REV #

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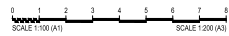


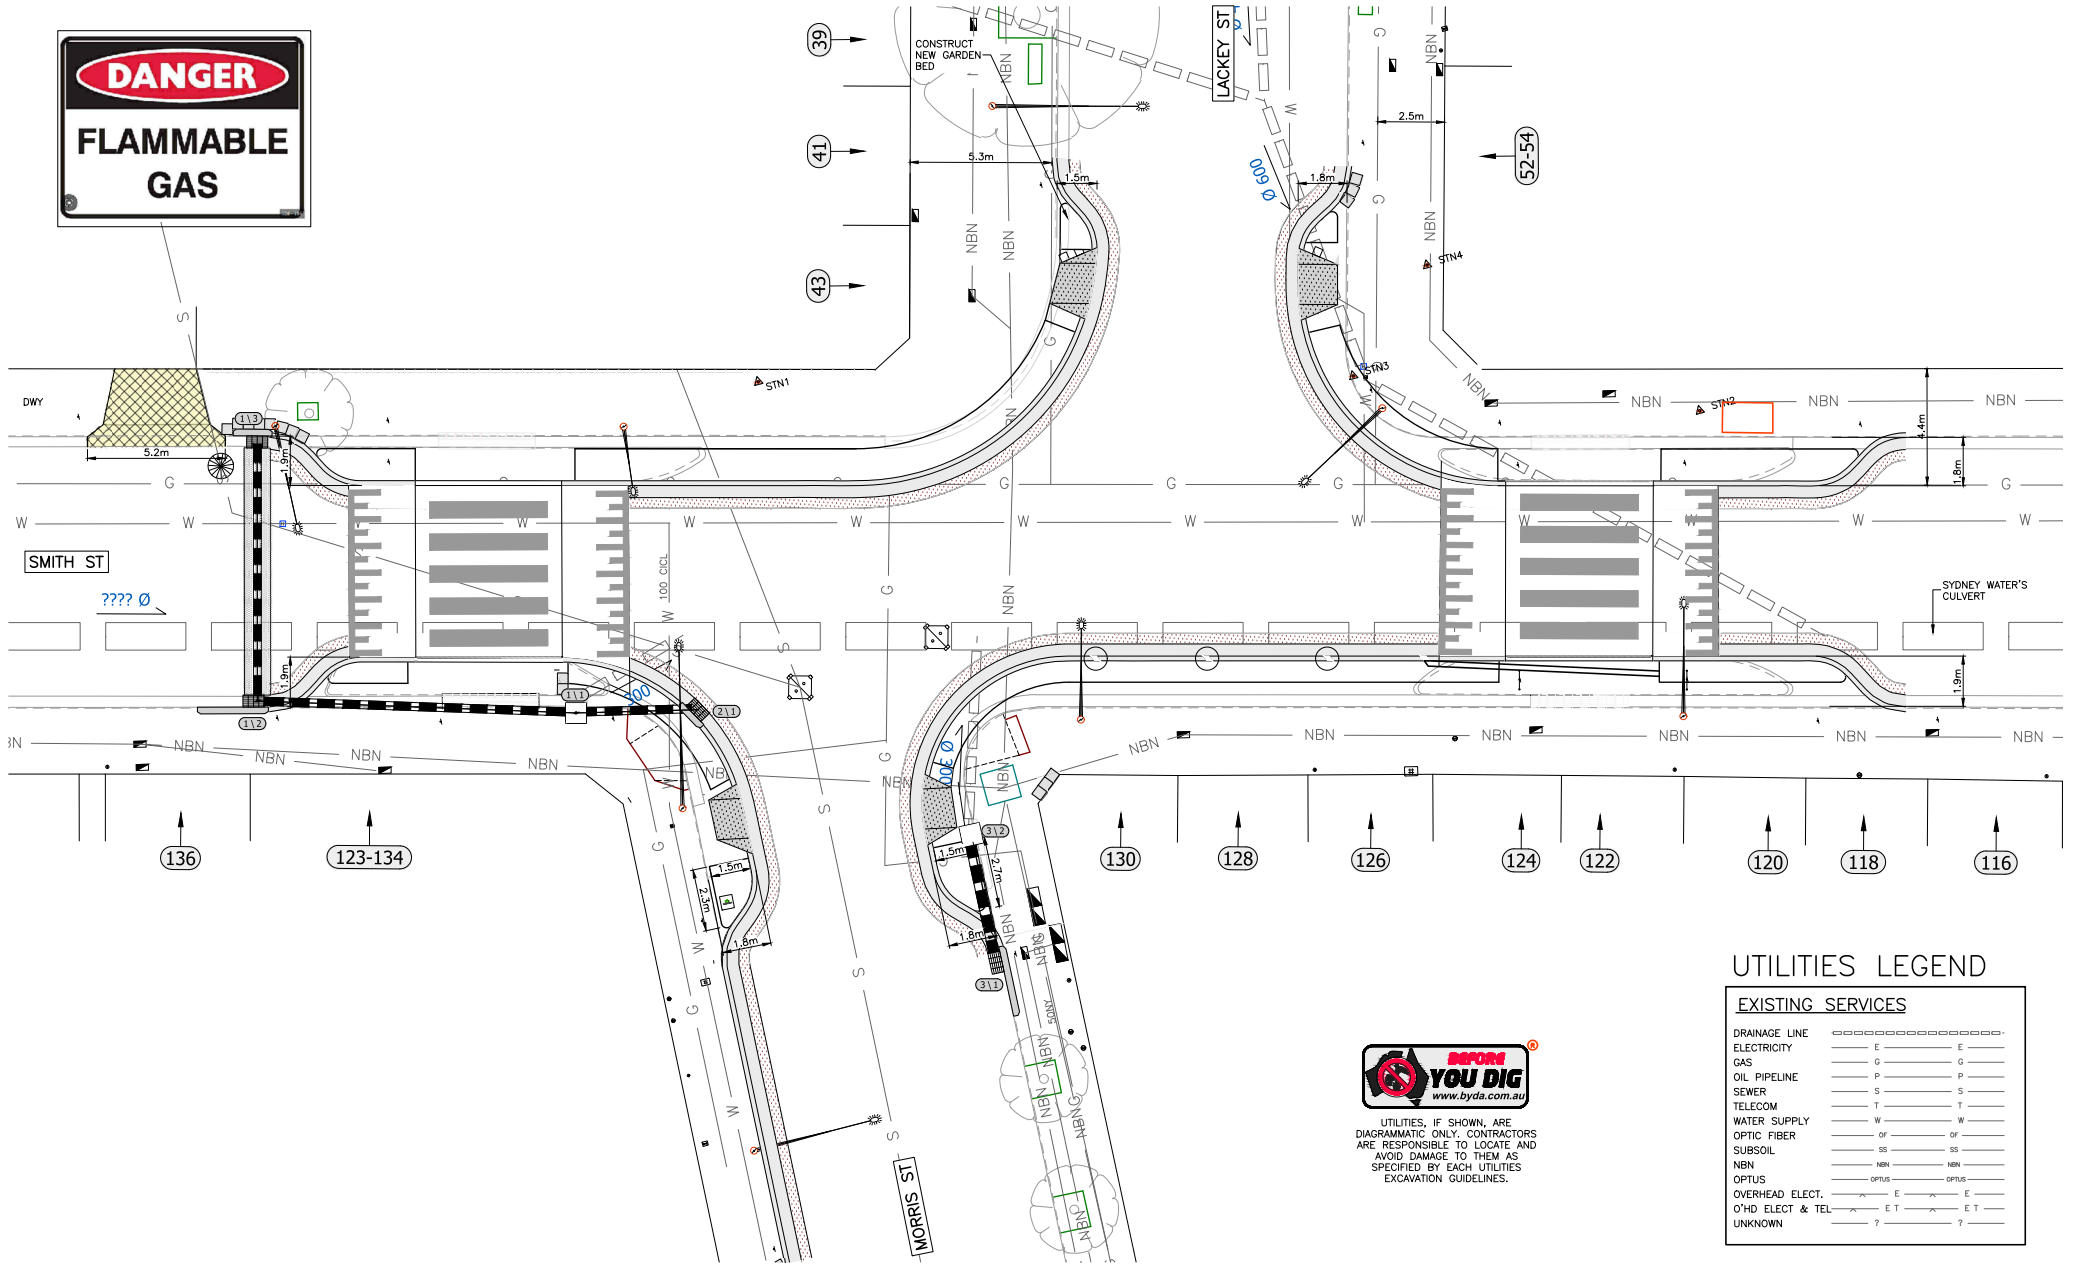UTILITIES LEGEND

EXISTING SERVICES		
DRAINAGE LINE	=====	=====
ELECTRICITY	— E —	— E —
GAS	— G —	— G —
OIL PIPELINE	— P —	— P —
SEWER	— S —	— S —
TELECOM	— T —	— T —
WATER SUPPLY	— W —	— W —
OPTIC FIBER	— OF —	— OF —
SUBSOIL	— SS —	— SS —
NBN	— NBN —	— NBN —
OPTUS	— OPTUS —	— OPTUS —
OVERHEAD ELECT.	— E —	— E —
O'HD ELECT & TEL	— E T —	— E T —
UNKNOWN	— ? —	— ? —



UTILITIES, IF SHOWN, ARE DIAGRAMMATIC ONLY. CONTRACTORS ARE RESPONSIBLE TO LOCATE AND AVOID DAMAGE TO THEM AS SPECIFIED BY EACH UTILITIES EXCAVATION GUIDELINES.



5 UNDERGROUND UTILITIES PLAN Scale: 1:100

FOR CONSTRUCTION

CHECKED & APPROVED
Ashfaq Ahmad
 19/4/23
 APPROVED FOR CONSTRUCTION
Ashfaq Ahmad
 19/4/23

INNER WEST
 2-14 FISHER STREET, PETERSHAM NSW 2049
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SURV. GEN.	COORDINATE SYSTEM	REV.	DATE	DESCRIPTION	APPROV.
R.M.S.	MTA2020				
A.G.L. / SHELL PIPELINES					
SYDNEY WATER	SCALES (ORIGINAL A1)				
TELSTRA / OPTUS	1:100				
AUSGRID					
NOTICE OF ENTRY					
KERB & GUTTER					
NOTICES					

SMITH STREET, SUMMER HILL
 AT LACKEY STREET/MORRIS STREET INTERSECTION
 PROPOSED STREETScape WORKS
 UNDERGROUND UTILITIES PLAN

PROJECT NO.	SHEET NO.
303083	15 of 15
PLAN NO.	10218
SHEET REV #	